


CURTIS WATER TREATMENT PLANT IMPROVEMENTS

NEW CASTLE COUNTY, DELAWARE
APRIL 2017 - CONSTRUCTION PLANS


CONTRACT NO.: 17-05
PWSID: 0000630

PREPARED FOR:
CITY OF NEWARK
DEPT. OF PUBLIC WORKS AND WATER RESOURCES

220 SOUTH MAIN STREET
NEWARK, DELAWARE 19711
(302) 366-7000

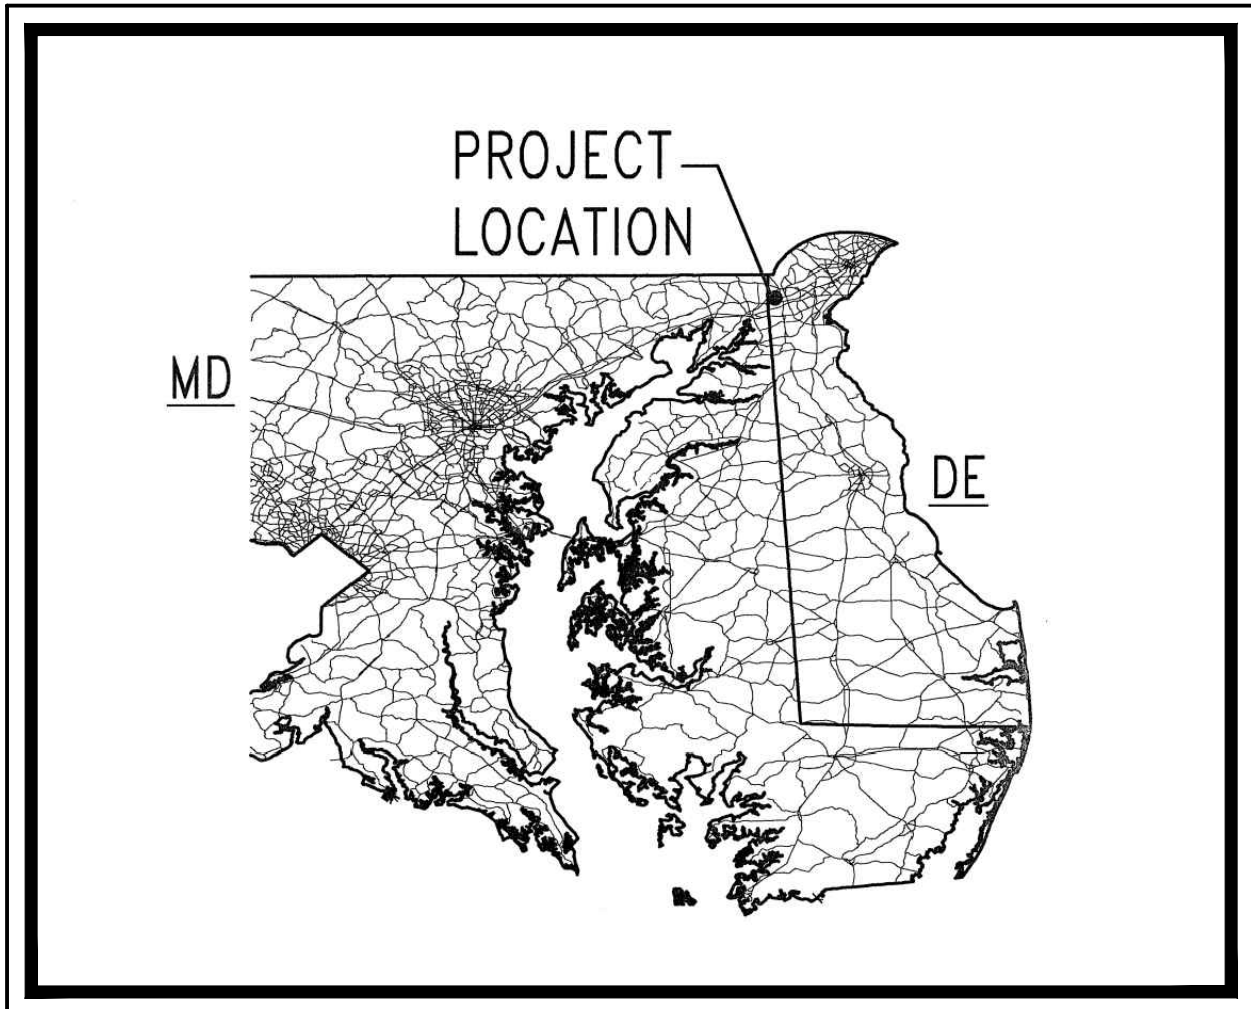


LOCATION MAP
Scale: NTS

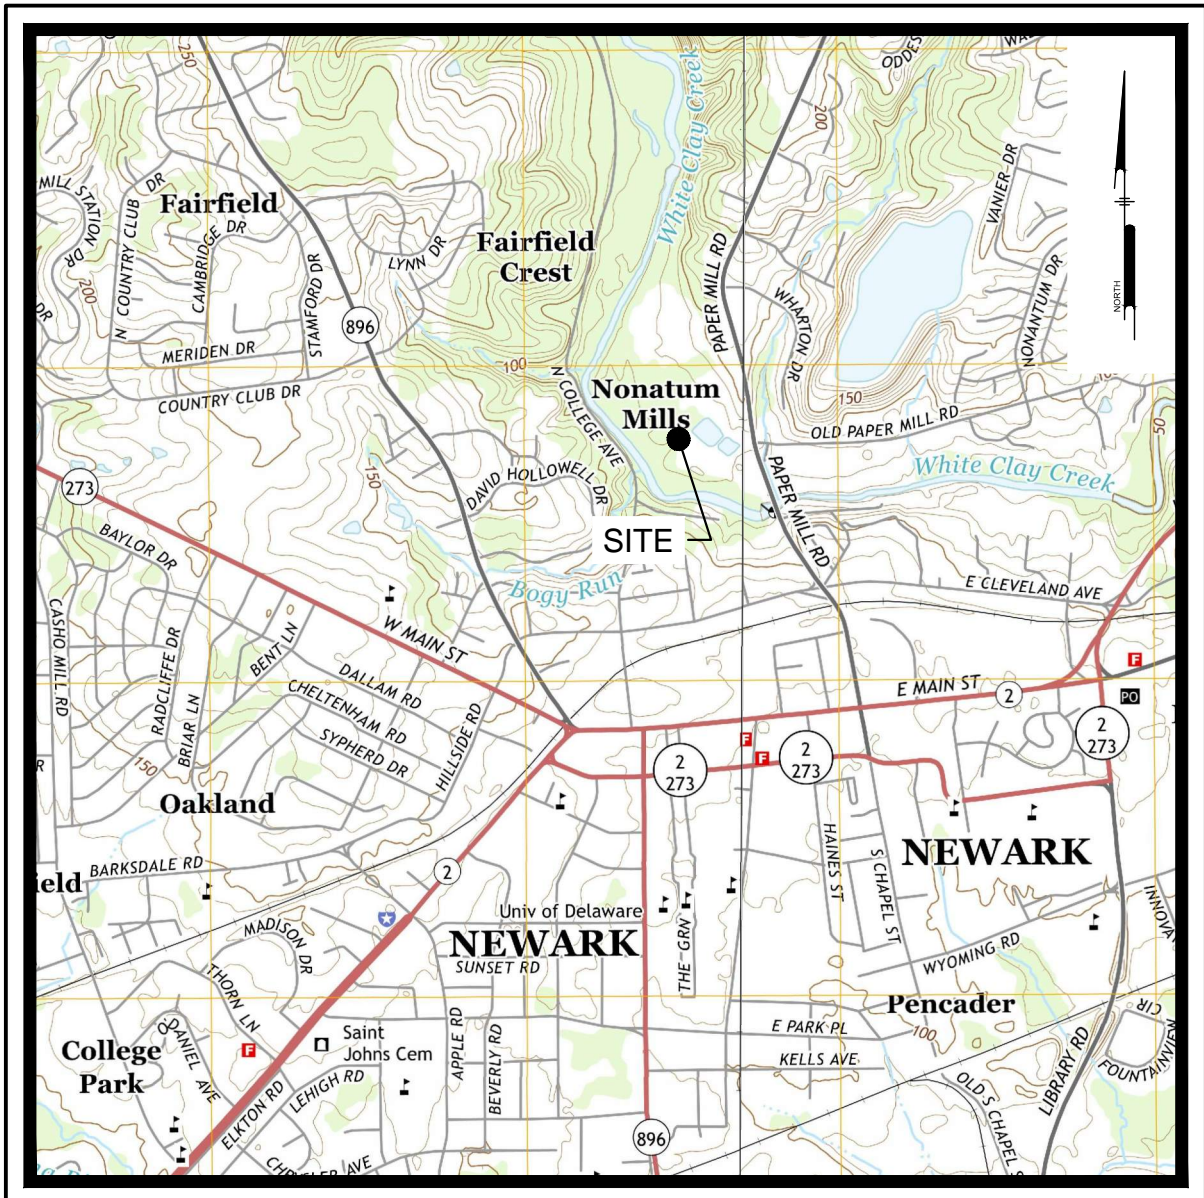

USGS MAP
Scale: 1" = 2000'

PREPARED BY:
PENNONI ASSOCIATES INC.

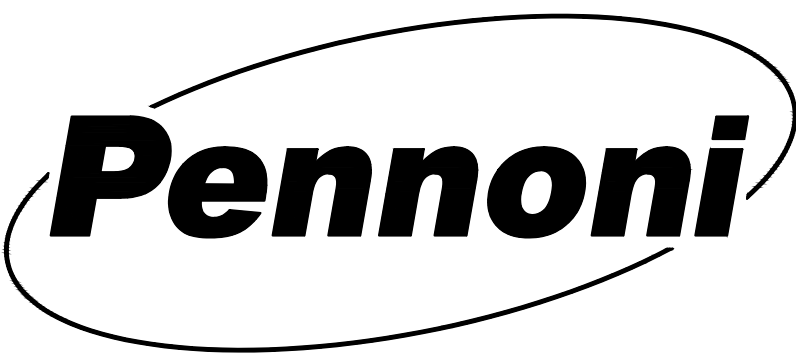

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CURTIS WATER TREATMENT PLANT
IMPROVEMENTS
215 PAPER MILL ROAD
NEWARK, DELAWARE
COVER SHEET

CITY OF NEWARK DEPT. OF PUBLIC WORKS AND WATER RESOURCES
220 SOUTH MAIN STREET
NEWARK, DELAWARE 19711

NO.	DATE	REVISIONS	BY

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PROJECT	CNEW1612
DATE	APRIL 2017
DRAWING SCALE	AS SHOWN
DRAWN BY	MWF
APPROVED BY	DPB

G0001
SHEET 1 OF 54

50TH

Pennoni

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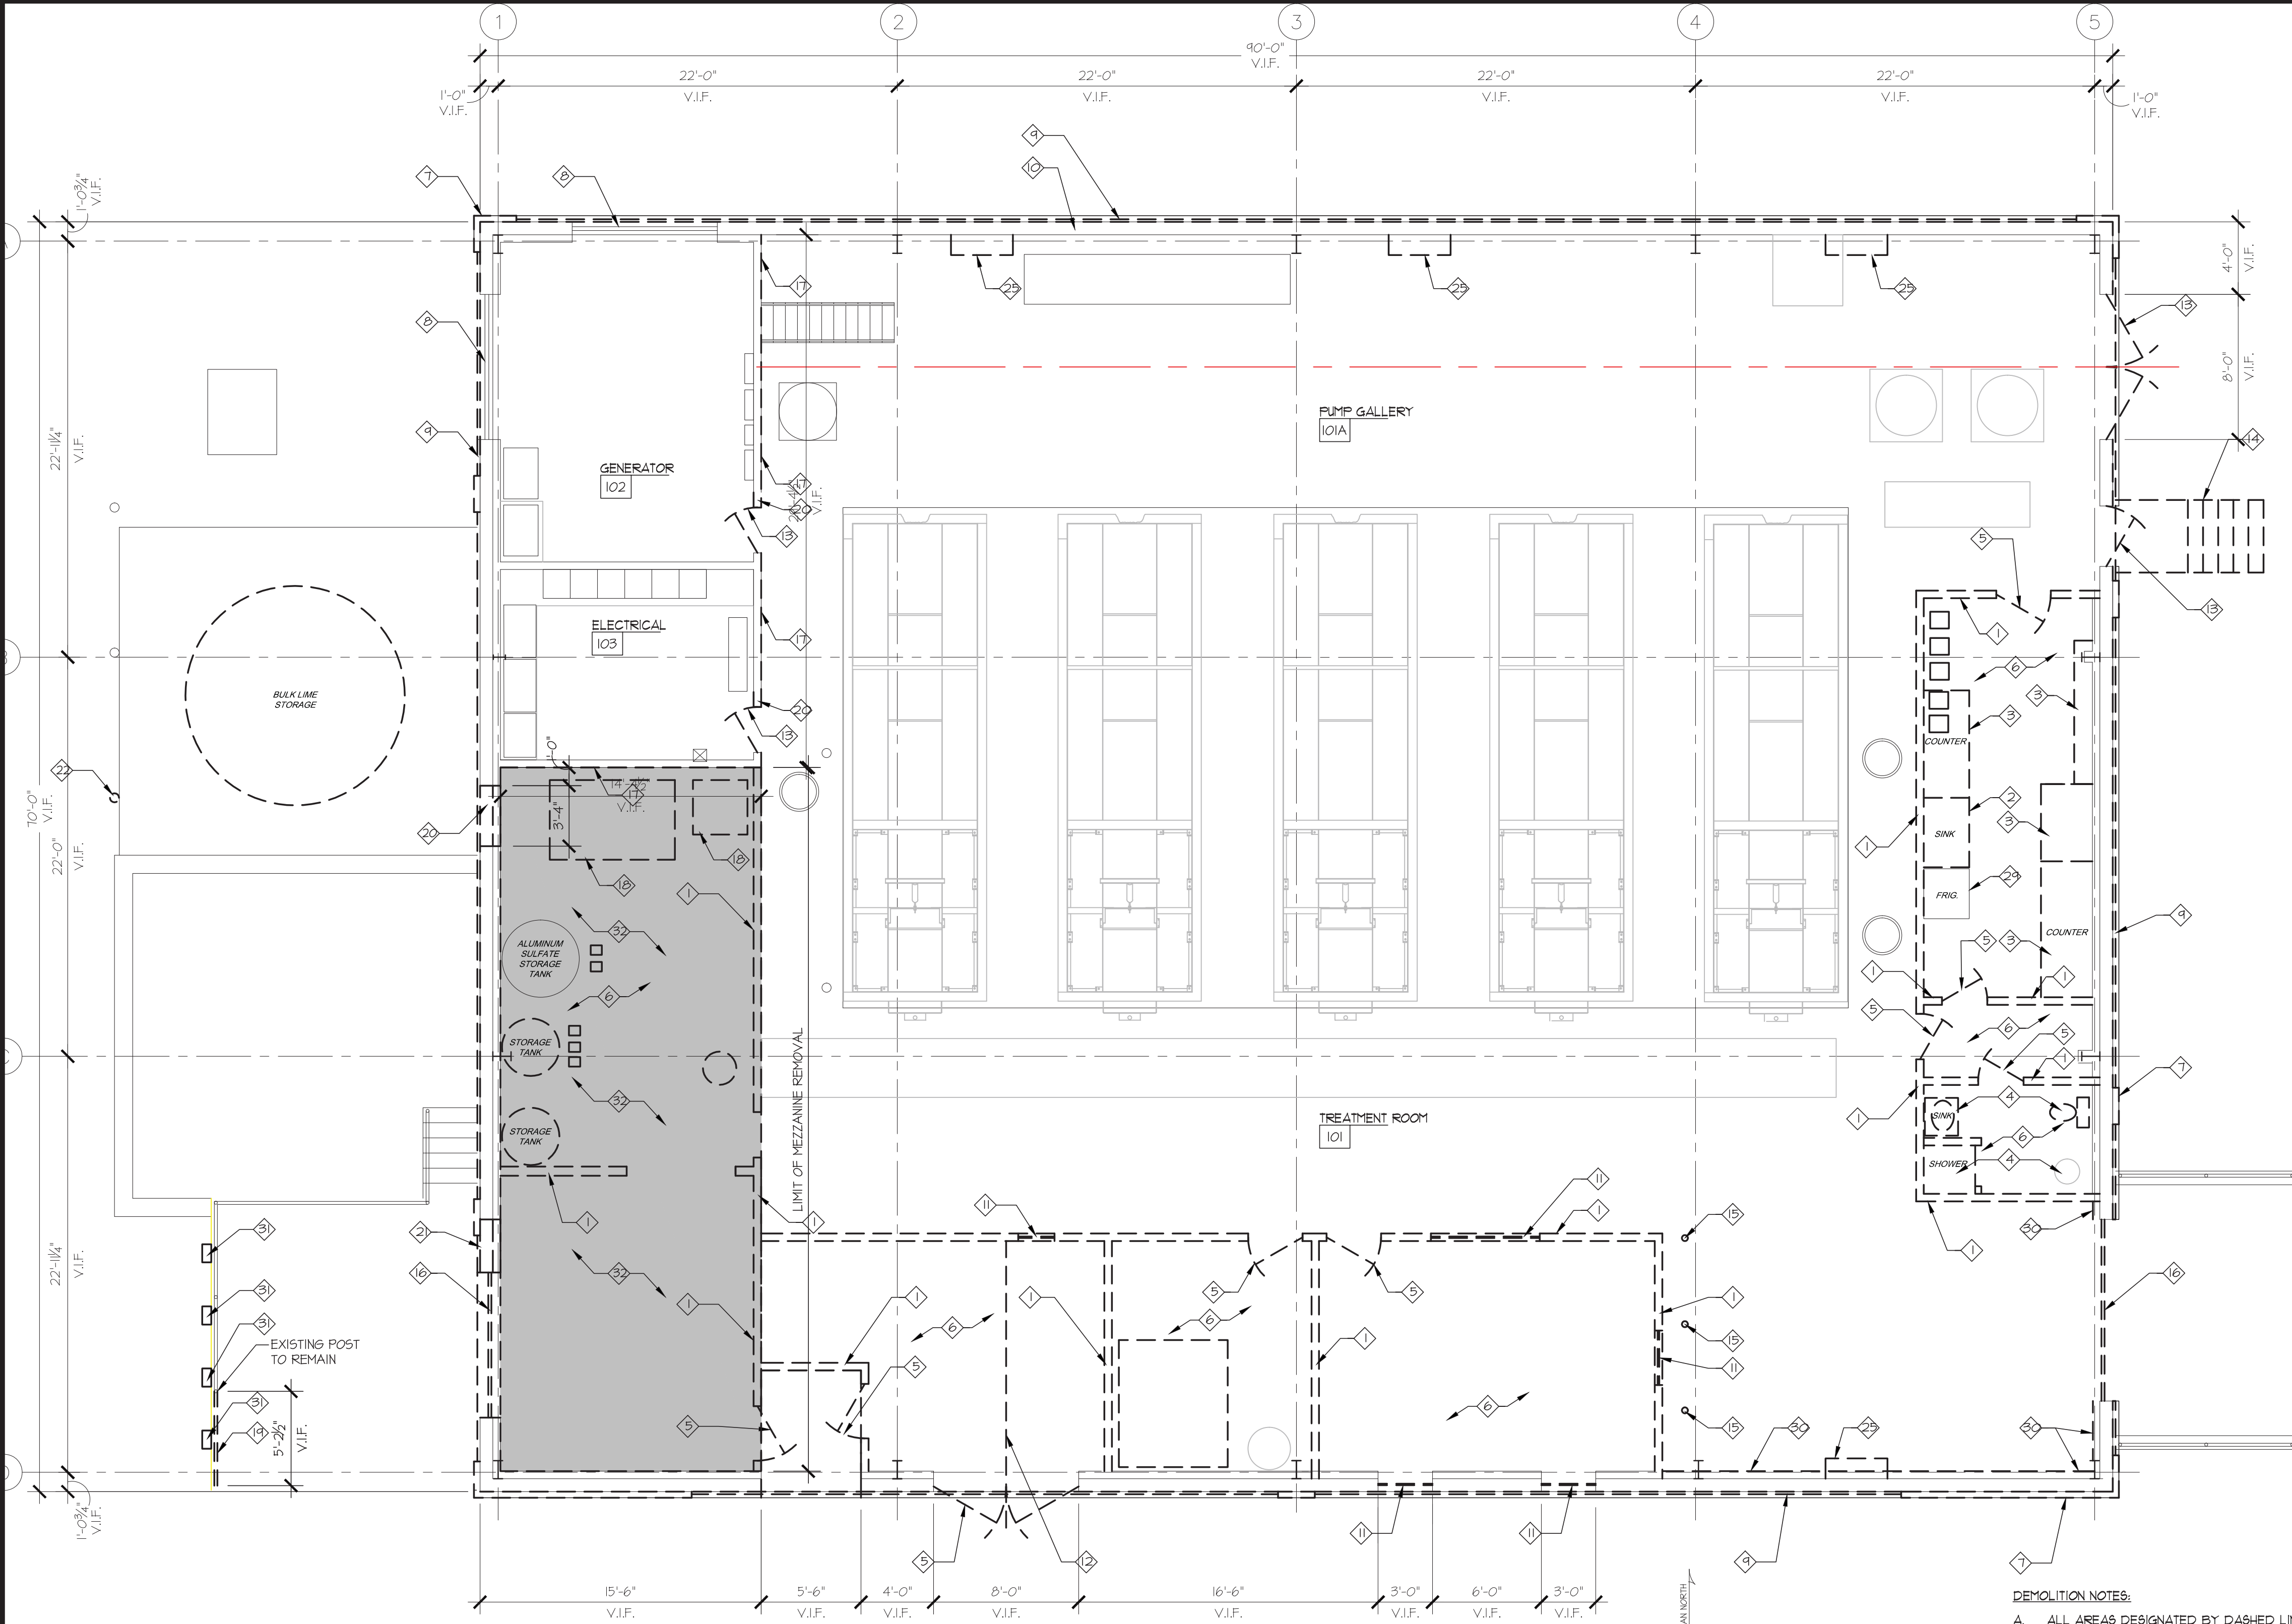
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11/17/2017




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PROJECT STATUS: CONSTRUCTION PLANS
PLOT STYLE: RGAR.DWG
PLOTTED: 4/25/2017 3:18 PM BY: Brian Miller
\\projects\cnew\cnew\1610 Code WTP Improvements\DESIGN\161001_RGArchitects.dwg



1 DEMOLITION PLAN
SCALE: 3/16" = 1'-0"

DEMOLITION KEY:

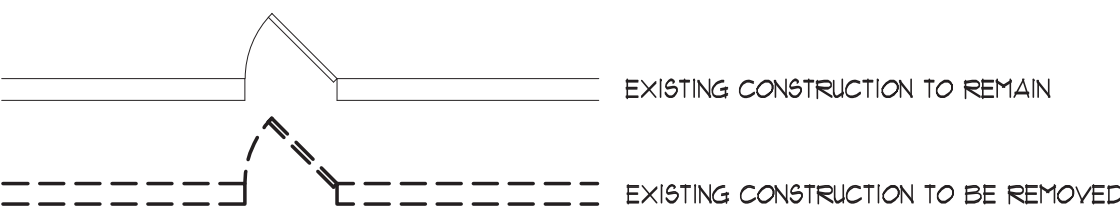


DEMOLITION KEY NOTES:

- 1 REMOVE EXISTING PARTITIONS SHOWN DASHED AND REPAIR/PATCH EXISTING WALL NOTED TO REMAIN IN PREPARATION FOR NEW FINISH.
- 2 REMOVE EXISTING PLUMBING FIXTURES & CASEWORK. SEE NOTE #4 FOR ADDITIONAL INFO.
- 3 REMOVE EXISTING CASEWORK REPAIR/PATCH EXISTING WALLS NOTED TO REMAIN AS REQUIRED FOR PREPERATION OF NEW FINISH.
- 4 REMOVE EXISTING PLUMBING FIXTURES AND CAP PLUMBING LINES AS REQUIRED. SEE PLUMBING DRAWINGS FOR ADDITIONAL INFORMATION.
- 5 REMOVE EXISTING DOOR/FRAME AND HARDWARE.
- 6 REMOVE EXISTING CEILING AND ANY ABANDONED CEILINGS THAT MAY BE ABOVE THE EXPOSED CEILING TO BE DEMOLISHED.
- 7 REMOVE EXISTING SPLIT FACE BLOCK VENEER DOWN TO FIRST FLOOR FINISH FLOOR ELEVATION, TYP. AT ALL LOCATIONS. REFER TO ELEVATIONS FOR ADDITIONAL INFORMATION
- 8 EXISTING LOUVER TO REMAIN
- 9 REMOVE EXISTING METAL SIDING WALL PANELS AND ALL ASSOCIATED INSULATION IN ITS ENTIRETY
- 10 EXISTING STEEL GIRT TO REMAIN
- 11 REMOVE EXISTING WINDOWFRAME
- 12 REMOVE EXISTING 2 TON STEEL CRANE MONORAIL SYSTEM IN ITS ENTIRETY
- 13 REMOVE EXISTING DOOR/FRAME AND HARDWARE IN ITS ENTIRETY. PREP OPENING AS REQUIRED FOR NEW DOOR/FRAME & HARDWARE
- 14 REMOVE EXISTING EXTERIOR STAIR SYSTEM AND ASSOCIATED BELOW GRADE FOOTING IN ITS ENTIRETY
- 15 REMOVE EXISTING BOLLARD, PATCH & REPAIR EXISTING FLOOR AS REQUIRED
- 16 CAREFULLY REMOVE EXISTING OVERHEAD DOOR/FRAME AND HARDWARE IN ITS ENTIRETY. PREP OPENING AS REQUIRED FOR NEW DOOR FRAME & INSTALLATION OF EXISTING & HARDWARE
- 17 REMOVE EXISTING WALL FINISH DOWN TO EXISTING STUD FRAMING. PREP EXISTING FRAMING AS REQUIRED FOR INSTALLATION OF NEW FINISH SURFACE. COORDINATE WITH NEW WORK DRAWINGS/SPECIFICATIONS.
- 18 REMOVE EXISTING CONCRETE PAD TO BE FLUSH WITH ADJACENT CONCRETE SLAB FINISHED FLOOR
- 19 REMOVE PORTION OF EXISTING GUARDRAIL SYSTEM. GRIND SMOOTH SURFACE OF POST WHICH IS TO REMAIN
- 20 MODIFY EXISTING WALL FRAMING AS REQUIRED TO INSTALL NEW MAN DOOR. SEE SCHEDULE FOR SIZE.
- 21 REMOVE PORTION OF EXISTING EXTERIOR WALL. MODIFY EXISTING WALL FRAMING AS REQUIRED TO INSTALL NEW COILING OVERHEAD DOOR. SEE SCHEDULE FOR SIZE.
- 22 REMOVE EXISTING MTL. BOLLARD FLUSH TO GRADE
- 23 REMOVE EXISTING METAL ROOF SYSTEM & ASSOCIATED INSUL. IN ITS ENTIRETY
- 24 REMOVE EXISTING METAL GUTTER & DN. SPOUT IN ITS ENTIRETY
- 25 REMOVE EXISTING METAL LOUVER. SEE M/P/E DWGS. FOR ADDITIONAL INFO.
- 26 REMOVE EXISTING EXTERIOR LIGHTING FIXTURE. SEE ELEC. DWGS. FOR ADDITIONAL INFO.
- 27 REMOVE DAMAGED PORTION OF SPLIT-FACE CMU VENEER. SEE ADDITIONAL NOTE ON D103 REGARDING REMOVAL/SALVAGE/REINSTALLATION
- 28 REMOVE EXISTING LOOSE CONCRETE PAVING. PREP. SURFACE AS REQUIRED FOR NEW PAVING
- 29 REMOVE & RELOCATE EXISTING REFRIGERATOR
- 30 REMOVE EXISTING INTERIOR METAL WALL PANEL, TYP.
- 31 REMOVE EXISTING RUBBER BUMPERS AND ASSOCIATED MOUNTING HARDWARE
- 32 EXISTING FLOOR/FRAMING FOR AREA OF MEZZANINE ABOVE TO BE REMOVED IN ITS ENTIRETY. SUPPORT EXISTING MEZZANINE AREA TO REMAIN AS REQUIRED. COORDINATE WITH NEW WORK PLANS AND STRUCTURAL DRAWINGS FOR ADDITIONAL INFORMATION

DEMOLITION NOTES:

- ALL AREAS DESIGNATED BY DASHED LINES ARE TO BE REMOVED. THE CONTRACTOR SHALL VERIFY THESE CONDITIONS PRIOR TO THE COMMENCEMENT OF WORK.
- ALL AREAS AND PARTITIONS NOT DASHED OR NOTED TO BE REMOVED SHALL REMAIN IN TACT. PATCH AND REPAIR EXISTING PARTITIONS AS REQUIRED AFTER DEMOLITION TO MATCH EXISTING OR IN ACCORDANCE WITH PROPOSED RENOVATIONS.
- PROVIDE INTERIOR AND EXTERIOR SHORING, BRACING, OR OTHER SUPPORT TO PREVENT MOVEMENT, SETTLEMENT, OR COLLAPSE OF ELEMENTS TO BE DEMOLISHED AND ADJACENT EXISTING ELEMENTS TO REMAIN.
- PROVIDE TEMPORARY WEATHER PROTECTION DURING INTERVAL BETWEEN DEMOLITION AND INSTALLATION OF NEW CONSTRUCTION TO ENSURE THAT WATER LEAKAGE DOES NOT DAMAGE THE STRUCTURE.
- LOCATE AND IDENTIFY EXISTING UTILITIES, INCLUDING SANITARY SEWER SYSTEM, AND ASCERTAIN THEIR CONDITION TO ENSURE ADEQUATE PERFORMANCE OF ALL UTILITIES IN NEW CONSTRUCTION. PROTECT UTILITY LINES AND HARDWARE DURING DEMOLITION AND CONSTRUCTION PHASES.
- DEMOLISH CONCRETE AND MASONRY WALLS IN SMALL SECTIONS. CUT CONCRETE AND MASONRY AT JUNCTURES WITH OTHER ELEMENTS TO REMAIN BY USING POWER-DRIVEN MASONRY SAW OR HAND TOOLS. DO NOT USE POWER-DRIVEN IMPACT TOOLS.
- DISPERSE DEMOLITION EQUIPMENT THROUGHOUT STRUCTURE AND PROMPTLY REMOVE DEBRIS TO AVOID IMPOSING EXCESSIVE LOADS ON SUPPORTING WALLS, FLOORS, OR FRAMING.
- GENERAL CONTRACTOR IS RESPONSIBLE TO REMOVE FROM BUILDING SITE DEBRIS, TRASH, AND OTHER DISCARDED MATERIALS AND/OR EQUIPMENT RESULTING FROM DEMOLITION OPERATIONS. TRANSPORT AND LEGALLY DISPOSE OFF SITE.
- IF HAZARDOUS MATERIALS ARE ENCOUNTERED DURING DEMOLITION OPERATIONS, COMPLY WITH APPLICABLE REGULATIONS, LAWS, AND ORDINANCES CONCERNING REMOVAL, HANDLING, AND PROTECTION AGAINST EXPOSURE OR ENVIRONMENTAL POLLUTION.
- BURNING OF REMOVED MATERIALS IS NOT PERMITTED ON THE PROJECT SITE.
- COORDINATE ALL DEMOLITION WITH OWNER AND OTHER TRADES. CONFIRM THE EXTENT, TIMING, AND ITEMS TO BE SALVAGED WITH OWNER. CONTRACTOR SHALL SCHEDULE WORK SO AS NOT TO UNDESIRABLY INTERFERE WITH OWNER'S OPERATIONS.
- SEE M/P/E DRAWINGS FOR COORDINATION & FURTHER INFORMATION OF MECHANICAL AND ELECTRICAL DEMOLITION.

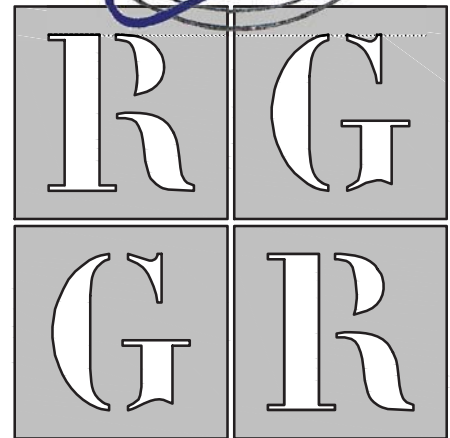

ARCHITECTS
R G Architects, LLC
200 West Main St., Middletown, DE 19709
302.376.8100 302.376.9851 fax
www.rgarchitects.net

0 1' 2' 4' 8'

FLOOR PLAN AND SECTION INFORMATION DERIVED FROM: CITY OF NEWARK, WATER TREATMENT FACILITIES PLANT, CONTRACT W-90-11 PREPARED BY TATMAN & LEE ASSOCIATES, INC. DATED 10/1/1990



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ALL DIMENSIONS MUST BE VERIFIED BY CONTRACTOR AND OWNER MUST BE NOTIFIED OF ANY DISCREPANCIES BEFORE PROCEEDING WITH WORK

CURTIS WATER TREATMENT PLANT IMPROVEMENTS

215 PAPER MILL ROAD
NEWARK, DELAWARE

FLOOR PLAN DEMOLITION

CITY OF NEWARK DEPT. OF PUBLIC WORKS AND WATER RESOURCES
220 SOUTH MAIN STREET
NEWARK, DELAWARE 19711

NO.	DATE	BY

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PROJECT	CNEW1612
DATE	APRIL 2017
DRAWING SCALE	AS SHOWN
DRAWN BY	MWF/BWM
APPROVED BY	DPB

D0501

PROJECT STATUS: CONSTRUCTION PLANS
PLOT: 14/2017 3:10 PM BY: Brian Miller
PROJECT: NEWARK WATER TREATMENT PLANT IMPROVEMENTS
DESIGN: 2016-05-02-002.dwg



DEMOLITION PLAN NOTES:


1. CONTRACTOR SHALL WORK WITH CARE TO VERIFY EXISTING UTILITIES, PIPES, CONDUITS, WIRES, AND EQUIPMENT ARE REMOVED, TERMINATED, OR SUPPORTED PRIOR TO REMOVAL OF THE WALLS AND CEILINGS OF THE INTERIOR ROOMS.
2. CONTRACTOR SHALL COORDINATE DEMOLITION WITH THE CITY FOR REMOVAL AND REUSE OF MATERIALS AND EQUIPMENT INCLUDING EXISTING MONITORING EQUIPMENT AND CHEMICAL PUMPS.
3. CONTRACTOR SHALL COORDINATE DEMOLITION WITH THE CITY TO LIMIT INTERRUPTION OF OPERATIONS ACTIVITY.
4. CLEAR WELL OPENINGS SHALL BE COVERED DURING DEMOLITION WORK.
5. WATER FILTER TANKS SHALL BE PROTECTED FROM DEBRIS AND DUST FROM CONSTRUCTION AT ALL TIMES USING CONTAINMENT CURTAINS OR TANK COVERS.
6. FLOOR DRAINS SHALL BE COVERED DURING DEMOLITION TO PREVENT DEBRIS FROM ENTERING THE SANITARY SEWER DRAIN PIPE.
7. WALL ANCHORS SET IN FLOOR SHALL BE CUT OR GROUND FLUSH TO THE FLOOR AND SEALED IN PLACE.
8. CONTRACTOR SHALL BE RESPONSIBLE FOR LAWFUL DISPOSAL OF REMOVED MATERIALS.

EQUIPMENT AND MATERIALS DEMOLITION

SCALE: 1/4" = 1'-0"

FLOOR PLAN AND SECTION INFORMATION DERIVED FROM: CITY OF NEWARK, WATER TREATMENT FACILITIES PLANT, CONTRACT W-90-11 PREPARED BY TATMAN & LEE ASSOCIATES, INC. DATED 10/1/1990

0 1' 2' 4' 8'

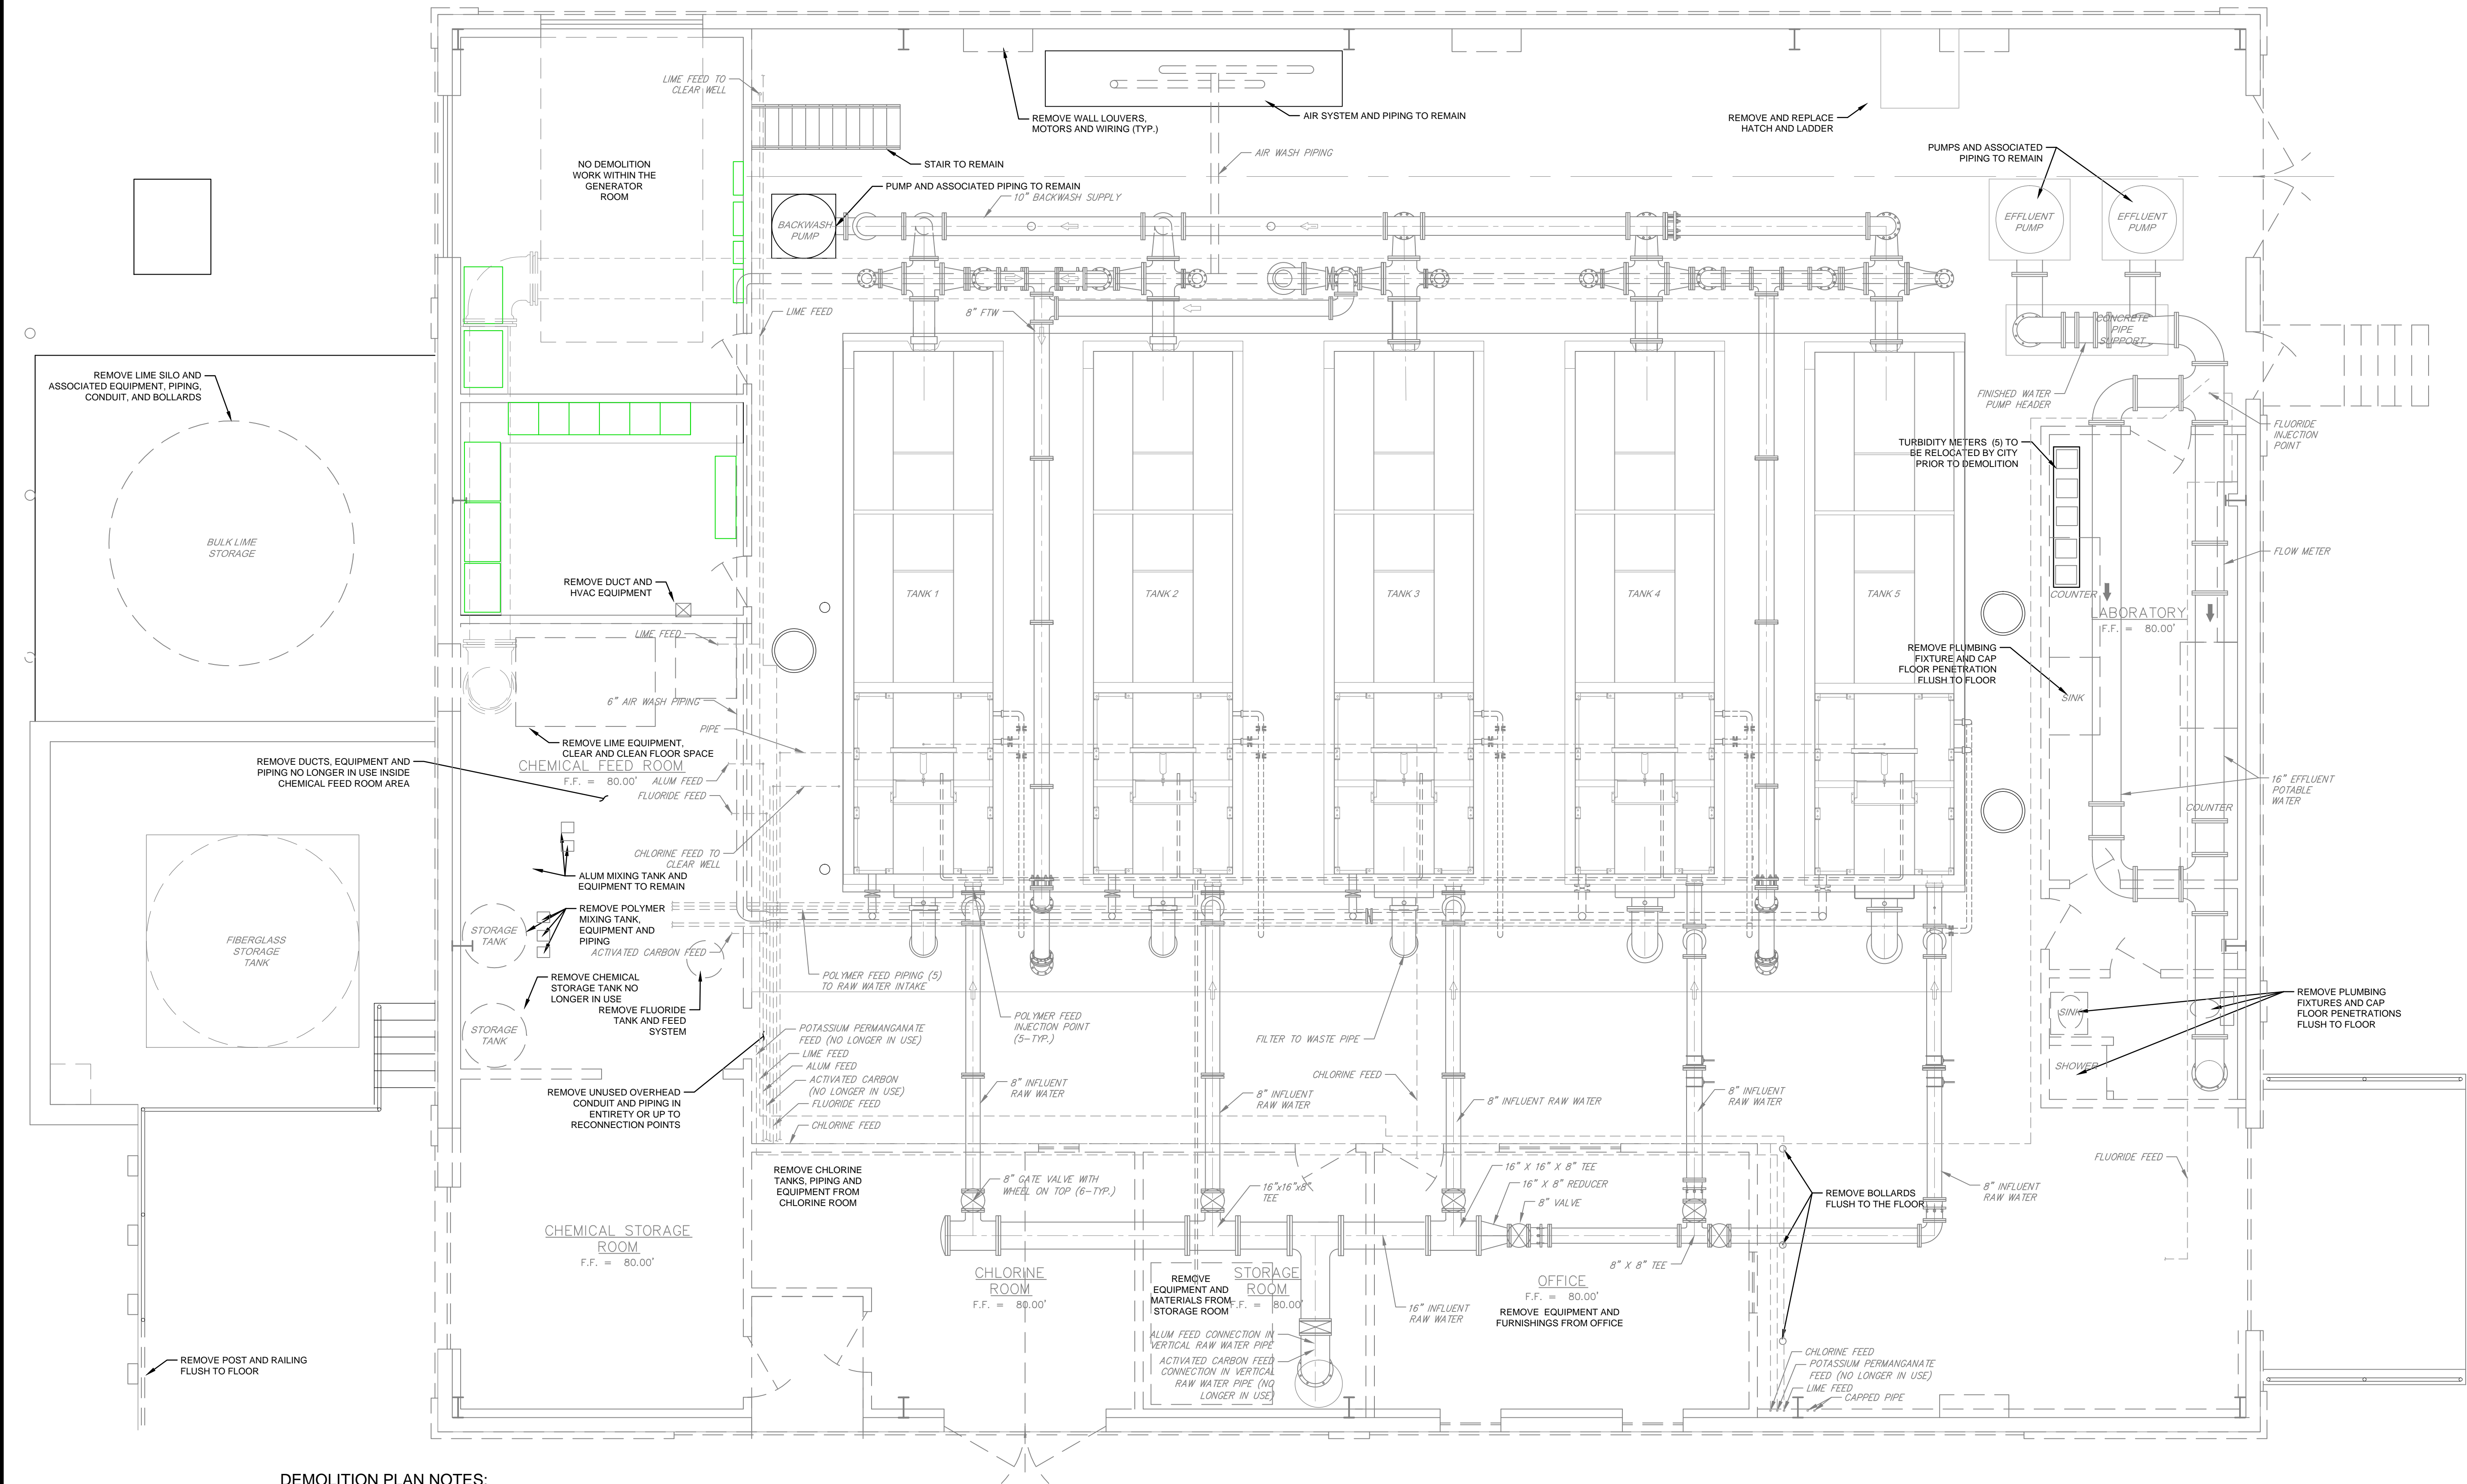

CURTIS WATER TREATMENT PLANT IMPROVEMENTS
EQUIPMENT AND MATERIALS DEMOLITION
CITY OF NEWARK DEPT. OF PUBLIC WORKS AND WATER RESOURCES
215 PAPER MILL ROAD
NEWARK, DELAWARE
220 SOUTH MAIN STREET
NEWARK, DELAWARE 19711

NO.	DATE	REVISIONS	BY

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PROJECT: CNEW1612
DATE: APRIL 2017
DRAWING SCALE: AS SHOWN
DRAWN BY: MWF/BWM
APPROVED BY: ---


D0502
SHEET 3 OF 54

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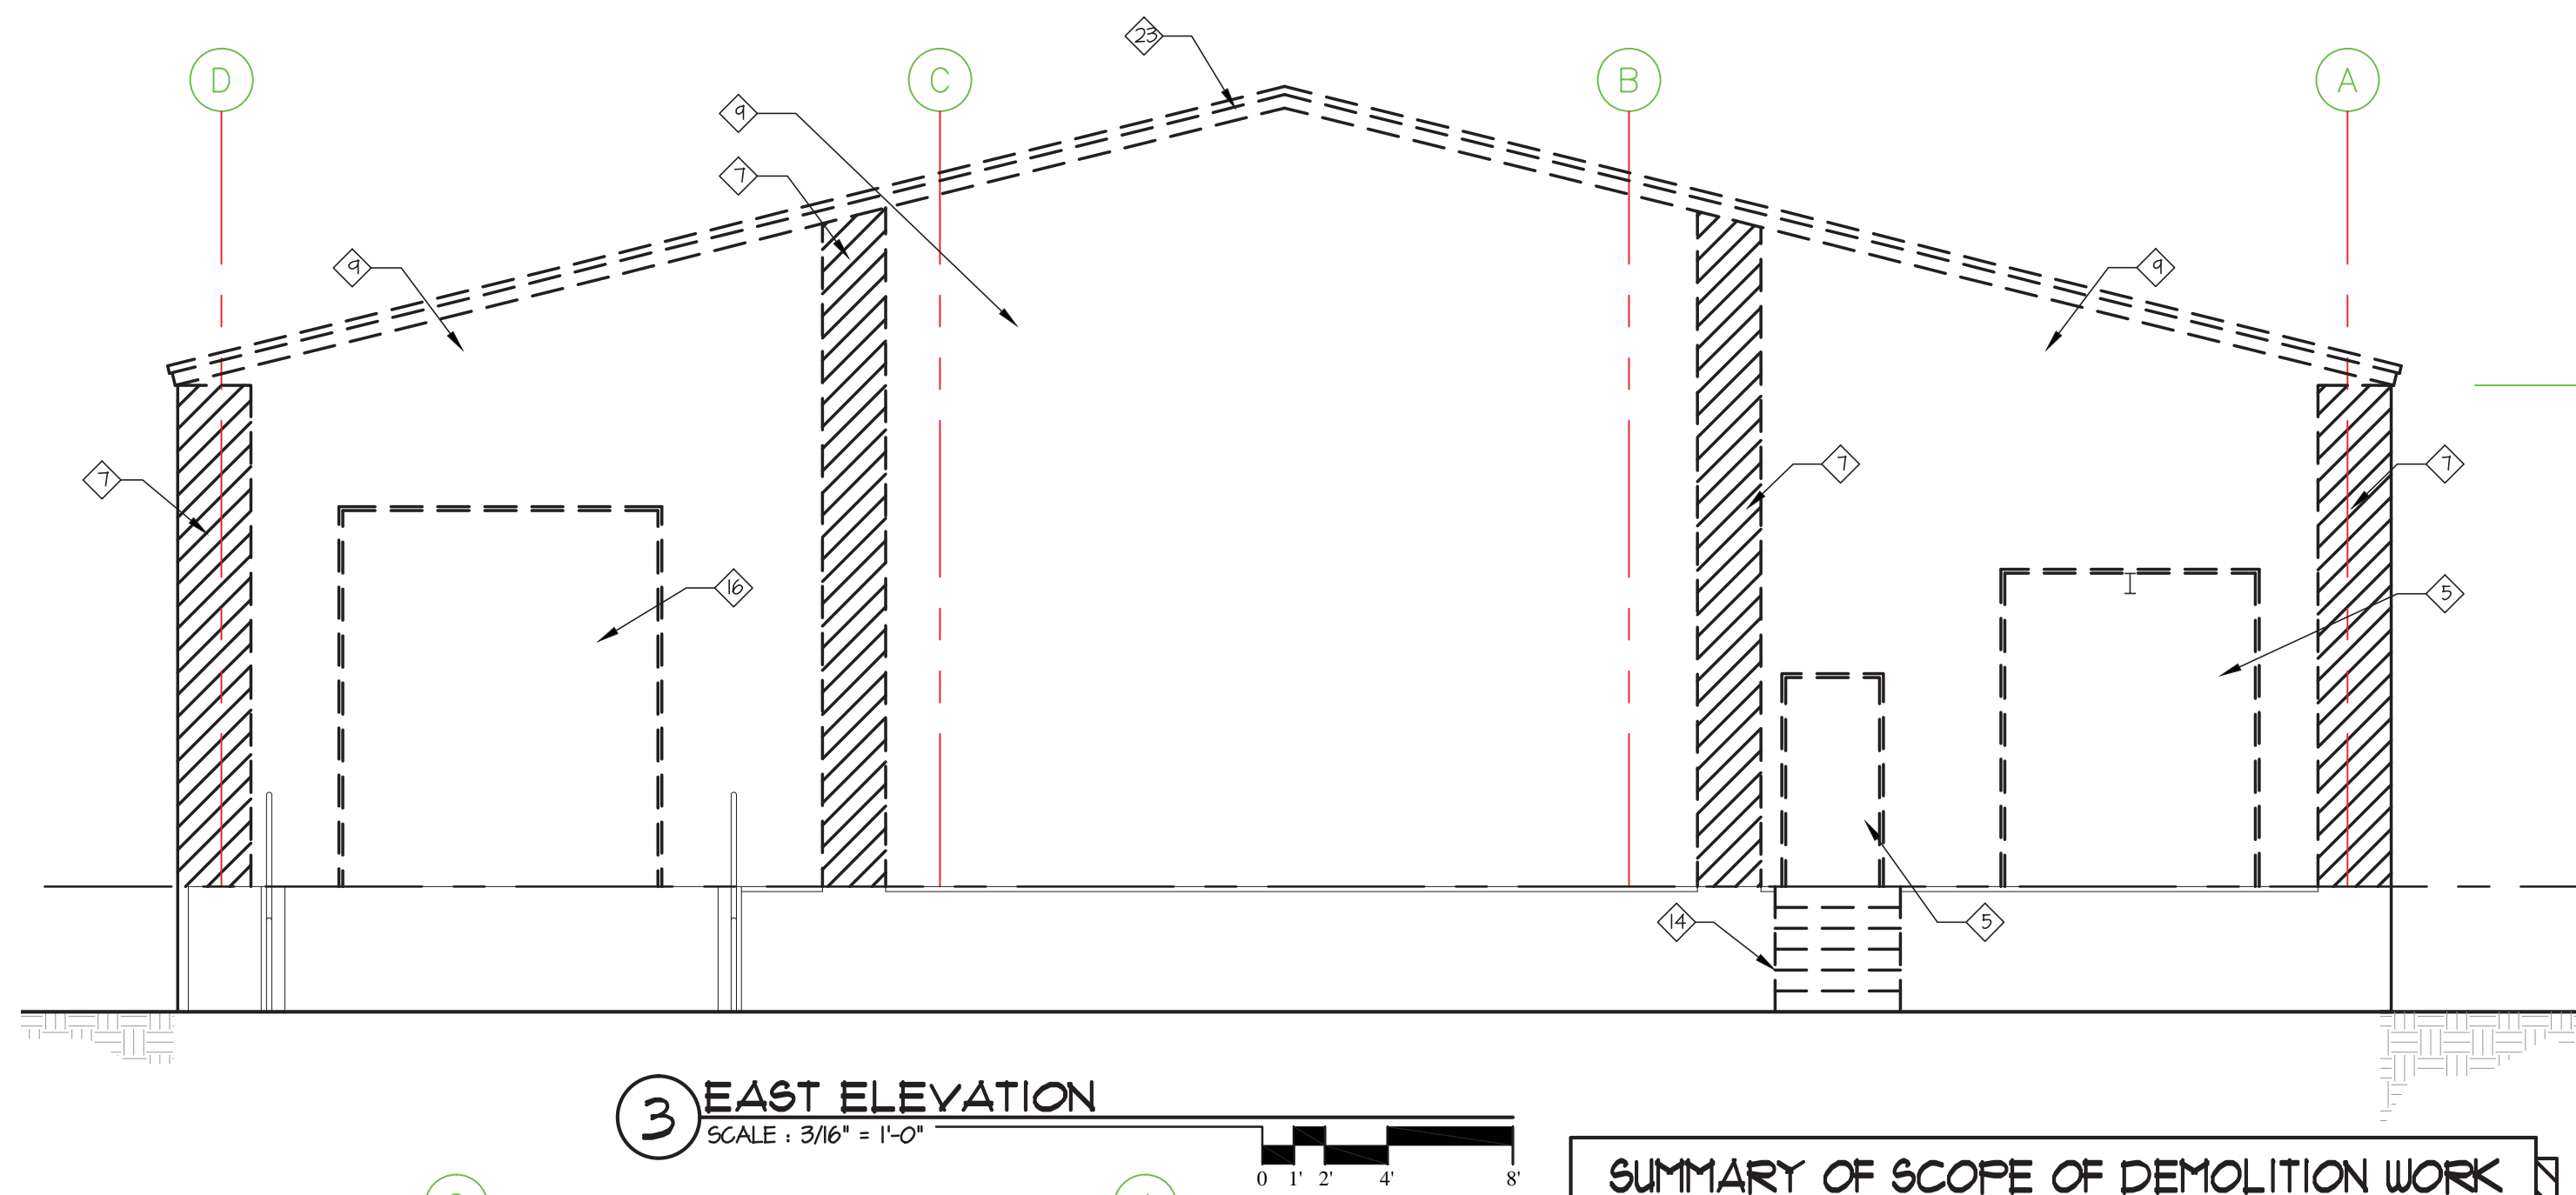


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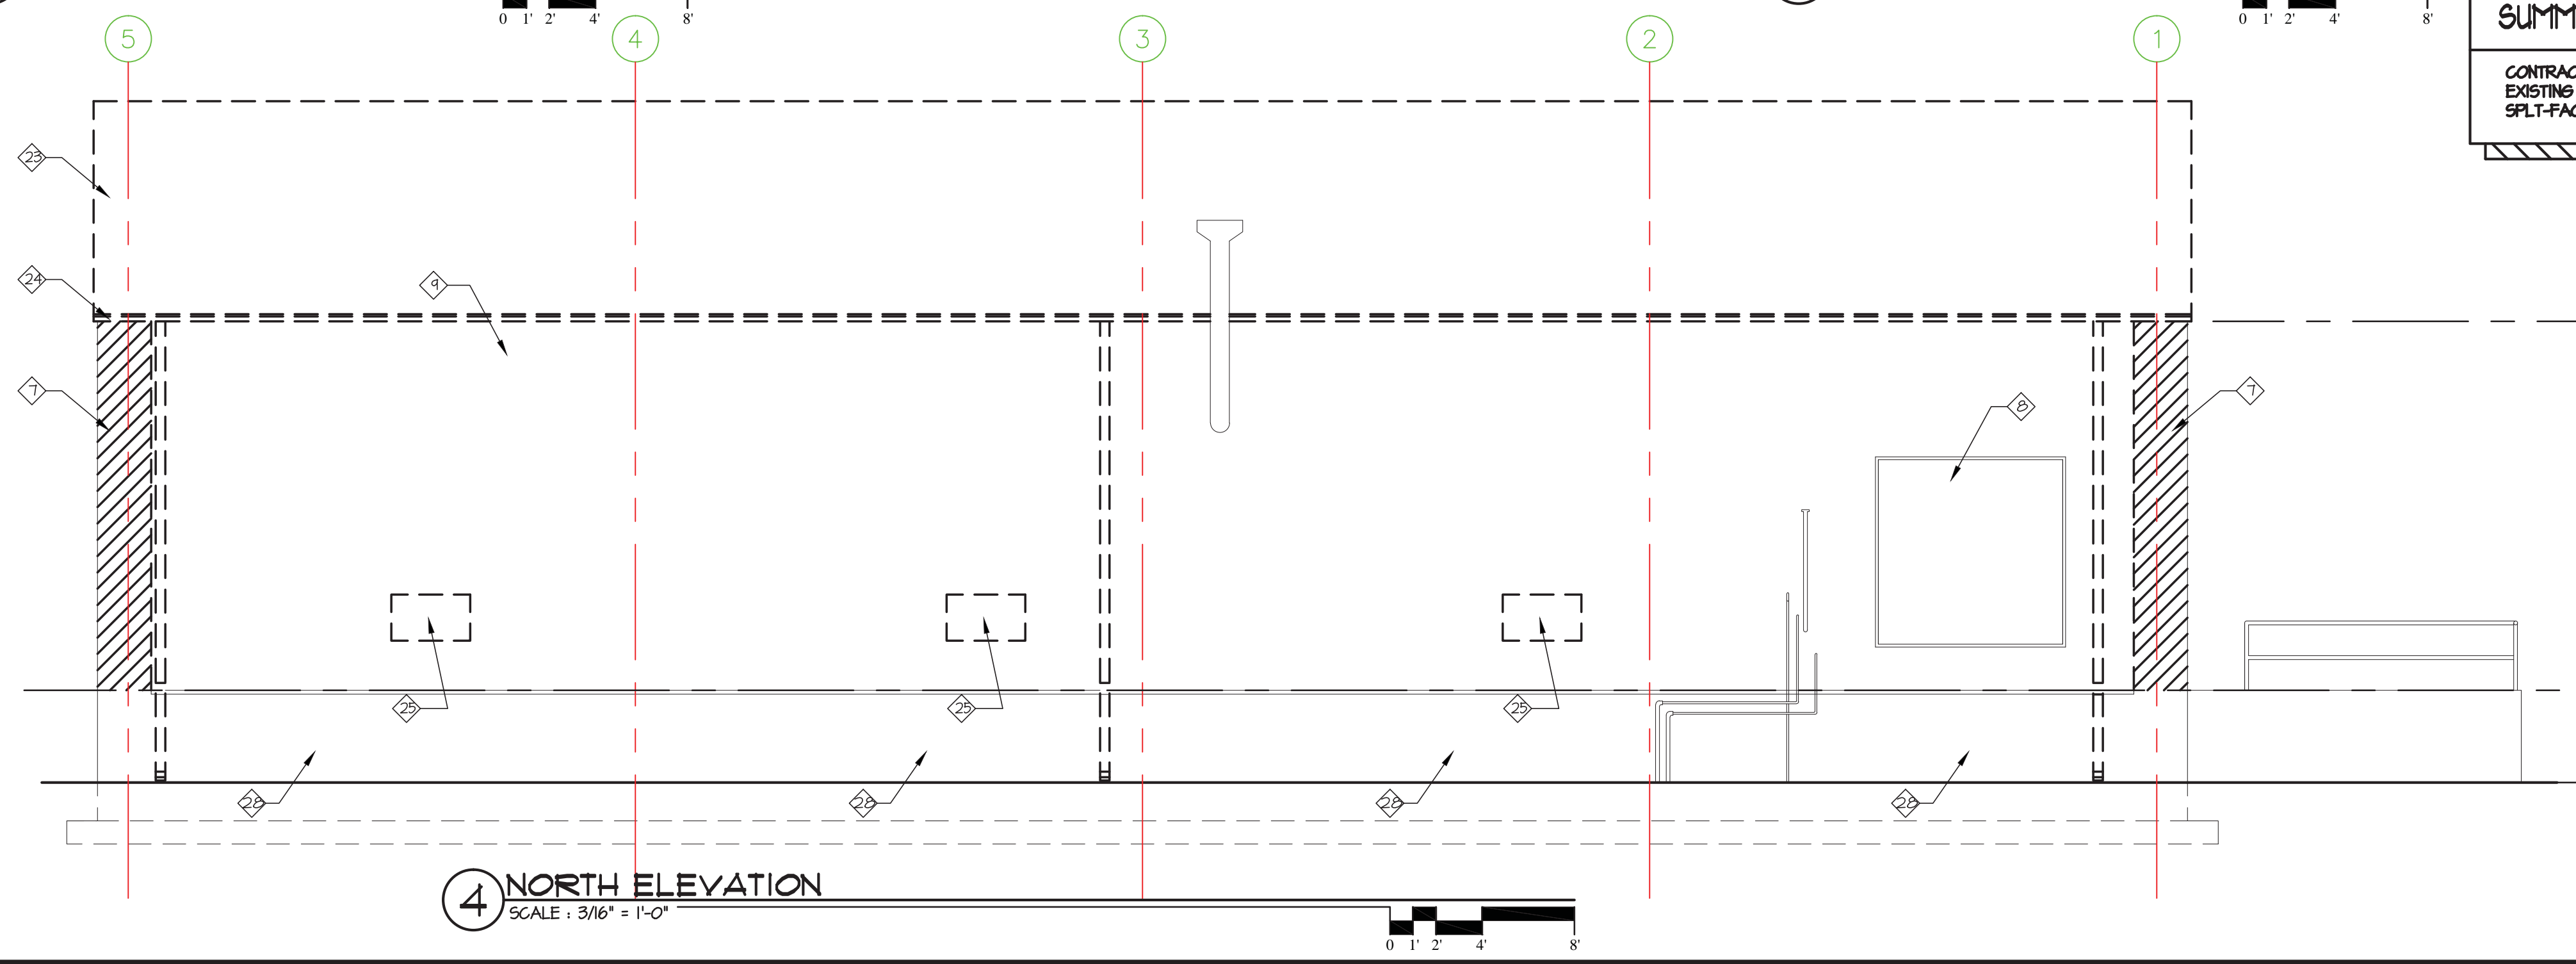
PROJECT STATUS: CONSTRUCTION PLANS
PLOTTED: 4/28/2017 2:30 PM BY: Peter Miller
PLOT STYLE: RGArch.dwg
\\projects\cnew\cnew161\cnew161.dwg
PROJECT: CNEW161
DATE: 4/28/2017
TIME: 2:30 PM
BY: Peter Miller
PLOT STYLE: RGArch.dwg



2 WEST ELEVATION
SCALE: 3/16" = 1'-0"

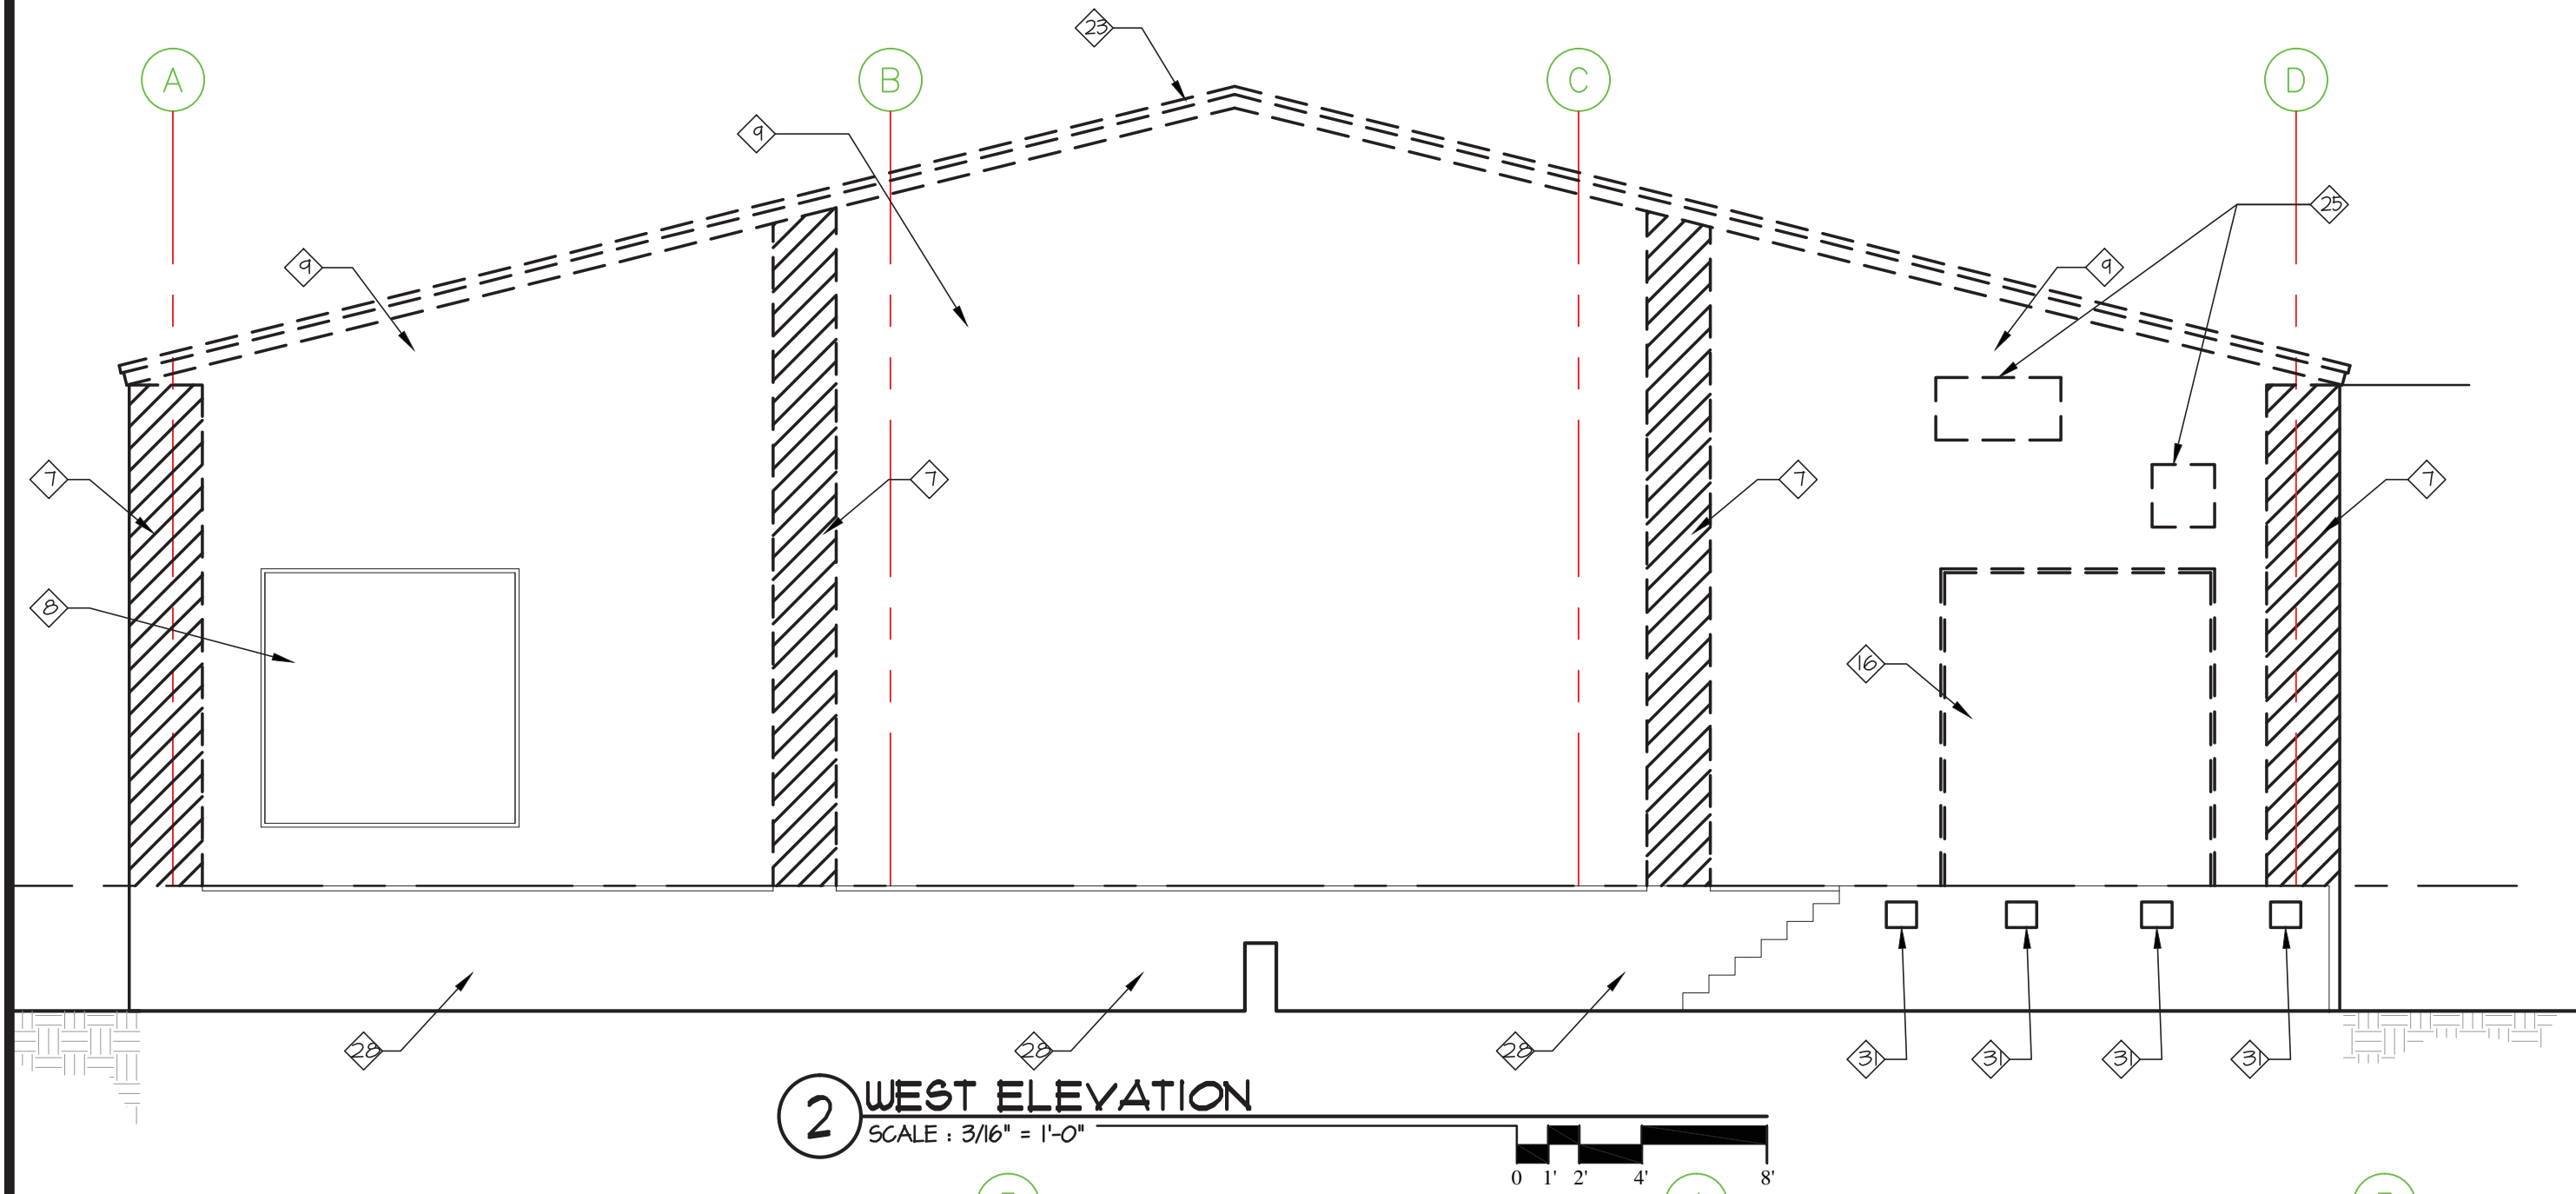

3 EAST ELEVATION
SCALE: 3/16" = 1'-0"



4 NORTH ELEVATION
SCALE: 3/16" = 1'-0"

DEMOLITION KEY NOTES


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- 16 CAREFULLY REMOVE EXISTING OVERHEAD DOOR FRAME AND HARDWARE IN ITS ENTIRETY. PREP OPENING AS REQUIRED FOR NEW DOOR FRAME & INSTALLATION OF EXISTING HARDWARE.
- 23 REMOVE EXISTING METAL ROOF SYSTEM & ASSOCIATED INSUL. IN ITS ENTIRETY.
- 24 REMOVE EXISTING METAL GUTTER & DN SPOUT IN ITS ENTIRETY.
- 25 REMOVE EXISTING METAL LOUVER, SEE M/P/E DWGS. FOR ADDITIONAL INFO.
- 26 REMOVE EXISTING EXTERIOR LIGHTING FIXTURE, SEE ELEC. DWGS. FOR ADDITIONAL INFO.
- 27 REMOVE DAMAGED PORTION OF SPLIT-FACE CMU VENEER, SEE ADDITIONAL NOTE ON D1103 REGARDING REMOVAL/SALVAGE/REINSTALLATION.
- 28 REMOVE EXISTING LOOSE CONCRETE PARING. PREP SURFACE AS REQUIRED FOR NEW PARING.
- 31 REMOVE EXISTING RUBBER BUMPERS AND ASSOCIATED MOUNTING HARDWARE.

EXISTING CMU VENEER

CONTRACTOR SHALL SALVAGE, CLEAN & REPAIR SUFFICIENT QUANTITY OF EXISTING CMU IN ORDER TO PATCH & REPLACE DAMAGED SECTIONS OF SPLIT-FACE CMU VENEER AS INDICATED.

SUMMARY OF SCOPE OF DEMOLITION WORK

CONTRACTOR SHALL SALVAGE, CLEAN & REPAIR SUFFICIENT QUANTITY OF EXISTING CMU IN ORDER TO PATCH & REPLACE DAMAGED SECTIONS OF SPLIT-FACE CMU VENEER AS INDICATED.

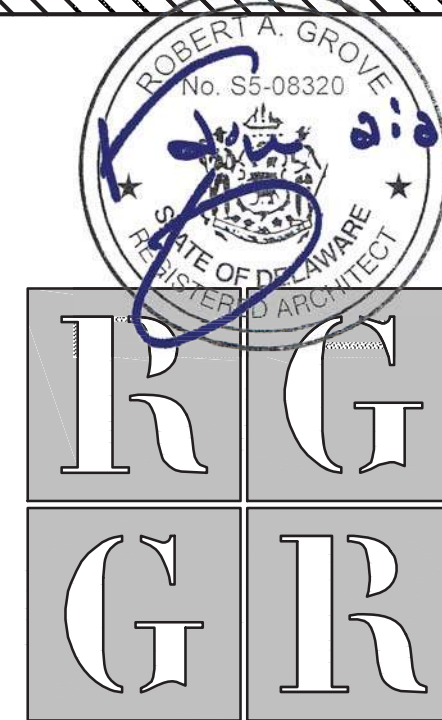

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FLOOR PLAN AND SECTION INFORMATION DERIVED FROM: CITY OF NEWARK, WATER TREATMENT FACILITIES PLANT, CONTRACT W-90-11 PREPARED BY TATMAN & LEE ASSOCIATES, INC. DATED 10/1/1990

CURTIS WATER TREATMENT PLANT IMPROVEMENTS
215 PAPER MILL ROAD
NEWARK, DELAWARE
ELEVATIONS DEMOLITION
CITY OF NEWARK DEPT. OF PUBLIC WORKS AND WATER RESOURCES
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PROJECT: CNEW1612
DATE: APRIL 2017
DRAWING SCALE: AS SHOWN
DRAWN BY: RG ARCHITECTS
APPROVED BY: RG ARCHITECTS

D0503

SHEET 4 OF 54

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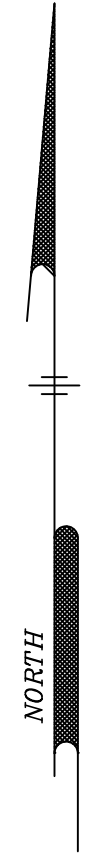
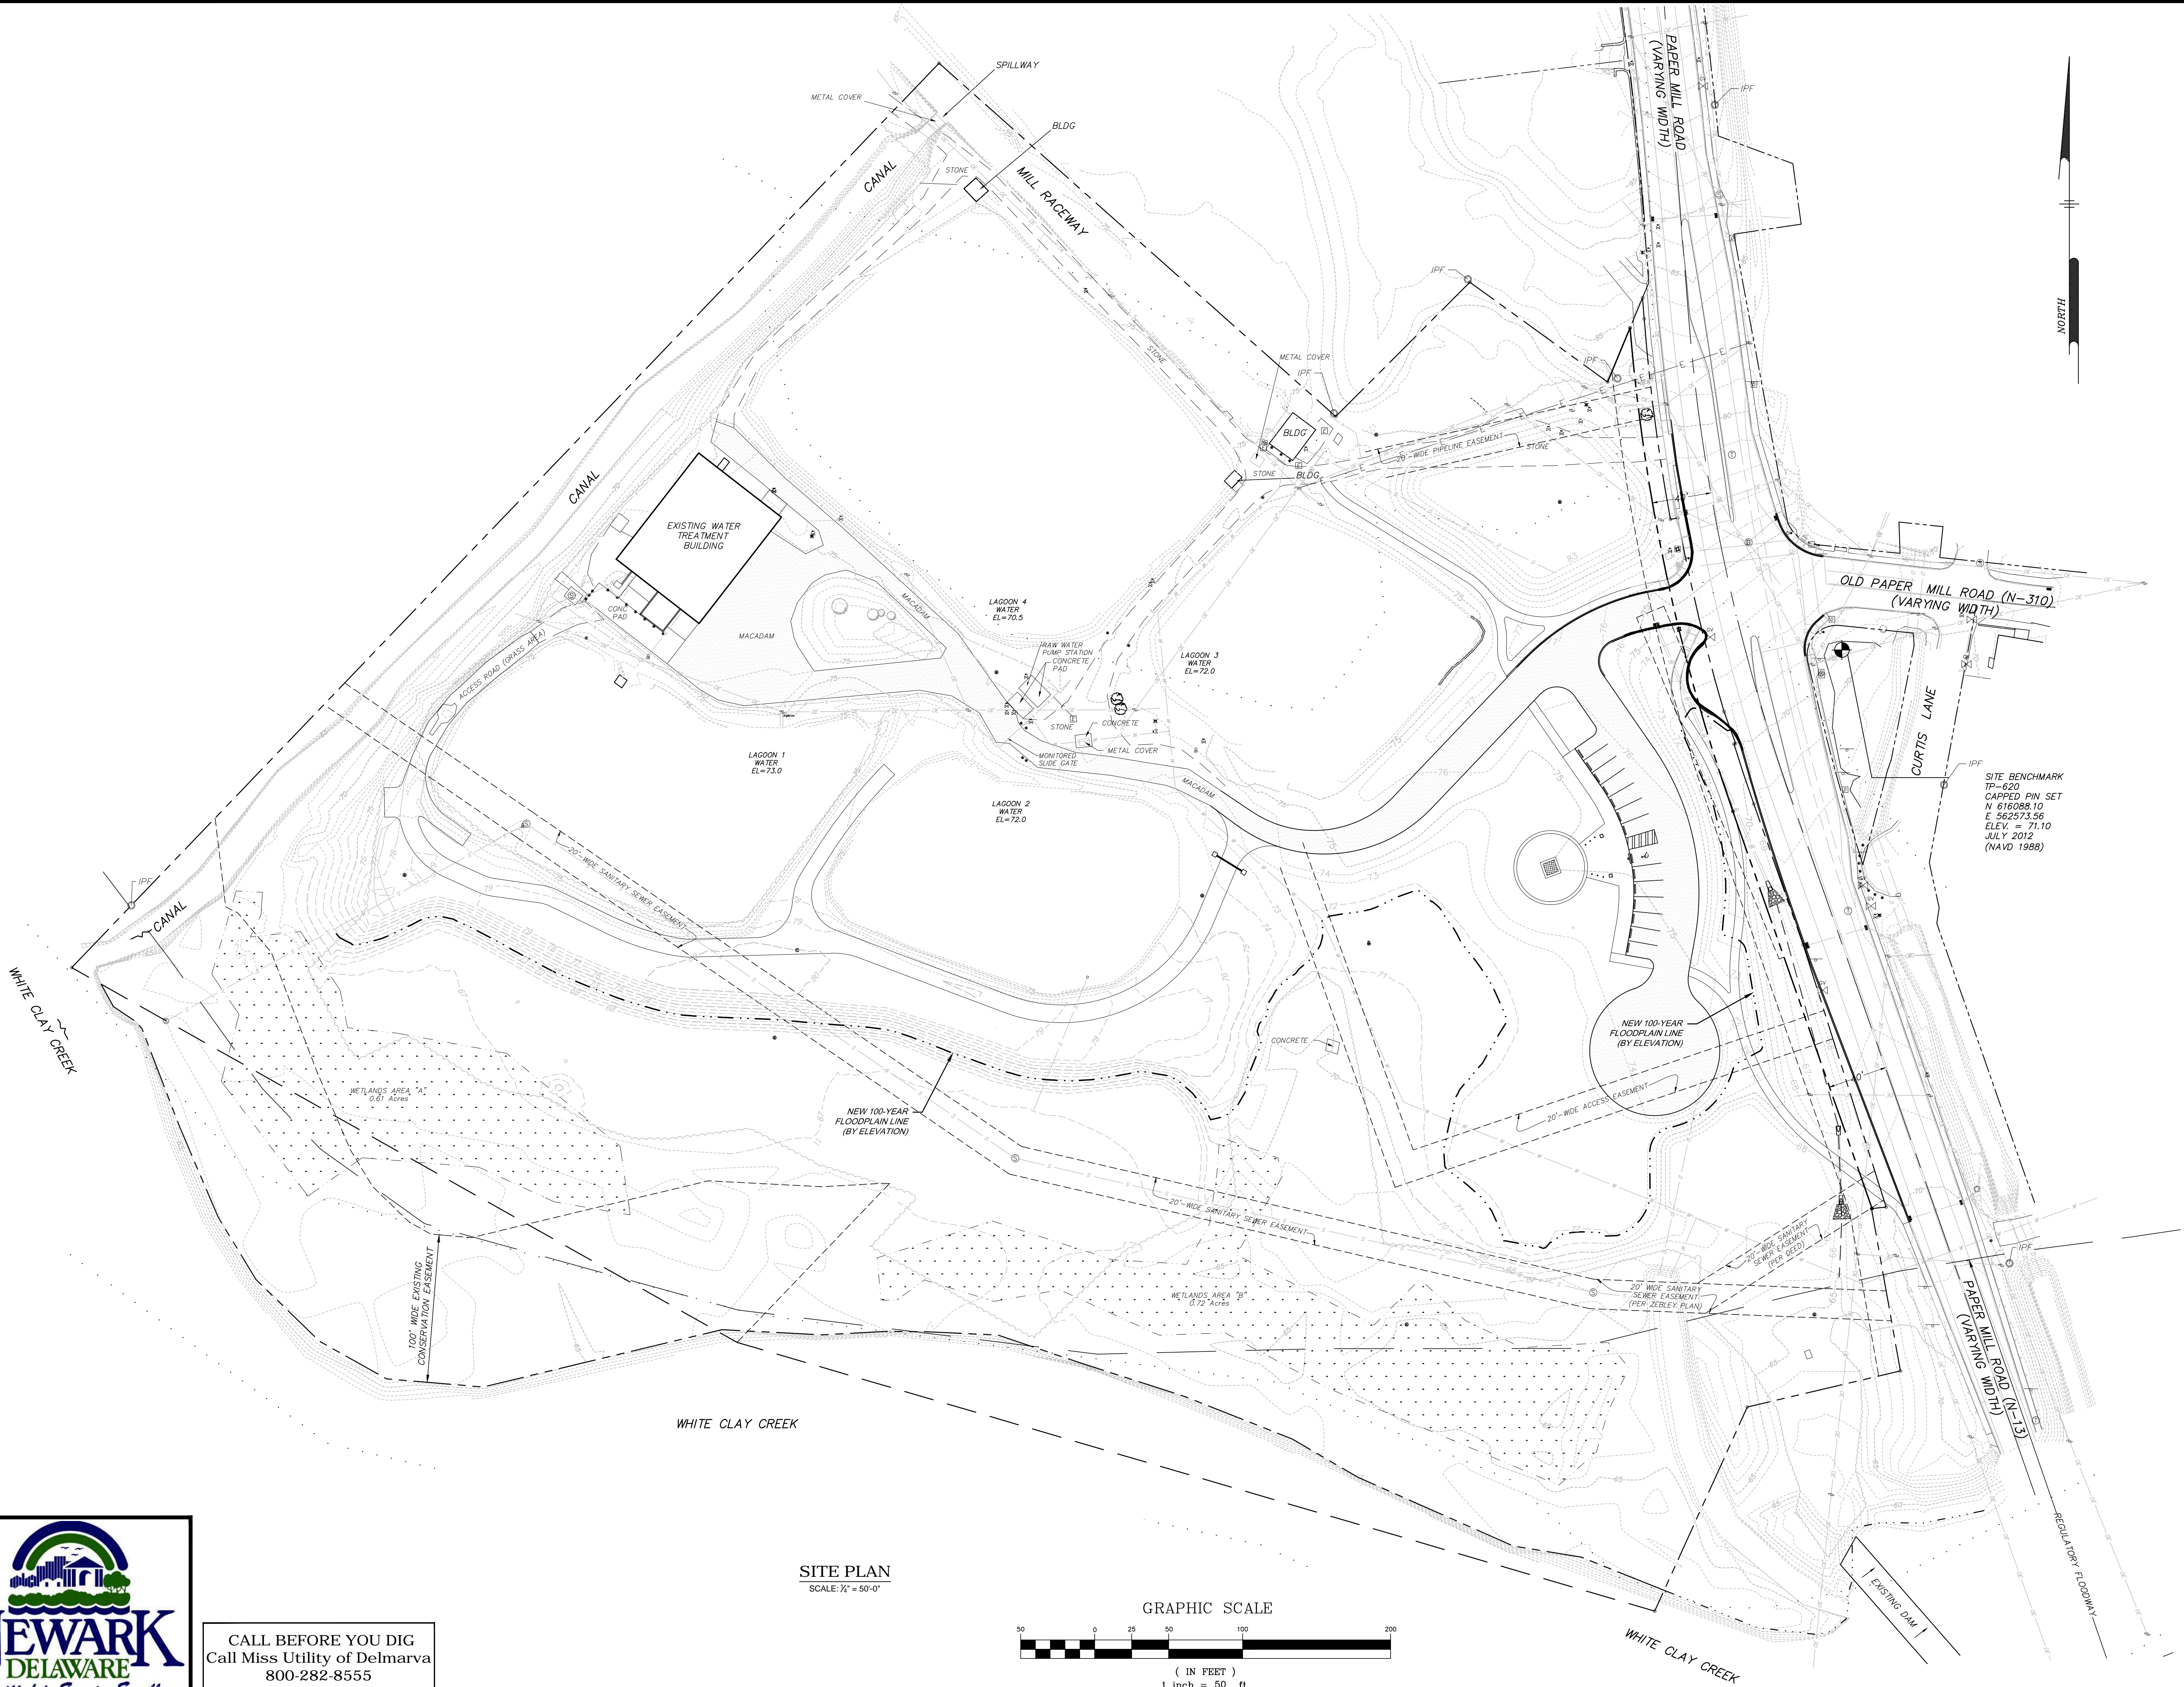
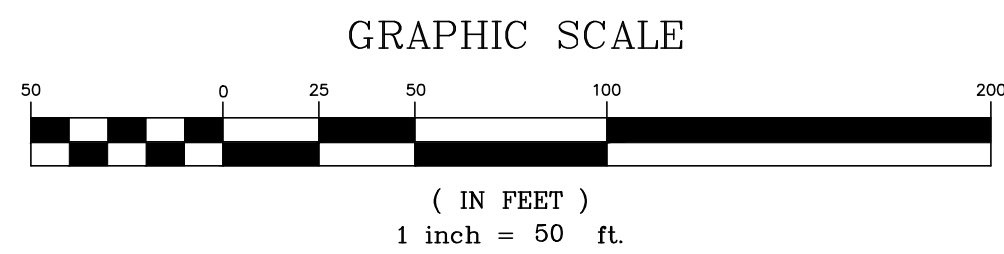
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N:\PROJECTS\CM0201\CM0201.dwg PLOTDATE: 4/20/2017 10:04 PM BY: Brian Miller PLOTSTYLE: Pennon-Half Size.ctb PROJECT STATUS: Construction Plans




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SITE PLAN
SCALE: 1/4" = 50'-0"



CURTIS WATER TREATMENT PLANT
IMPROVEMENTS
EXISTING SITE PLAN
215 PAPER MILL ROAD
NEWARK, DELAWARE
CITY OF NEWARK DEPT. OF PUBLIC WORKS AND WATER RESOURCES
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ARISING OUT OF OR RESULTING THEREFROM.

PROJECT CNEW1612
DATE APRIL 2017
DRAWING SCALE AS SHOWN
DRAWN BY ---
APPROVED BY ---


CM0201
SHEET 5 OF 54

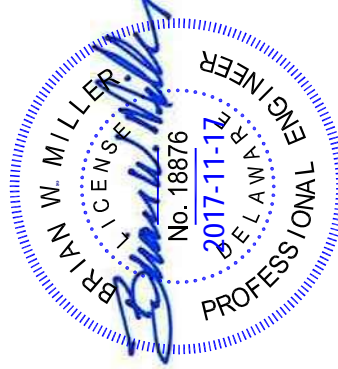N:\PROJECTS\NEWARK\NEW1612\02-17-17\Improvements\DESIGN\2016\CM0202.dwg PLOTTED: 4/20/2017 2:21 PM BY: Brian Miller PROJECT STATUS: CONSTRUCTION PLANS



CALL BEFORE YOU DIG
Call Miss Utility of Delmarva
800-282-8555

SITE PLAN
SCALE: 1" = 10'

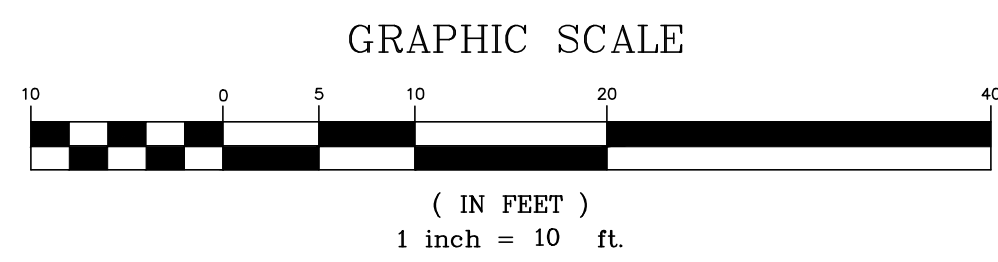

CURTIS WATER TREATMENT PLANT
IMPROVEMENTS
215 PAPER MILL ROAD
NEWARK, DELAWARE

WATER TREATMENT FACILITY SITE PLAN

CITY OF NEWARK DEPT. OF PUBLIC WORKS AND WATER RESOURCES
220 SOUTH MAIN STREET
NEWARK, DELAWARE 19711


NO.	DATE	REVISIONS	BY

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PROJECT	CNEW1612
DATE	APRIL 2017
DRAWING SCALE	AS SHOWN
DRAWN BY	MWF/BWM
APPROVED BY	DPB


CM0202

SHEET 6 OF 54



PENNONI ASSOCIATES INC.
Christiana Executive Campus
121 Continental Drive, Suite 207
Newark, DE 19713-4310
T 302.655.4451 F 302.654.2885

ALL DIMENSIONS MUST BE VERIFIED BY CONTRACTOR AND OWNER MUST BE NOTIFIED OF ANY DISCREPANCIES BEFORE PROCEEDING WITH WORK



PROJECT STATUS: CONSTRUCTION PLANS
PLOT DATE: 4/28/2017 3:21 PM BY: R. G. GROVE, P.E.
PROJECT: NEWARK WATER TREATMENT PLANT IMPROVEMENTS



WALL TYPES
SCALE: N.T.S.

GENERAL PARTITION NOTES:

- PROVIDE MOISTURE RESISTANT GYPSUM WALL BOARD AT ALL WET & TOILET/BATHROOM LOCATIONS.
- PROVIDE TILE BACKER BOARD AT ALL TILE LOCATIONS.
- SEE ROOM FINISH TAGS FOR ADDITIONAL WALL FINISH SPECIFICATIONS.



MT-11 3 5/8" 20 GA. METAL STUDS @ 16" O.C. WITH 5/8" GYPSUM WALL BOARD ON BOTH SIDES. HEIGHT OF WALL: TO STRUCTURE ABOVE

MT-12 SAME AS MT-11 EXCEPT WITH 5/8" GYPSUM WALL BOARD ON ONE SIDE. HEIGHT OF WALL: TO STRUCTURE ABOVE

MT-21 EXISTING 3 5/8" METAL STUDS @ 16" O.C. (V.I.F.) WITH SIDE-A TO RECEIVE NEW 3/4" FIRE RATED GYPSUM WALL BOARD CONTINUOUS ALONG BASE WALL UP TO 24" A.F.F. EXISTING 5/8" FIRE RATED GYPSUM WALL BOARD ABOVE 24" TO BE PATCHED/REPAIRED ONE SIDE. SIDE-B TO RECEIVE 3/4" DENSHEILD SHEATHING WITH 2" INSULATED METAL WALL PANEL. WALL TO RECEIVE NEW 4" SOUND ATTENUATION BLANKET FULL HEIGHT OF WALL: TO STRUCTURE ABOVE

MT-22 NEW 3 5/8" 20 GA. METAL STUDS @ 16" O.C. WITH 5/8" GYPSUM WALL BOARD ON ONE SIDE. ONE SIDE TO RECEIVE 3/4" DENSHEILD SHEATHING WITH INSULATED METAL WALL PANEL. WALL TO RECEIVE NEW 4" SOUND ATTENUATION BLANKET FULL HEIGHT OF WALL: TO STRUCTURE ABOVE

MT-23 EXISTING 3 5/8" METAL STUDS @ 16" O.C. (V.I.F.) WITH SIDE-A TO RECEIVE NEW 3/4" FIRE RATED

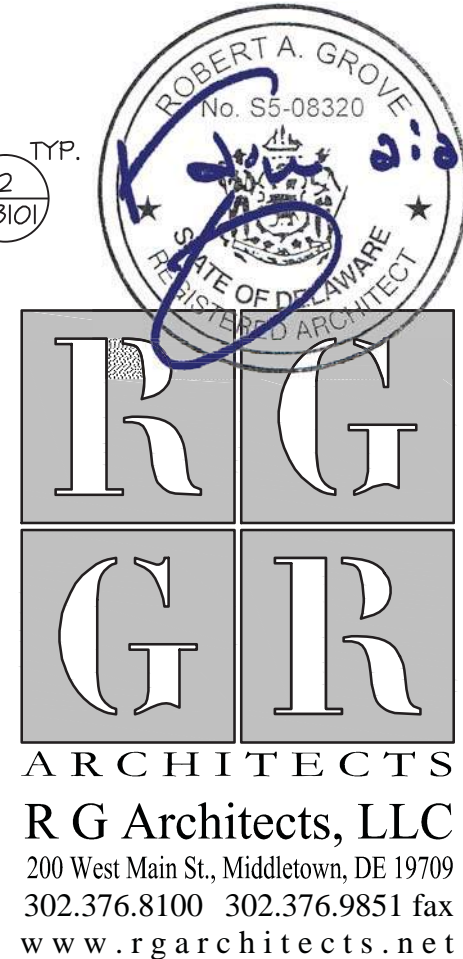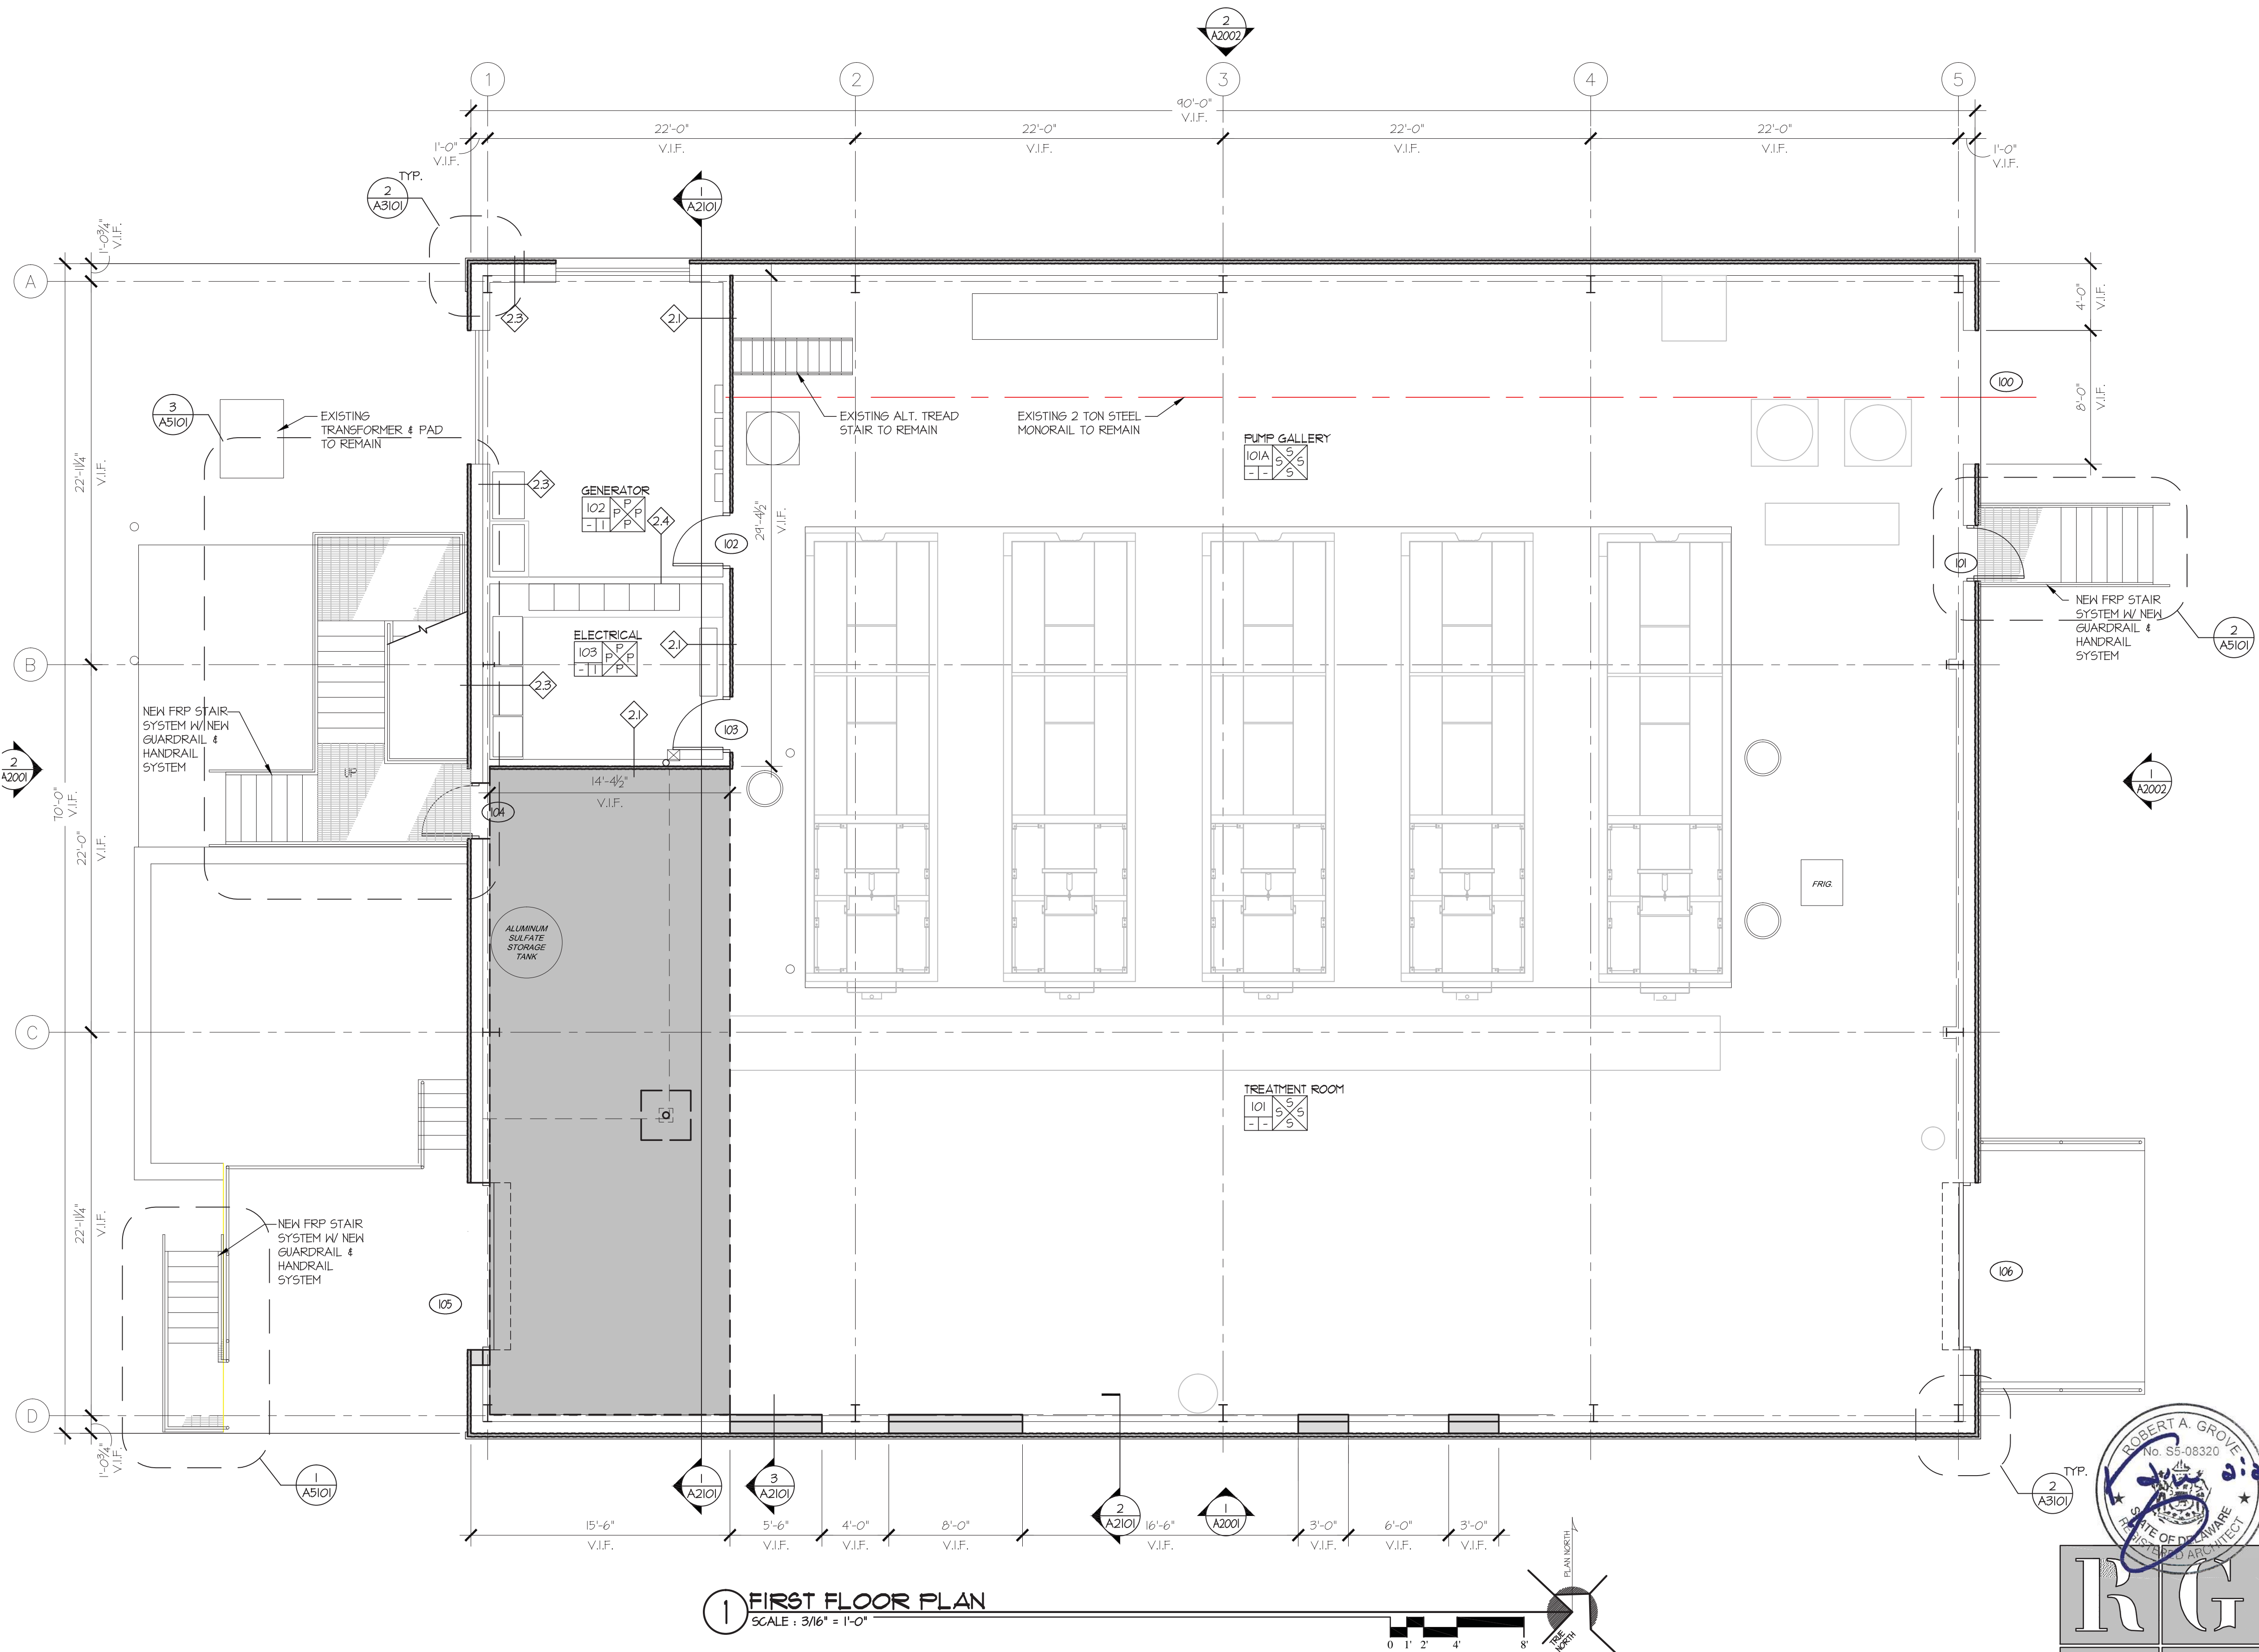

FLOOR PLAN AND SECTION INFORMATION DERIVED FROM: CITY OF NEWARK, WATER TREATMENT FACILITIES PLANT, CONTRACT W-90-11 PREPARED BY TATMAN & LEE ASSOCIATES, INC. DATED 10/1/1990

CURTIS WATER TREATMENT PLANT IMPROVEMENTS
215 PAPER MILL ROAD
NEWARK, DELAWARE
FIRST FLOOR PLAN

CITY OF NEWARK DEPT. OF PUBLIC WORKS AND WATER RESOURCES
220 SOUTH MAIN STREET
NEWARK, DELAWARE 19711

NO.	DATE	REVISIONS	BY

PROJECT	CNEW1612
DATE	APRIL 2017
DRAWING SCALE	AS SHOWN
DRAWN BY	RG ARCHITECTS
APPROVED BY	RG ARCHITECTS

A1101
SHEET 8 OF 54

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PENNONI ASSOCIATES INC.
Christiana Executive Campus
121 Continental Drive, Suite 207
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T 302.655.4451 F 302.654.2895

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RG
ARCHITECTS

FLOOR PLAN AND SECTION INFORMATION DERIVED FROM 'CITY OF NEWARK, WATER TREATMENT FACILITIES PLANT, CONTRACT W-90-1' PREPARED BY TATMAN & LEE ASSOCIATES, INC. DATED 10/1/1990



CURTIS WATER TREATMENT PLANT
IMPROVEMENTS
215 PAPER MILL ROAD
NEWARK, DELAWARE

ROOF & MEZZANINE FLOOR PLAN

CITY OF NEWARK DEPT. OF PUBLIC WORKS AND WATER RESOURCES
220 SOUTH MAIN STREET
NEWARK, DELAWARE 19711

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AND OWNER MUST BE NOTIFIED OF ANY
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50th
Pennoni

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121 Continental Drive, Suite 207
Newark, DE 19713-4310
T 302.656.4451 F 302.654.2899



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PROJECT	CNEW1612
DATE	APRIL 2017
DRAWING SCALE	AS SHOWN
DRAWN BY	RG ARCHITECTS
APPROVED BY	RG ARCHITECTS


A1102
SHEET 9 OF 54

\\projects\newark\1010 Code WTP Improvements\DESIGN\101001_RoofPlan.dwg PLOTTED: 4/28/2017 2:22 PM BY: Brian Miller R:\STYLE\RGAs.dwg PROJECT STATUS: CONSTRUCTION PLANS



REFLECTED CEILING LEGEND

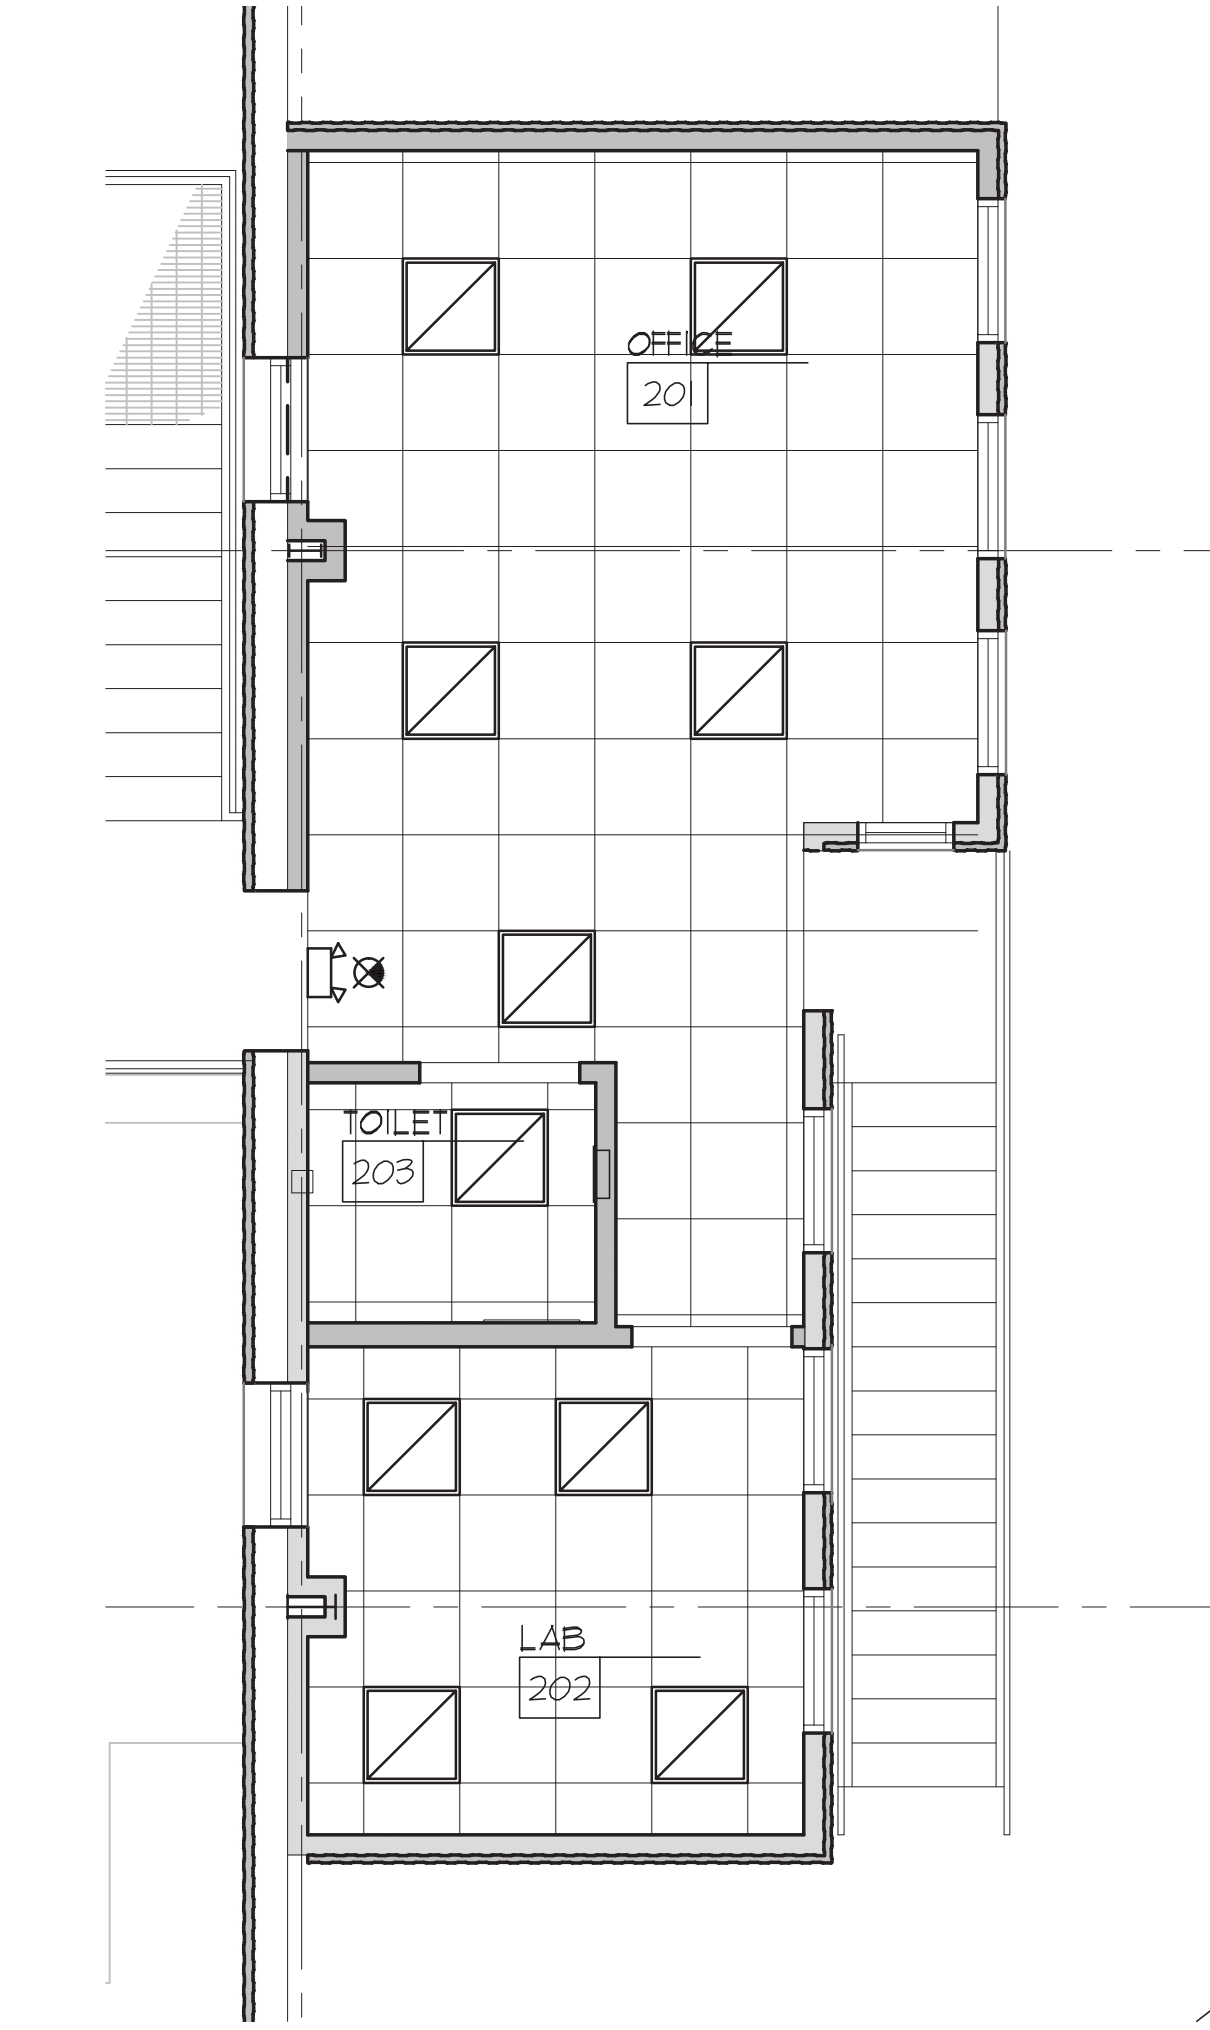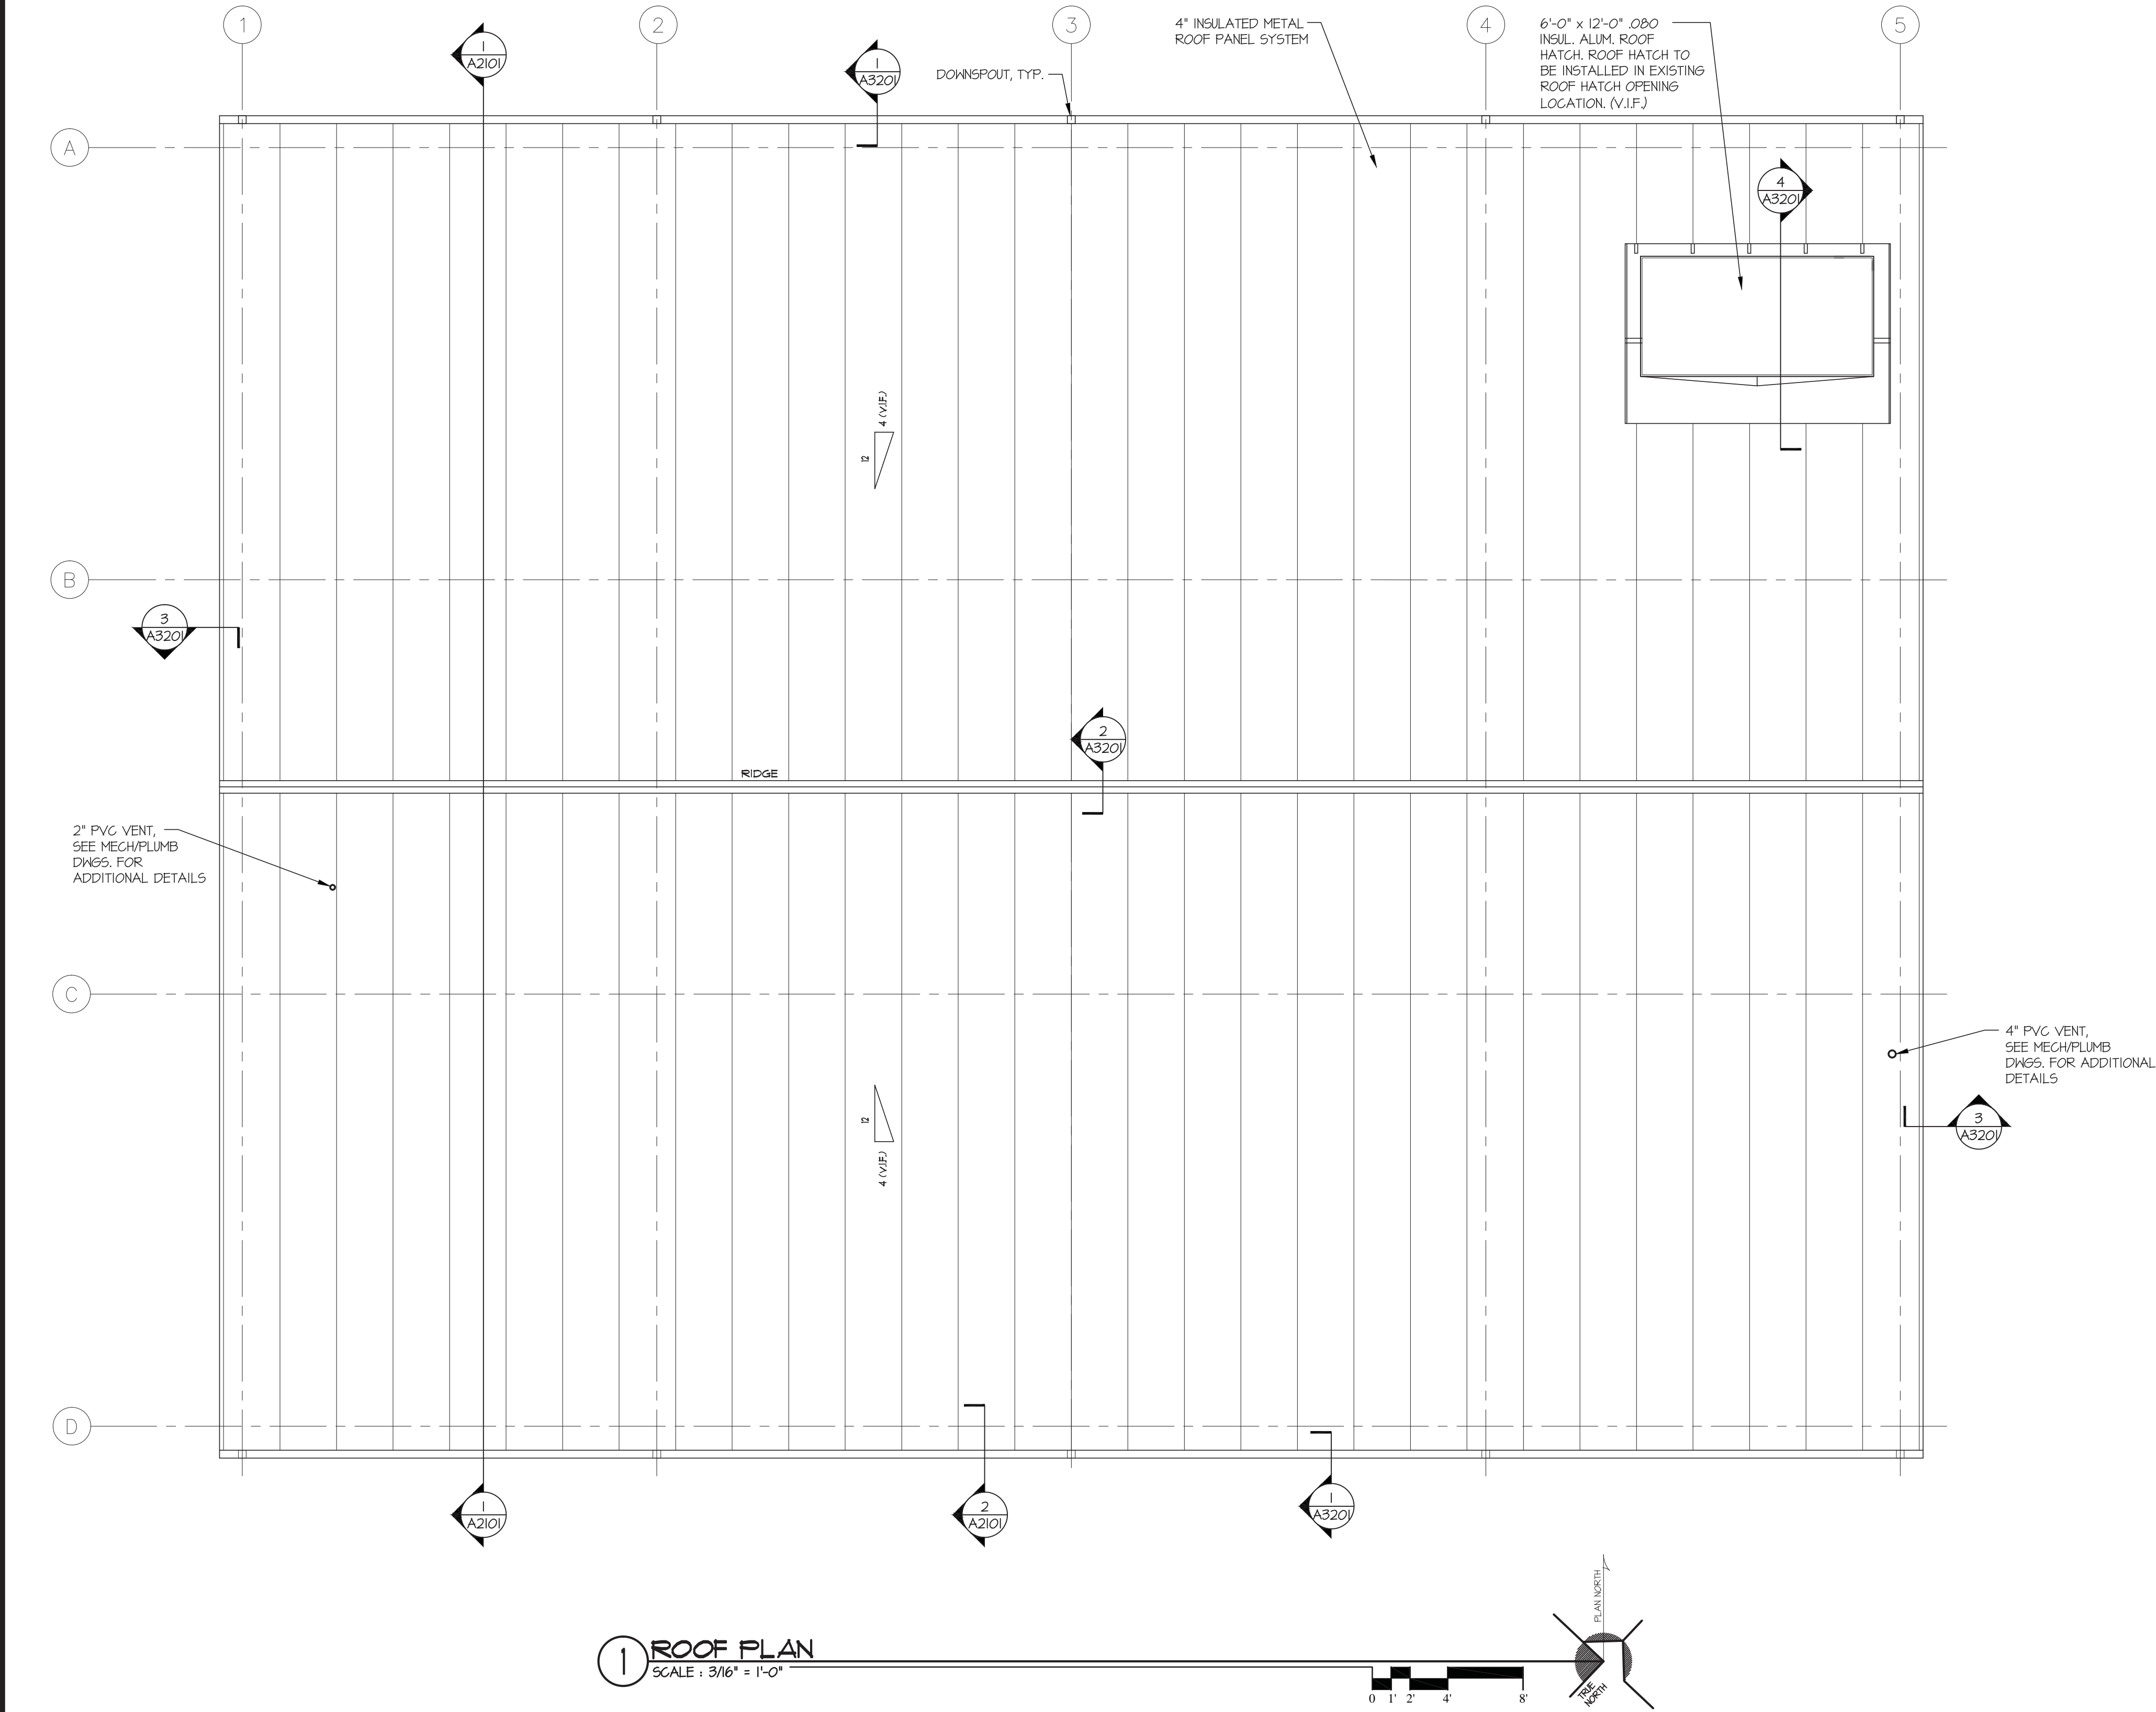- EMERGENCY LIGHTING w/ BATTERY BACKUP
- ILLUMINATED EXIT SIGN
- 2'X2' SUSPENDED ACOUSTIC CEILING SYSTEM
- 2'X2' LIGHT FIXTURE - SEE ELECT. DWGS
- 2'X2' MECHANICAL SUPPLY
- 2'X2' MECHANICAL RETURN

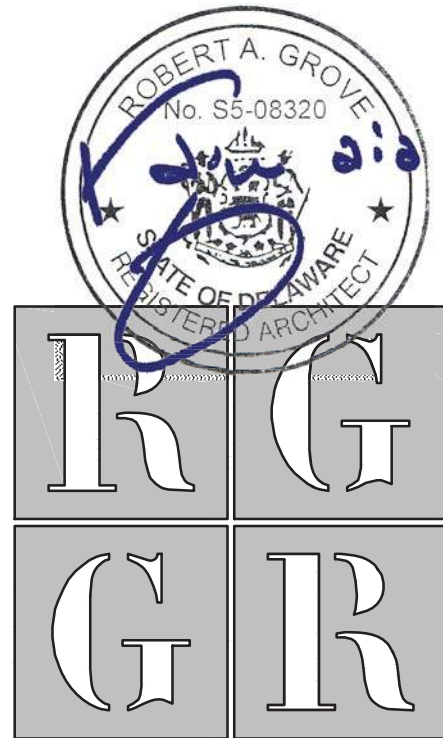

ARCHITECTS
R G Architects, LLC
200 West Main St., Middletown, DE 19709
302.376.8100 302.376.9851 fax
www.rgarchitects.net

FLOOR PLAN AND SECTION INFORMATION DERIVED FROM: CITY OF NEWARK, WATER TREATMENT FACILITIES PLANT, CONTRACT W-90-1* PREPARED BY TATMAN & LEE ASSOCIATES, INC. DATED 10/1/1990

CURTIS WATER TREATMENT PLANT IMPROVEMENTS
215 PAPER MILL ROAD
NEWARK, DELAWARE
ROOF PLAN
CITY OF NEWARK DEPT. OF PUBLIC WORKS AND WATER RESOURCES
220 SOUTH MAIN STREET
NEWARK, DELAWARE 19711

NO.	DATE	REVISIONS	BY

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PROJECT	CNEW1612
DATE	APRIL 2017
DRAWING SCALE	AS SHOWN
DRAWN BY	RG ARCHITECTS
APPROVED BY	RG ARCHITECTS



A1103
SHEET 10 OF 54



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PROJECTS\NEWARK\110 Code WTP Improvements\DESIGN\11004_0000_0000.dwg
PLOTTED: 4/25/2017 3:22 PM BY: Brian Miller
PROJECT STATUS: CONSTRUCTION PLANS



0 1' 2' 4' 8'

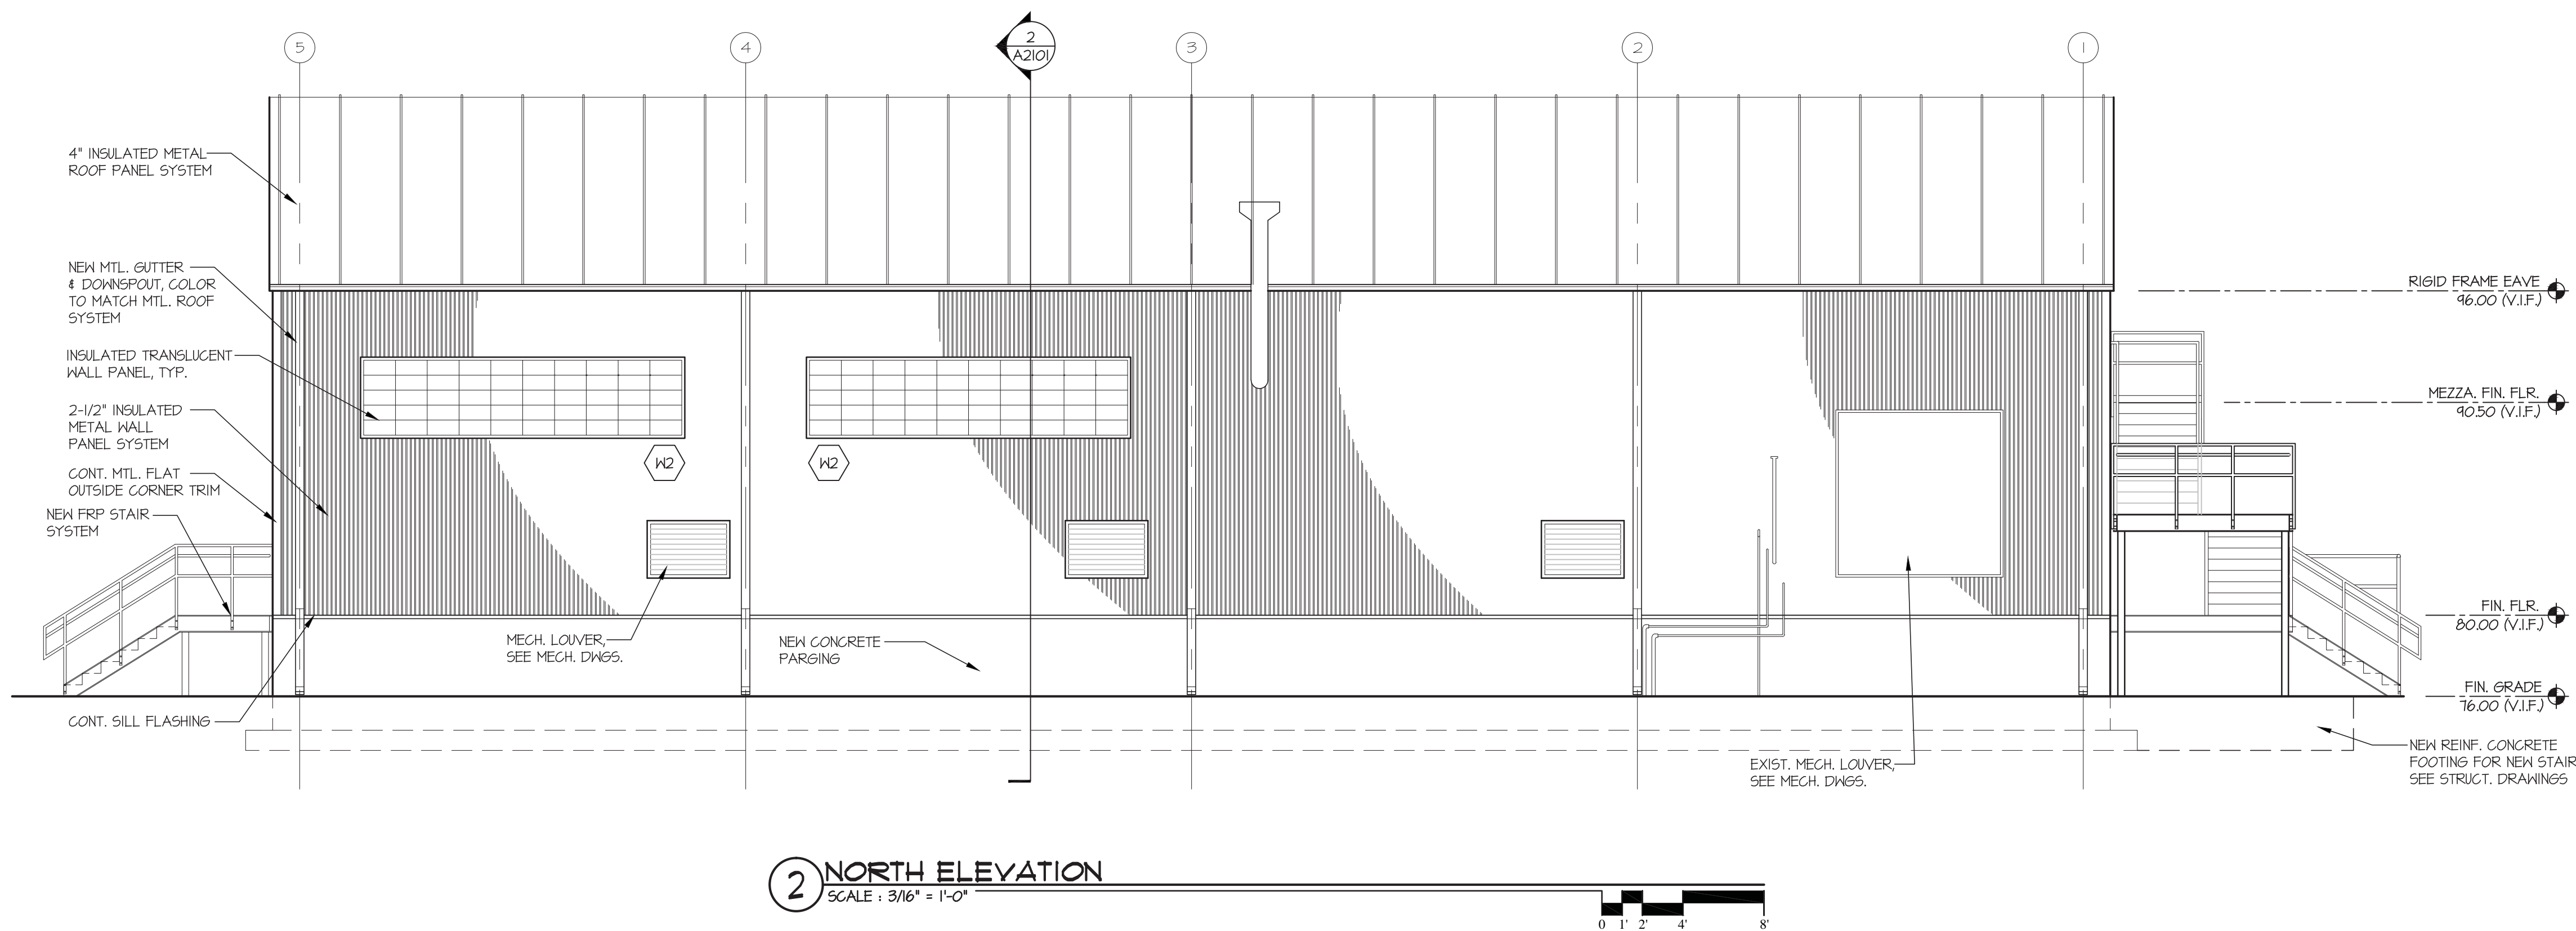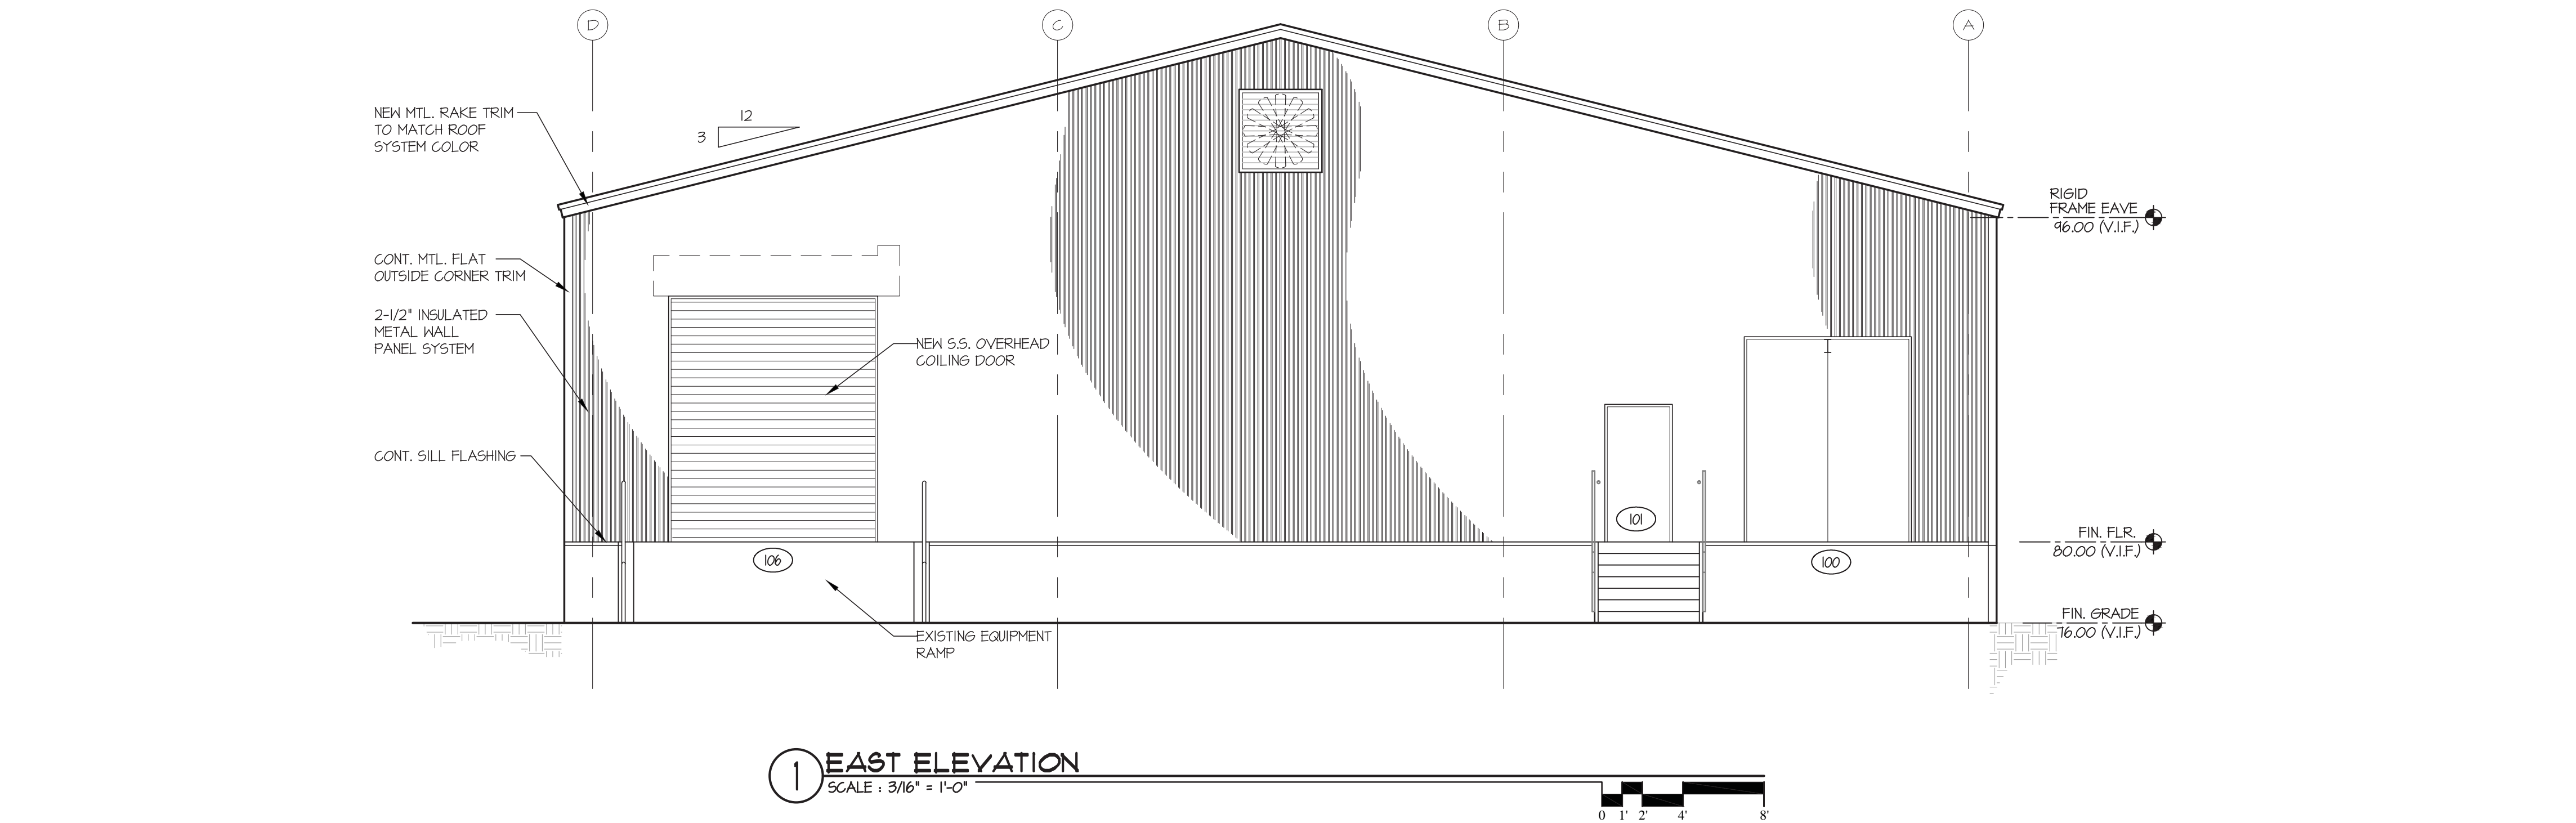FLOOR PLAN AND SECTION INFORMATION DERIVED FROM: CITY OF NEWARK, WATER TREATMENT FACILITIES PLANT, CONTRACT W-90-1* PREPARED BY TATMAN & LEE ASSOCIATES, INC. DATED 10/1/1990

CURTIS WATER TREATMENT PLANT
IMPROVEMENTS
215 PAPER MILL ROAD
NEWARK, DELAWARE

NORTH & EAST ELEVATIONS

CITY OF NEWARK DEPT. OF PUBLIC WORKS AND WATER RESOURCES
220 SOUTH MAIN STREET
NEWARK, DELAWARE 19711

NO.	DATE	REVISIONS	BY

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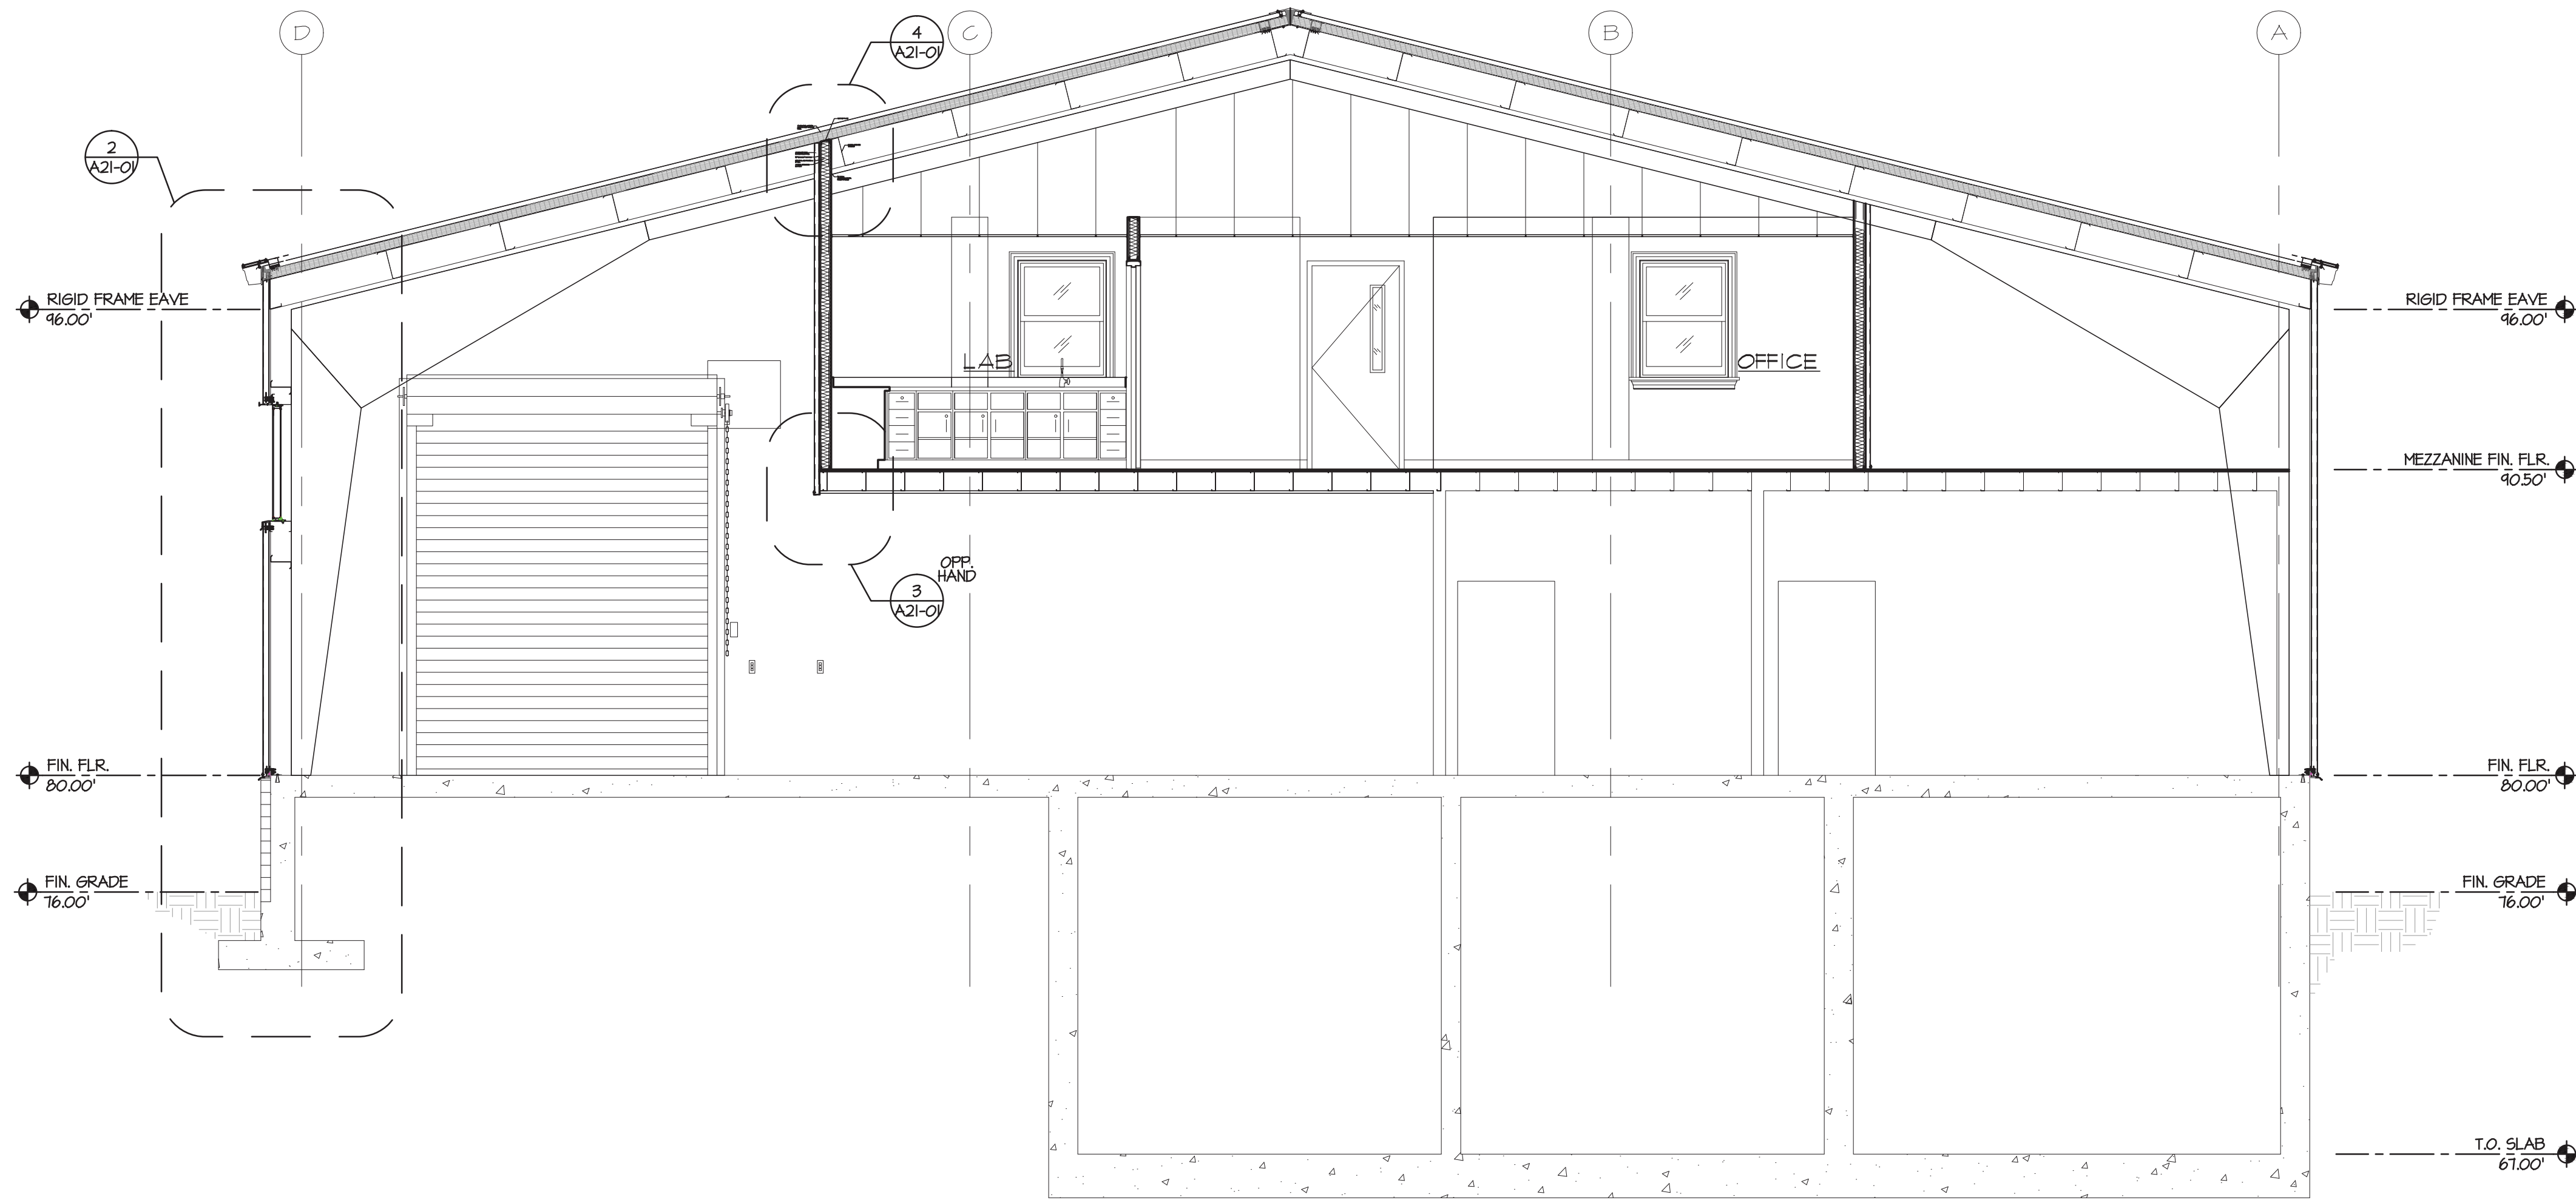
PROJECT CNEW1612
DATE APRIL 2017
DRAWING SCALE AS SHOWN
DRAWN BY RG ARCHITECTS
APPROVED BY RG ARCHITECTS

A2002
SHEET 12 OF 54



ALL DIMENSIONS MUST BE VERIFIED BY CONTRACTOR AND OWNER MUST BE NOTIFIED OF ANY DISCREPANCIES BEFORE PROCEEDING WITH WORK

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PENNONI ASSOCIATES INC.
Christiana Executive Campus
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Newark, DE 19713-4310
T 302.655.4451 F 302.654.2895


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PLOTTER: 4/22/2017 2:23 PM BY: Peter Miller
PLOT STYLE: RGArch




1 BUILDING SECTION
SCALE: 1/4" = 1'-0"

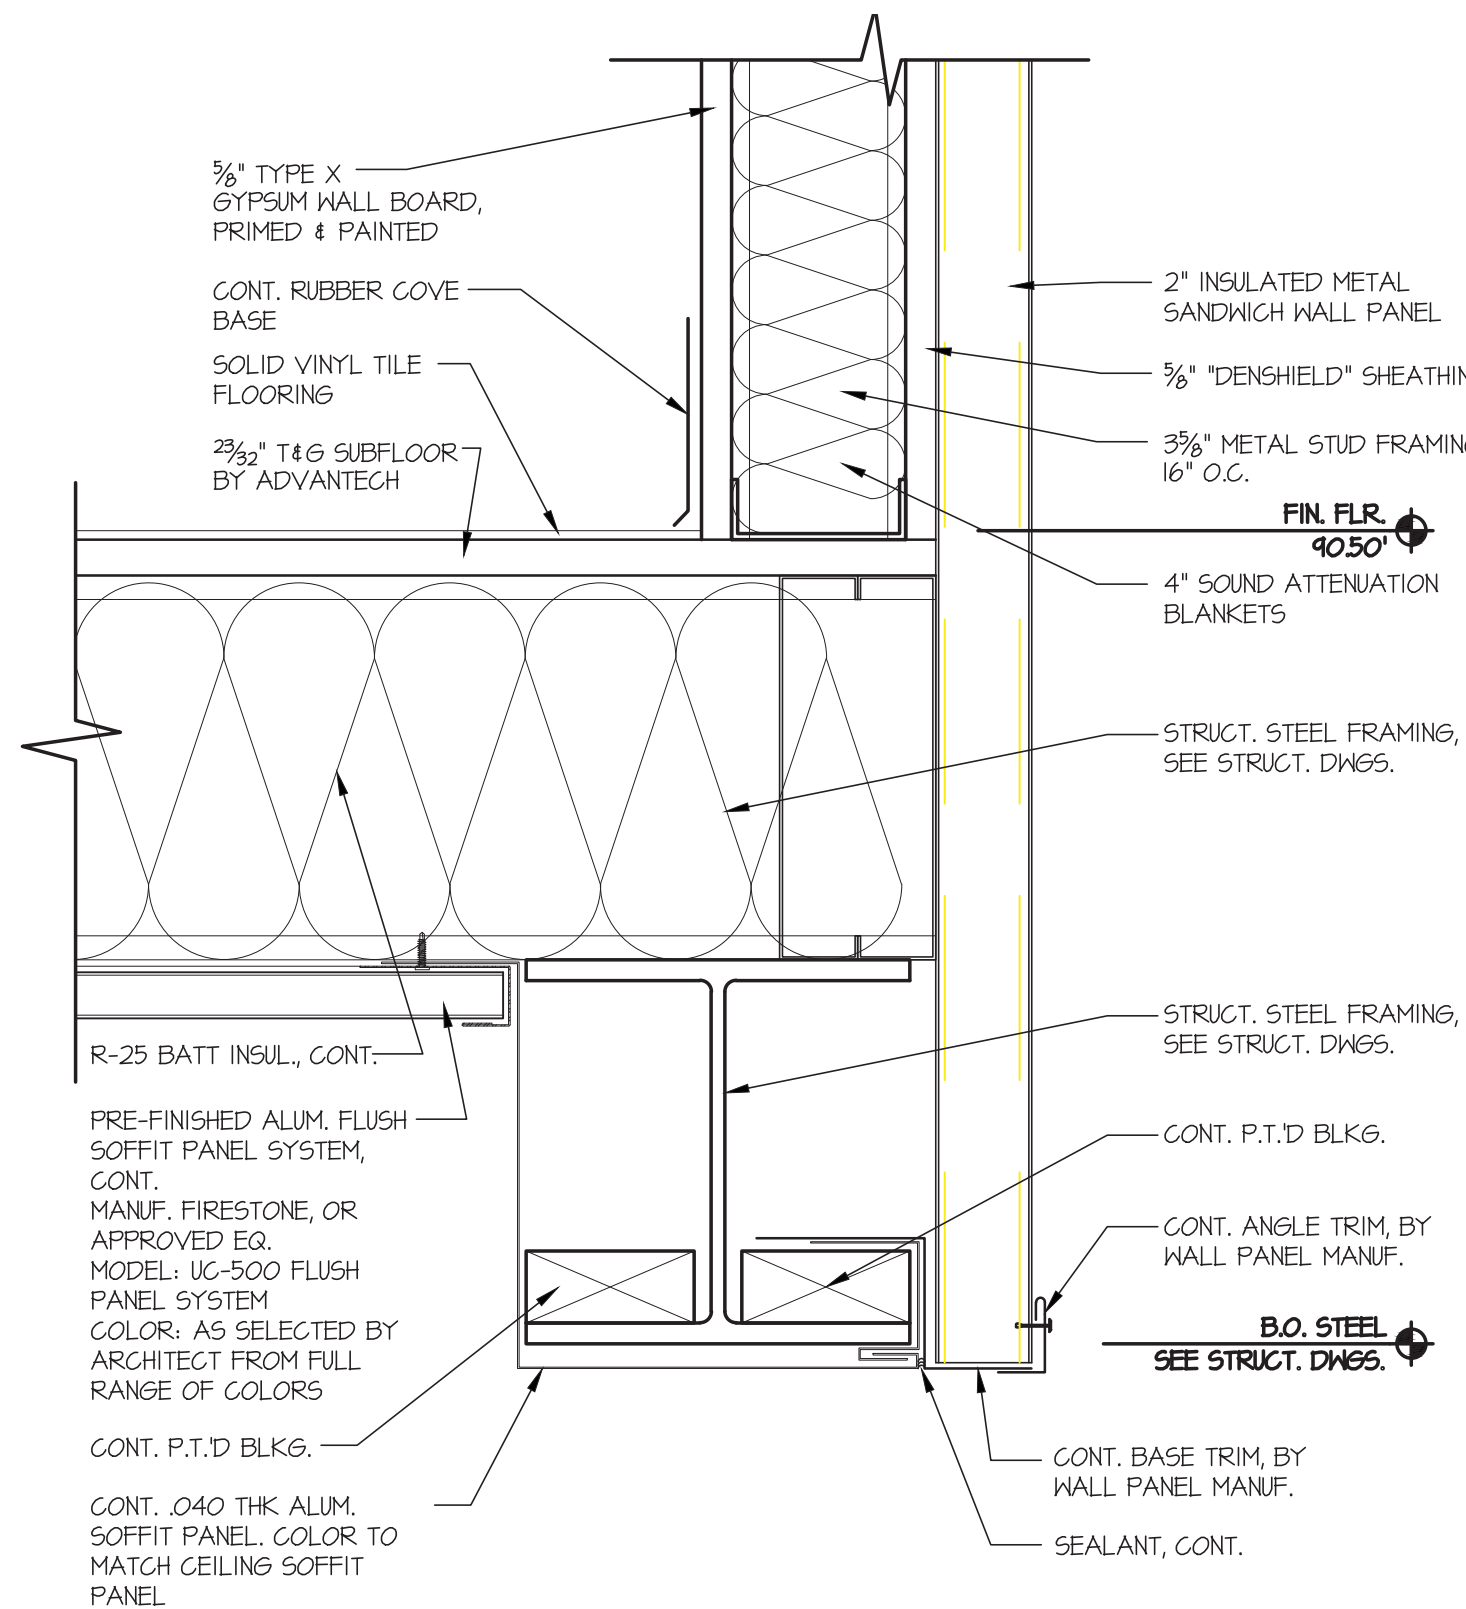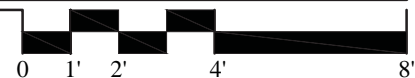

3 DETAIL
SCALE: 3/4" = 1'-0"

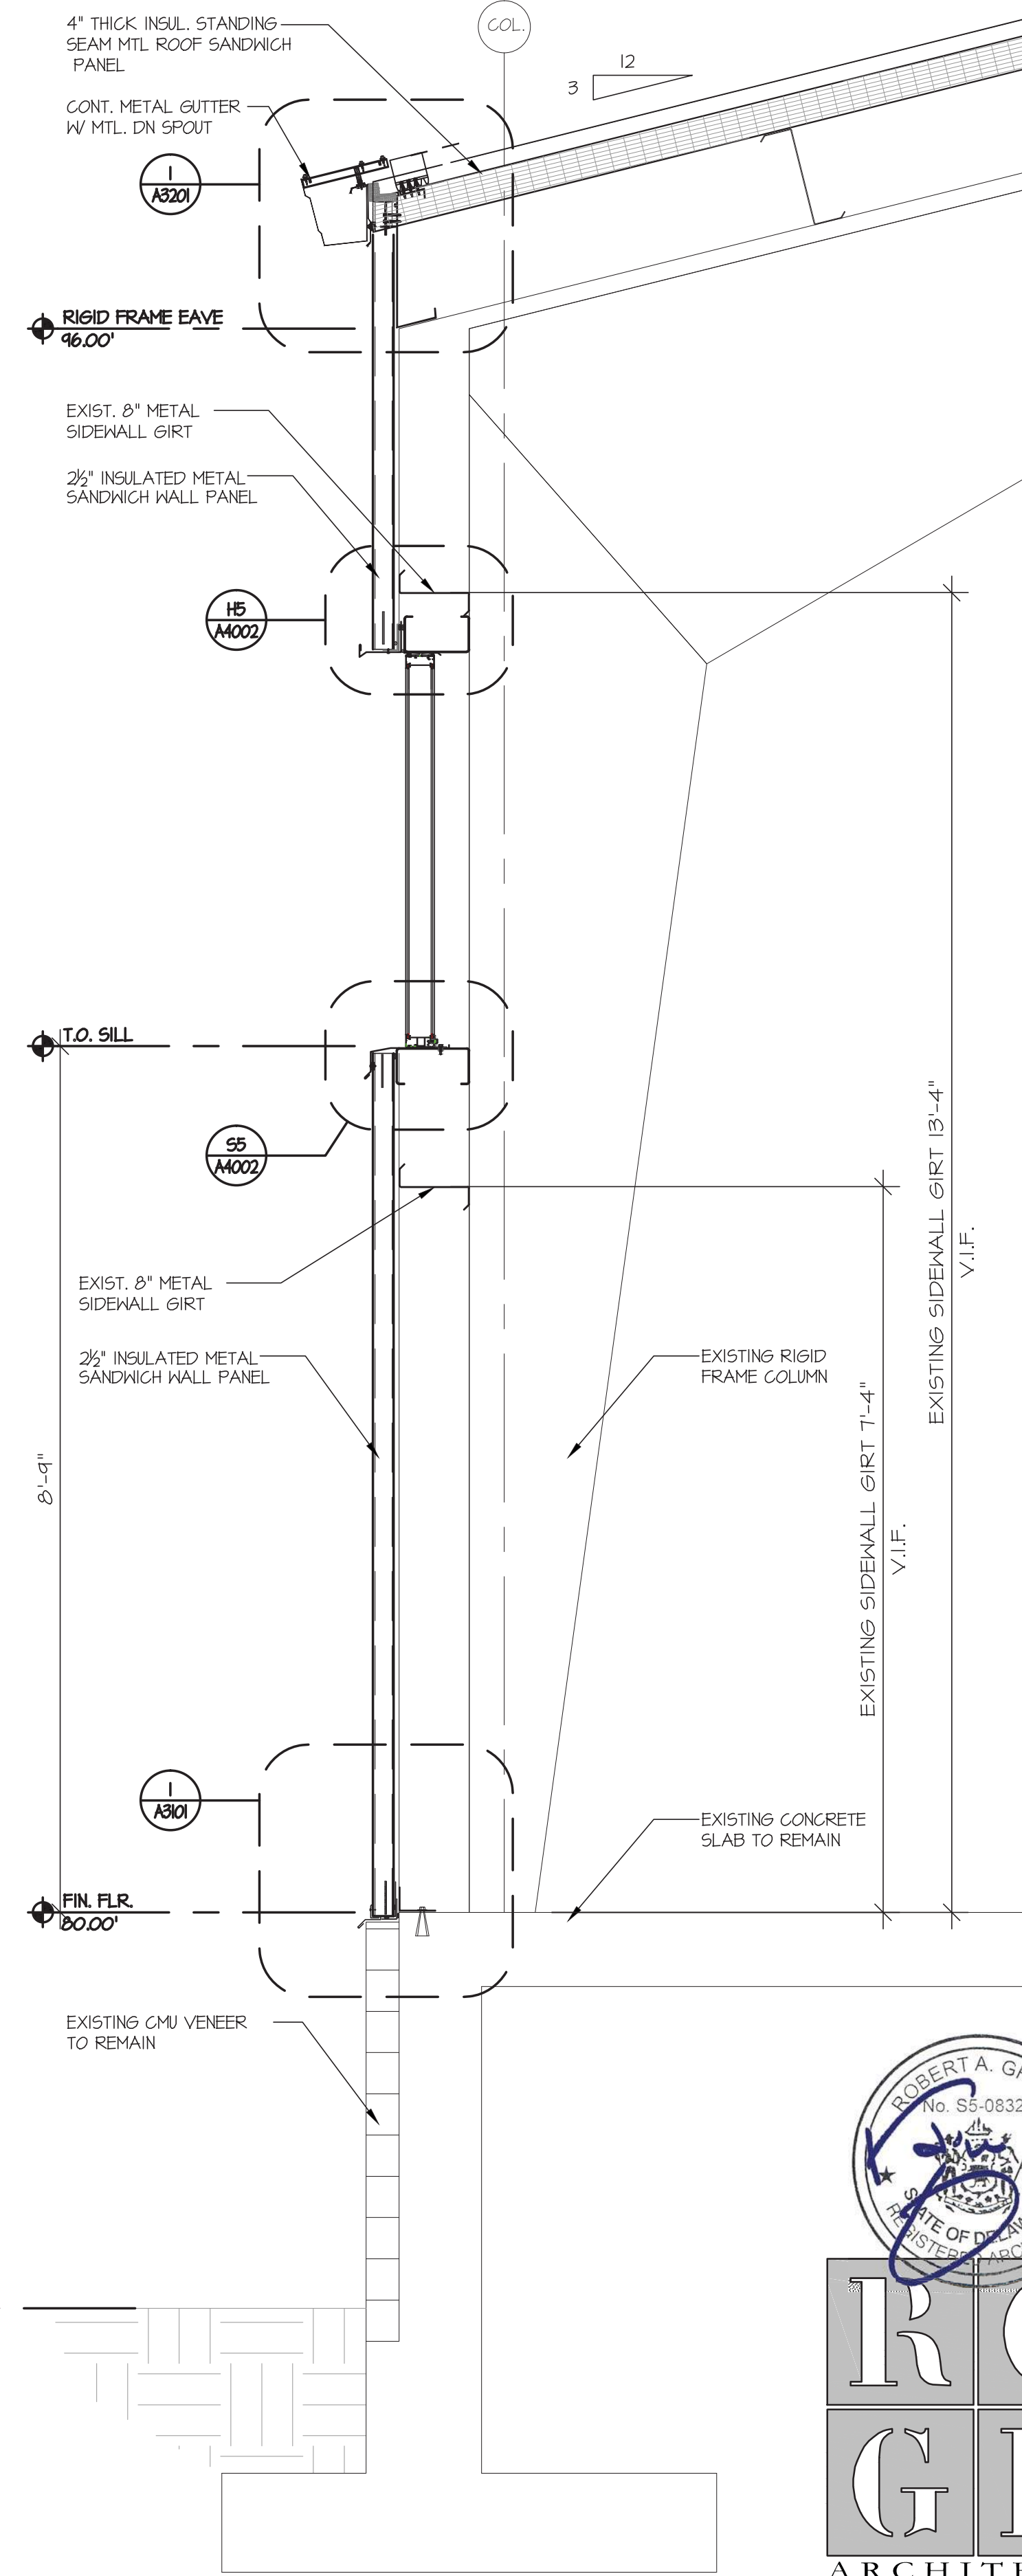

2 WALL SECTION
SCALE: 3/4" = 1'-0"

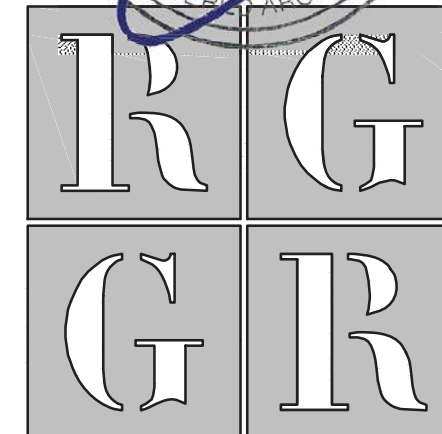

ARCHITECTS
R G Architects, LLC
200 West Main St., Middletown, DE 19709
302.376.8100 302.376.9851 fax
www.rgarchitects.net

FLOOR PLAN AND SECTION INFORMATION DERIVED FROM: CITY OF NEWARK, WATER TREATMENT FACILITIES PLANT, CONTRACT W-90-1* PREPARED BY TATMAN & LEE ASSOCIATES, INC. DATED 10/1/1990



CURTIS WATER TREATMENT PLANT
IMPROVEMENTS
215 PAPER MILL ROAD
NEWARK, DELAWARE
SECTIONS

CITY OF NEWARK DEPT. OF PUBLIC WORKS AND WATER RESOURCES
220 SOUTH MAIN STREET
NEWARK, DELAWARE 19711

NO.	DATE	REVISIONS	BY

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PROJECT	CNEW1612
DATE	APRIL 2017
DRAWING SCALE	AS SHOWN
DRAWN BY	RG ARCHITECTS
APPROVED BY	RG ARCHITECTS


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SHEET 13 OF 54

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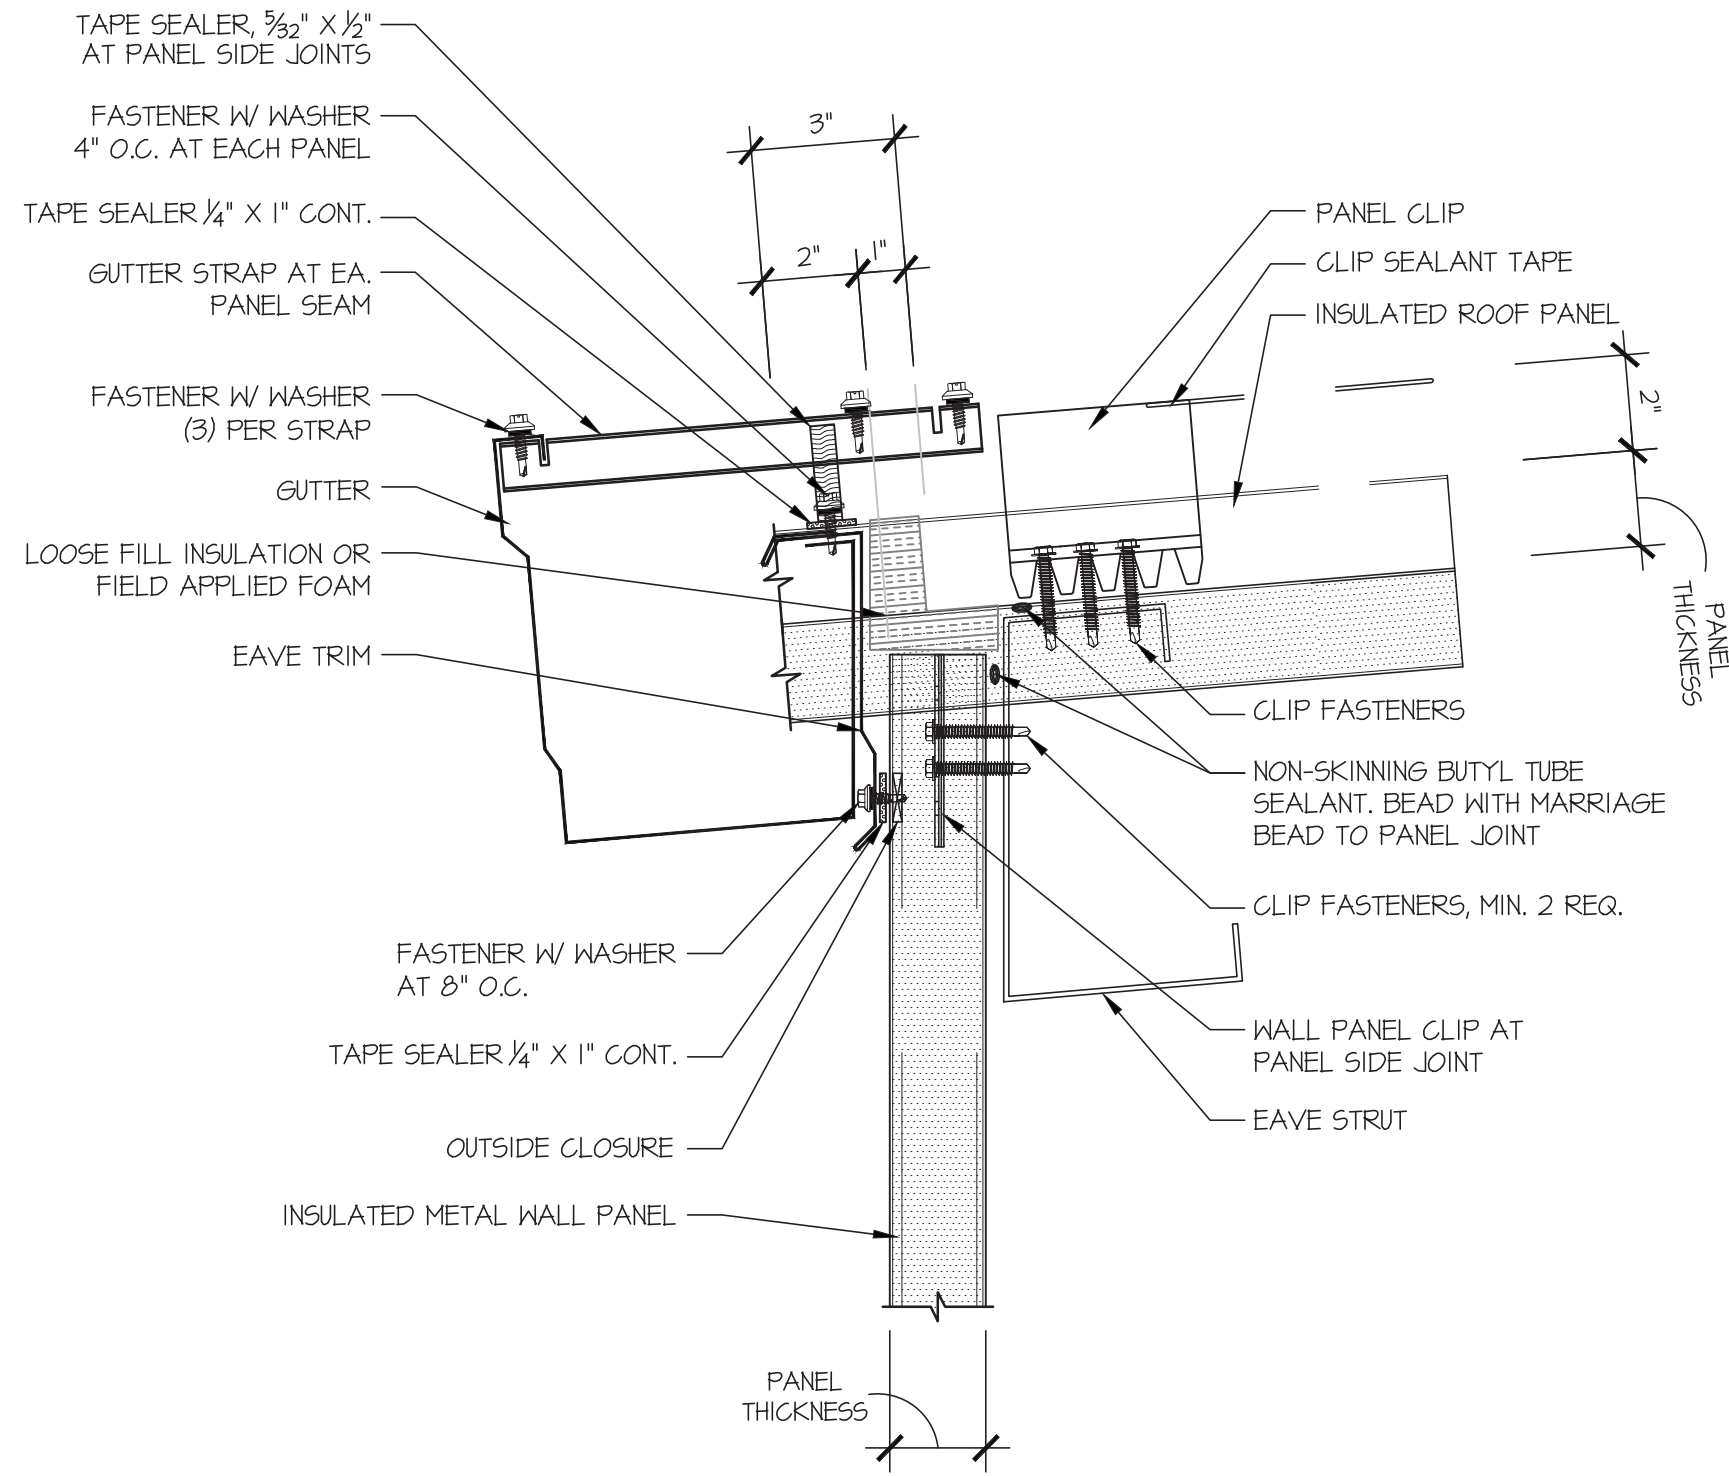


PENNONI ASSOCIATES INC.
Christiana Executive Campus
121 Continental Drive, Suite 207
Newark, DE 19713-4310
T 302.655.4451 F 302.654.2895


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PLOTTER: 4/22/2017 2:24 PM BY: Brian Miller
R: 03/25/16 RGAs
\\projects\newark\newark1612\code\wtp\improvements\section\161204_roofdetails.dwg

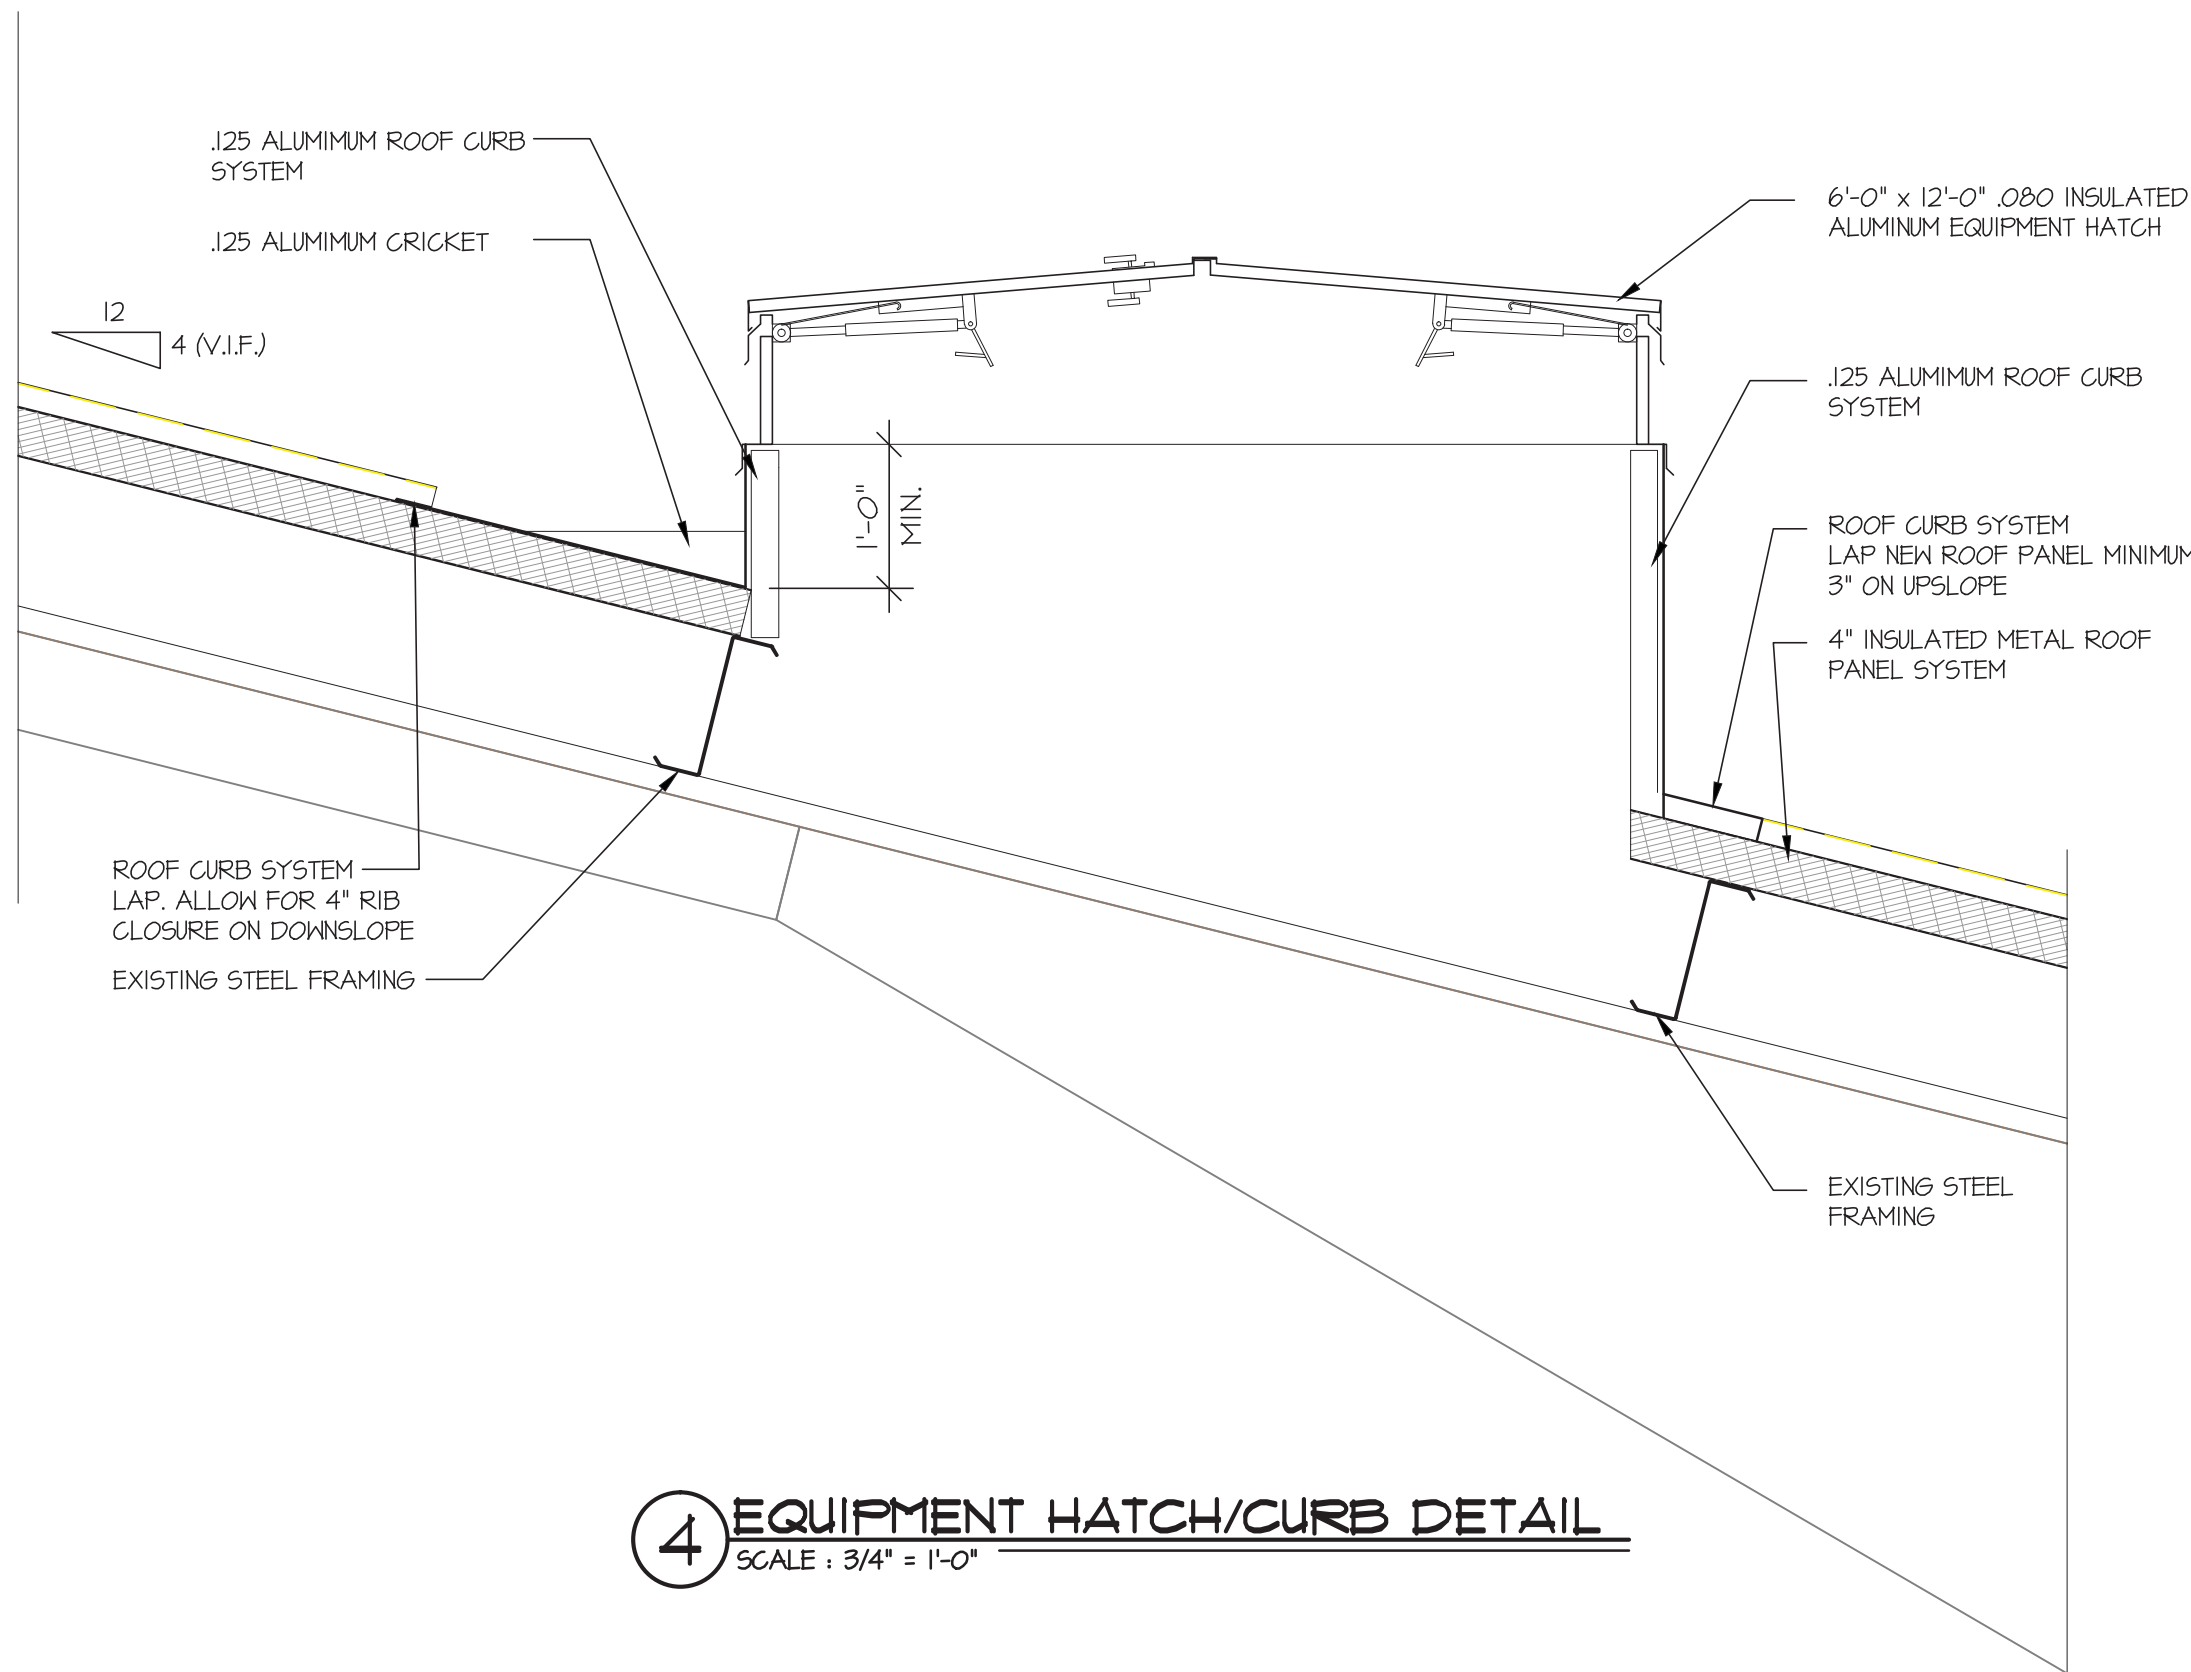


4 EQUIPMENT HATCH/CURB DETAIL
SCALE : 3/4" = 1'-0"



1 ROOF PANEL @ EAVE WITH GUTTER DETAIL
SCALE : N.T.S.

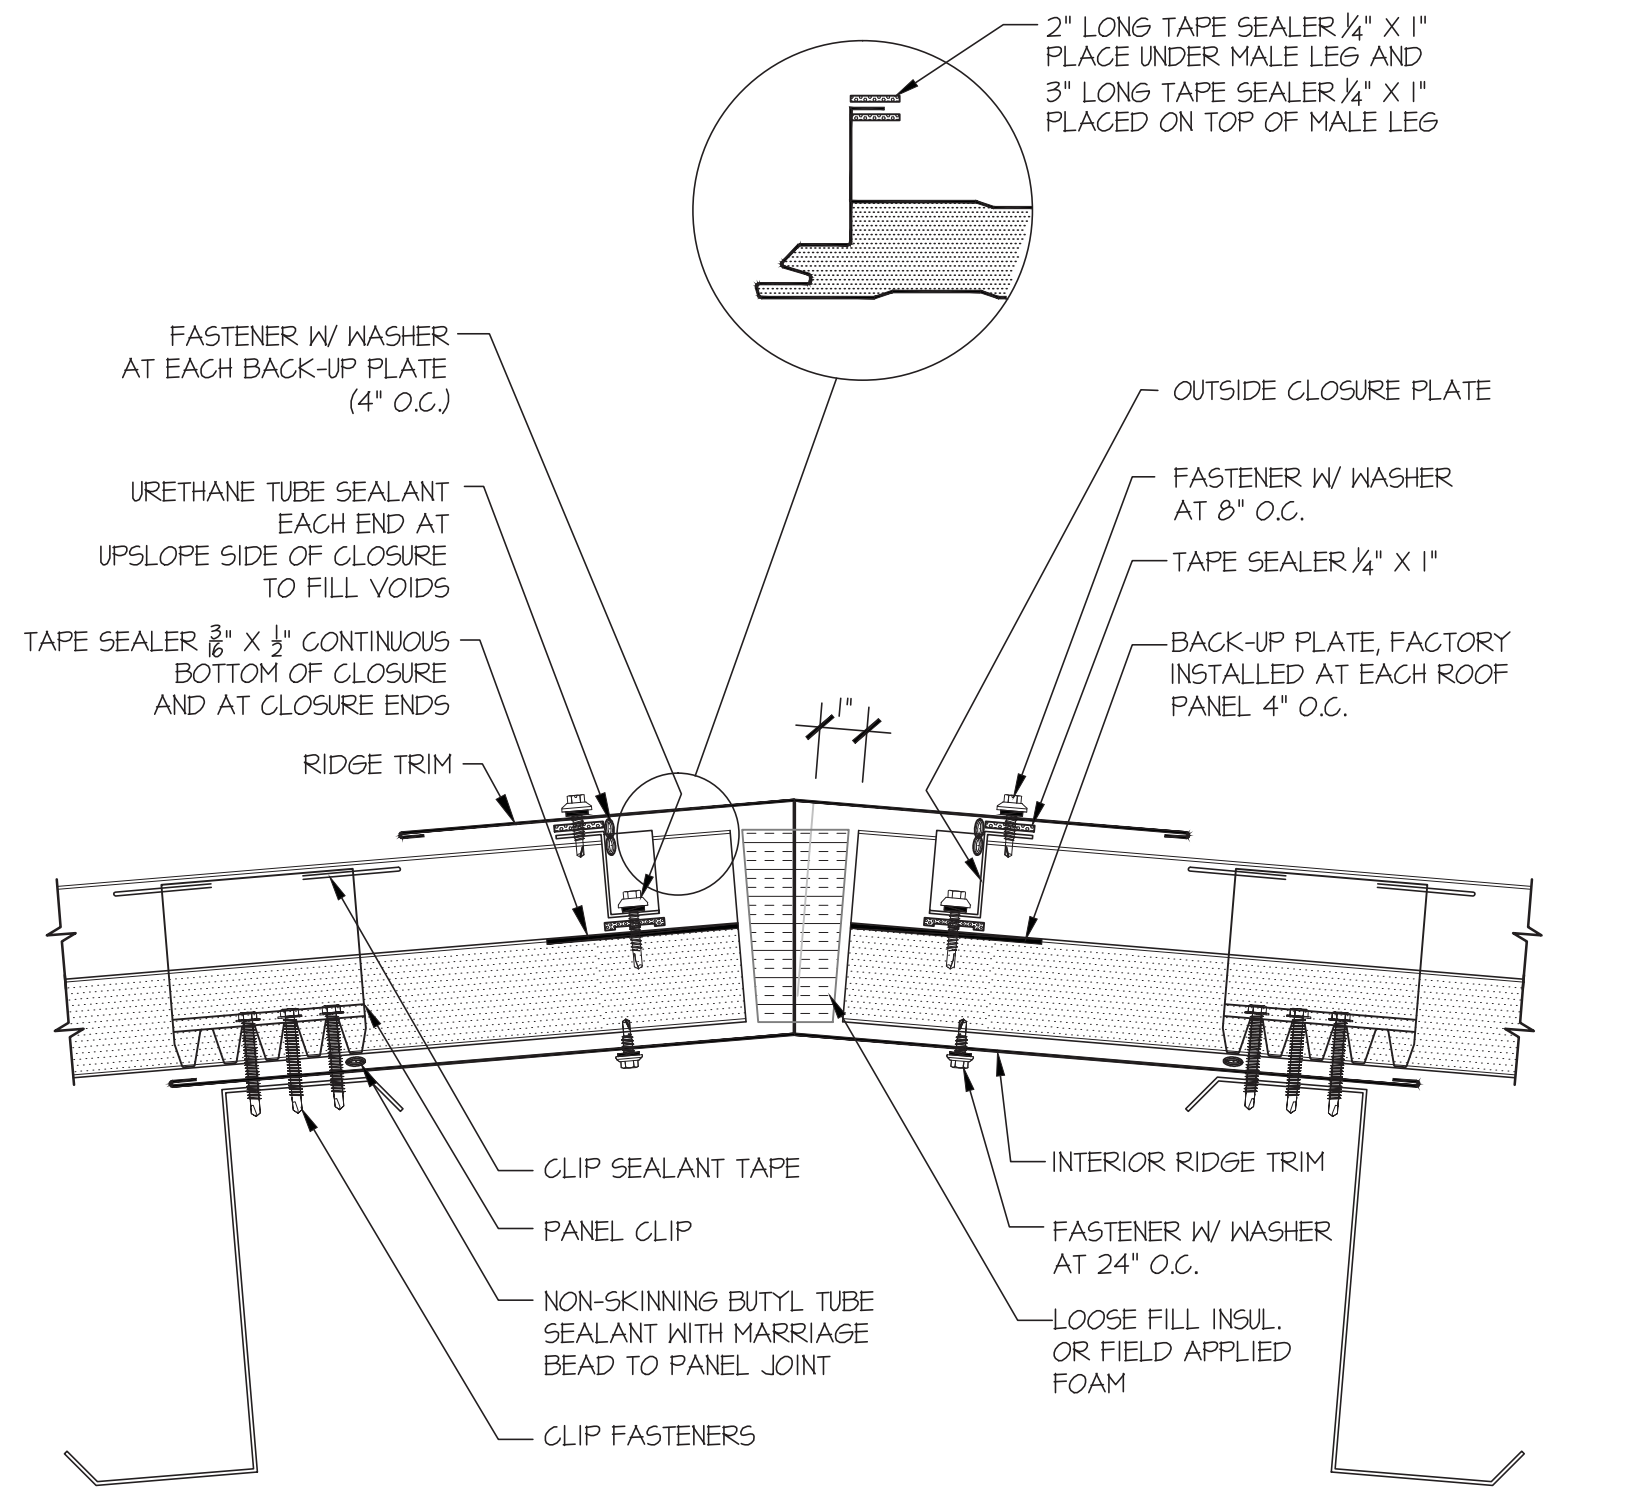

2 ROOF PANEL @ RIDGE DETAIL
SCALE : N.T.S.

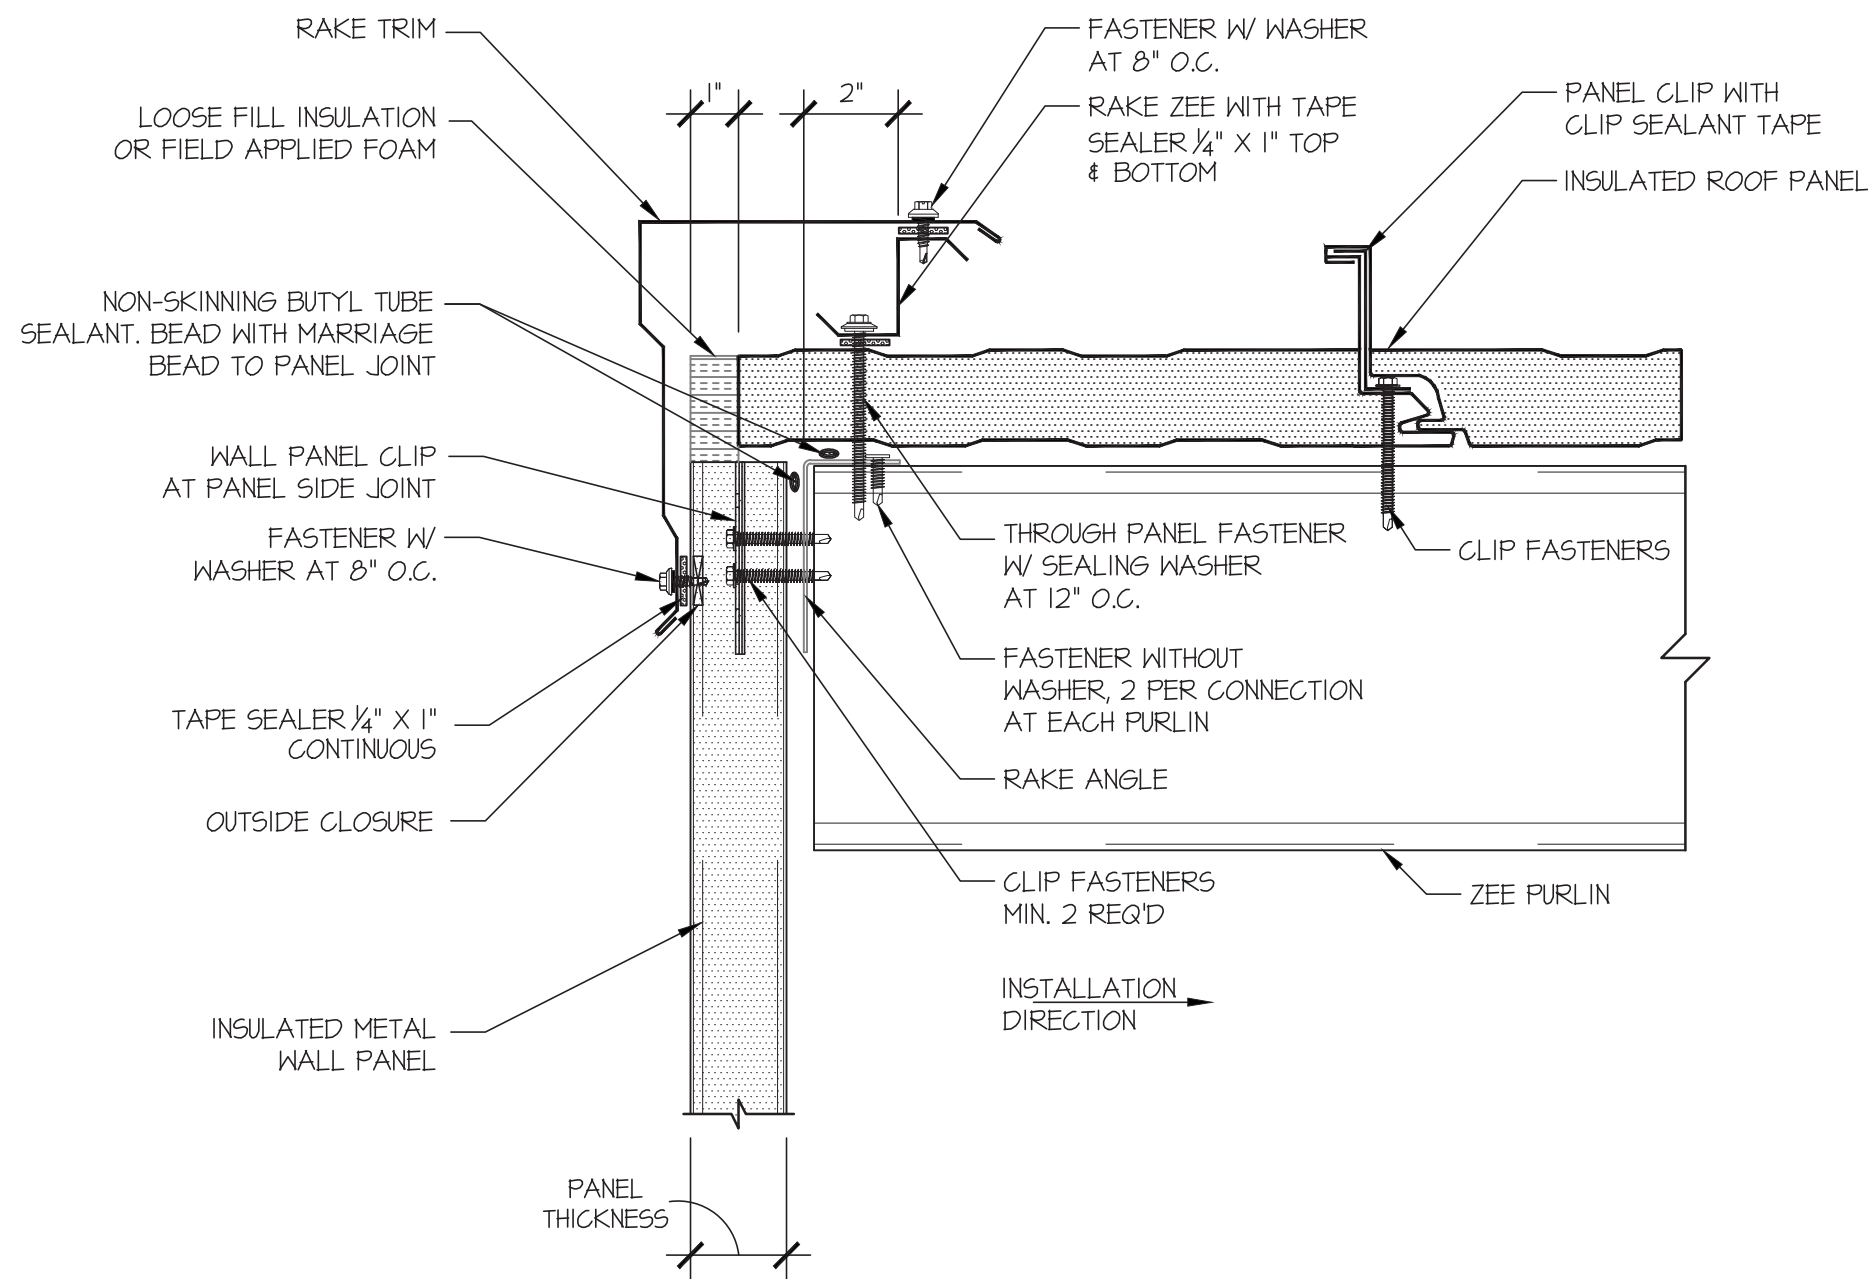

3 ROOF PANEL @ STANDARD RAKE DETAIL
SCALE : N.T.S.



FLOOR PLAN AND SECTION INFORMATION DERIVED FROM: CITY OF NEWARK, WATER TREATMENT FACILITIES PLANT, CONTRACT W-90-1* PREPARED BY TATMAN & LEE ASSOCIATES, INC. DATED 10/1/1990

CURTIS WATER TREATMENT PLANT
IMPROVEMENTS
215 PAPER MILL ROAD
NEWARK, DELAWARE
ROOF PANEL DETAILS
CITY OF NEWARK DEPT. OF PUBLIC WORKS AND WATER RESOURCES
220 SOUTH MAIN STREET
NEWARK, DELAWARE 19711

NO.	DATE	REVISIONS	BY


PROJECT	CNEW1612
DATE	APRIL 2017
DRAWING SCALE	AS SHOWN
DRAWN BY	RG ARCHITECTS
APPROVED BY	RG ARCHITECTS

A3201
SHEET 15 OF 54


PENNONI ASSOCIATES INC.
Christiana Executive Campus
121 Continental Drive, Suite 207
Newark, DE 19713-4310
T 302.655.4451 F 302.654.2895

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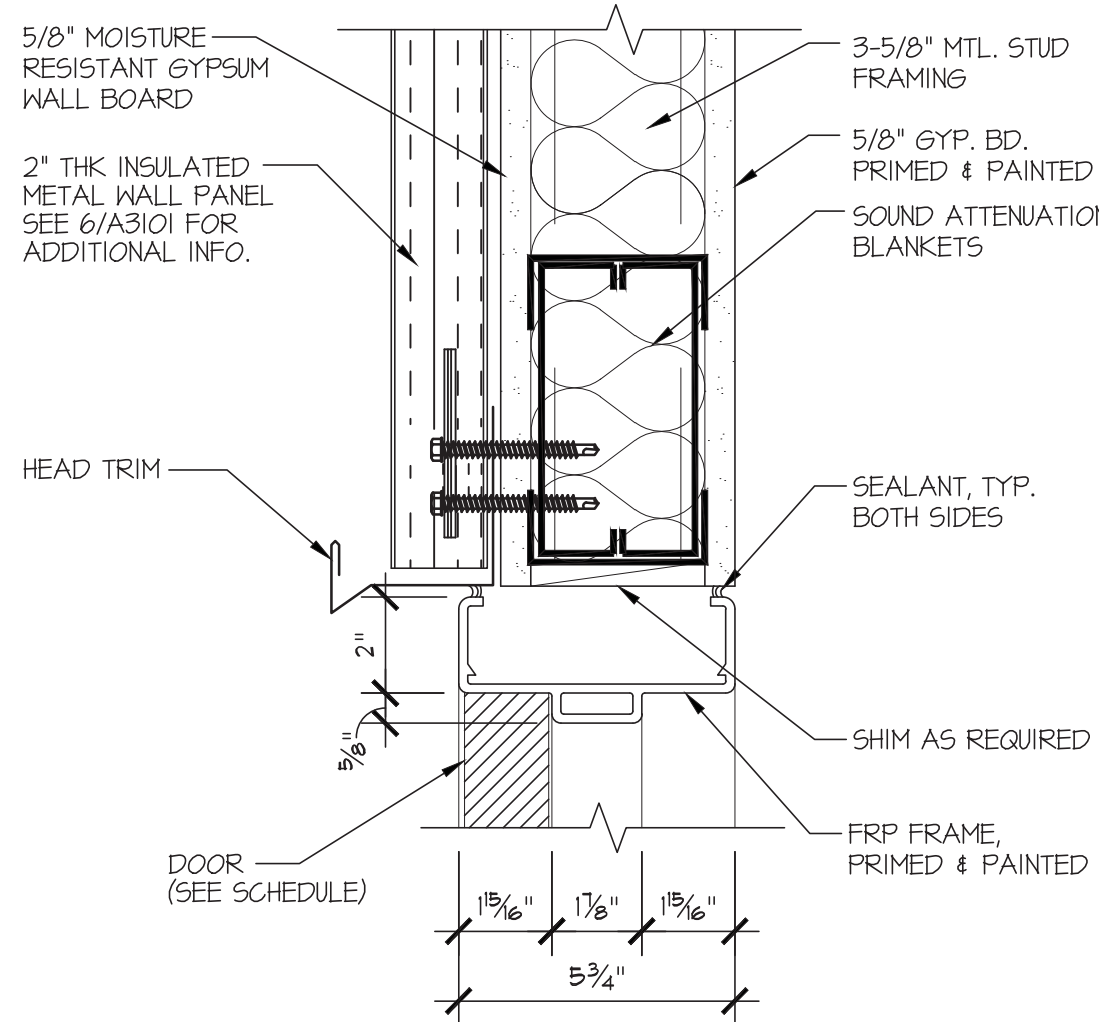
PROJECT STATUS: CONSTRUCTION PLANS
PROJECT: CNEW1612-101 Code WTP Improvements/SECTION 10000 - Building
RUSTY: 4/22/2017 2:25 PM BY: Ryan Miller
RUSTY: 4/22/2017 2:25 PM BY: Ryan Miller

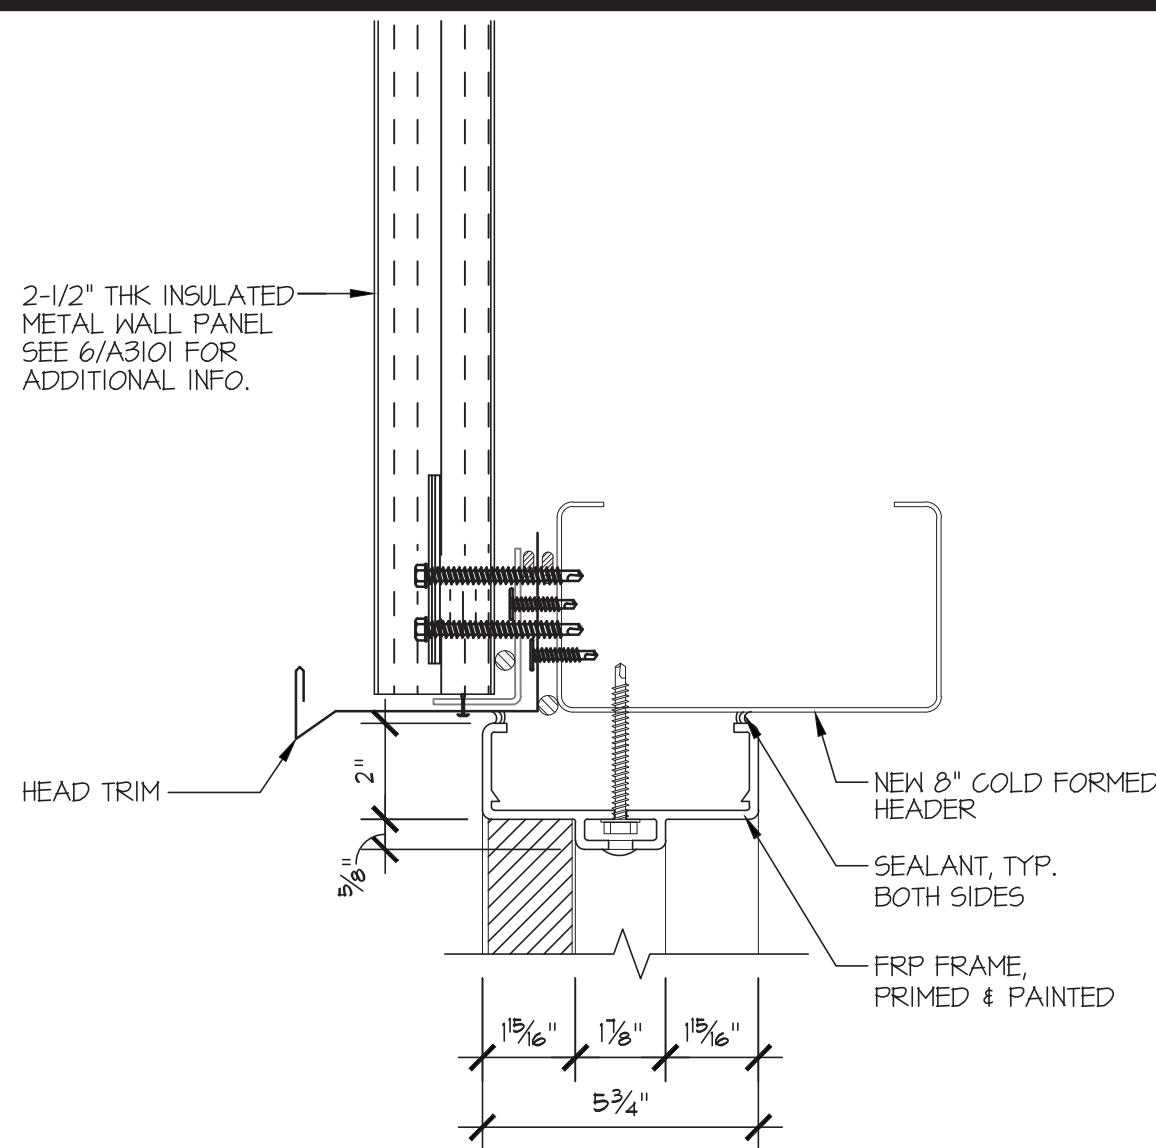


H1 HEAD DETAIL
SCALE: 3" = 1'-0"

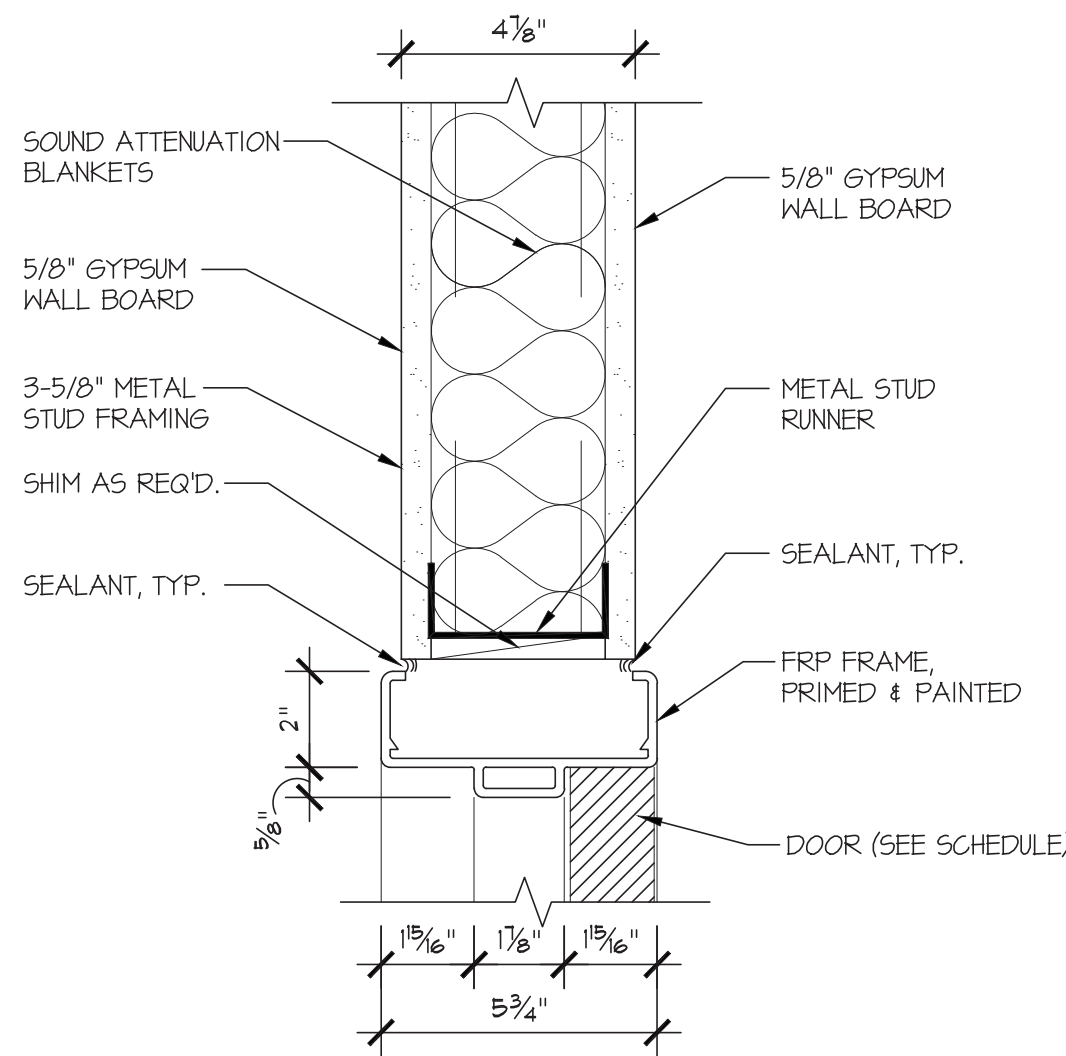


H2 HEAD DETAIL
SCALE: 3" = 1'-0"




H3 HEAD DETAIL
SCALE: 3" = 1'-0"

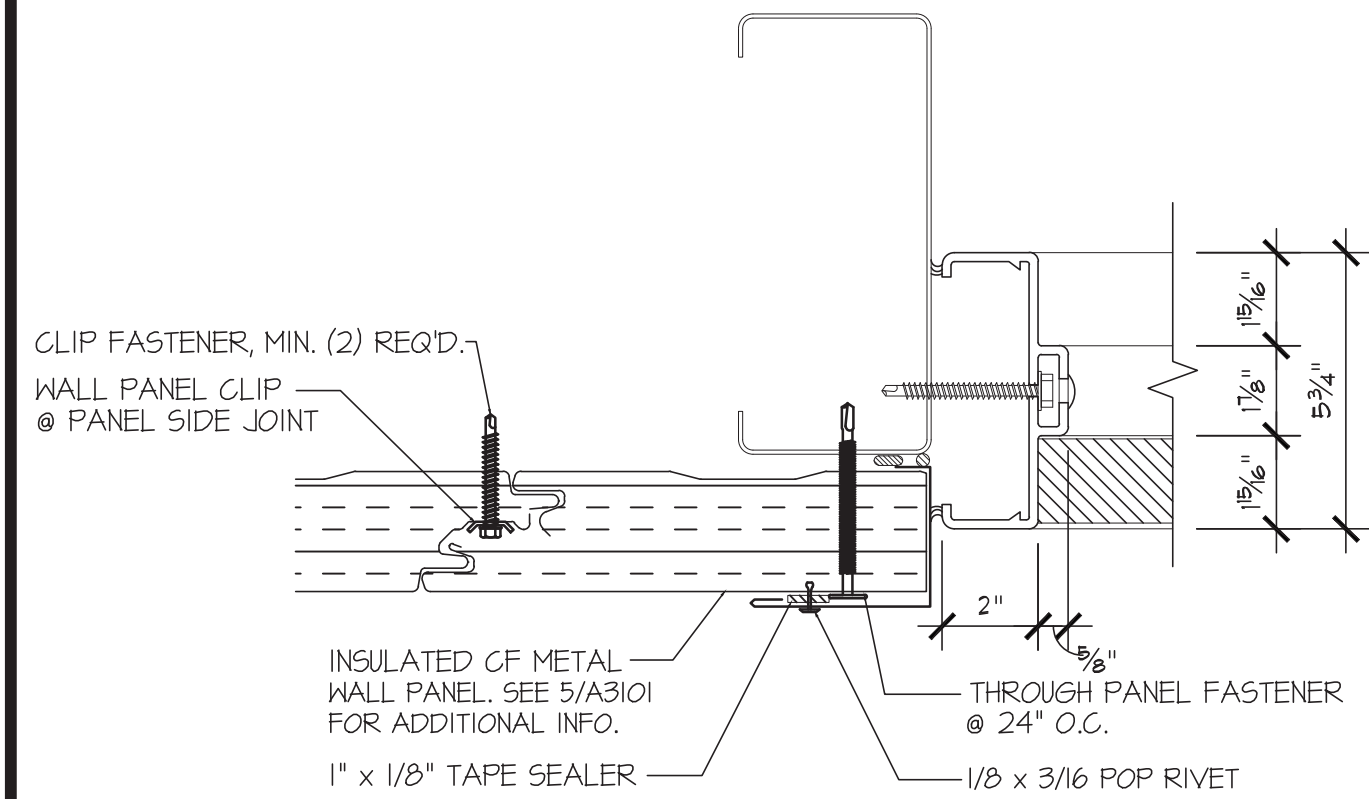


J1 JAMB DETAIL
SCALE: 3" = 1'-0"

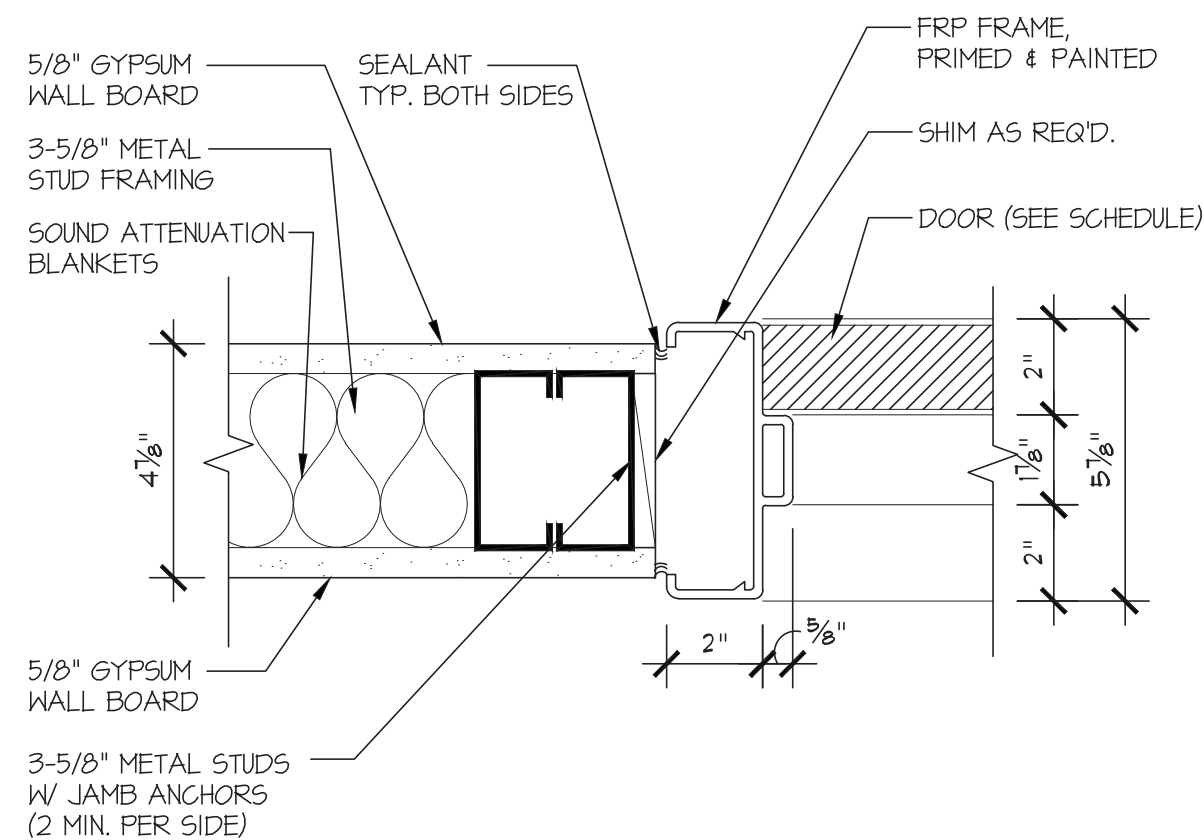


J2 JAMB DETAIL
SCALE: 3" = 1'-0"

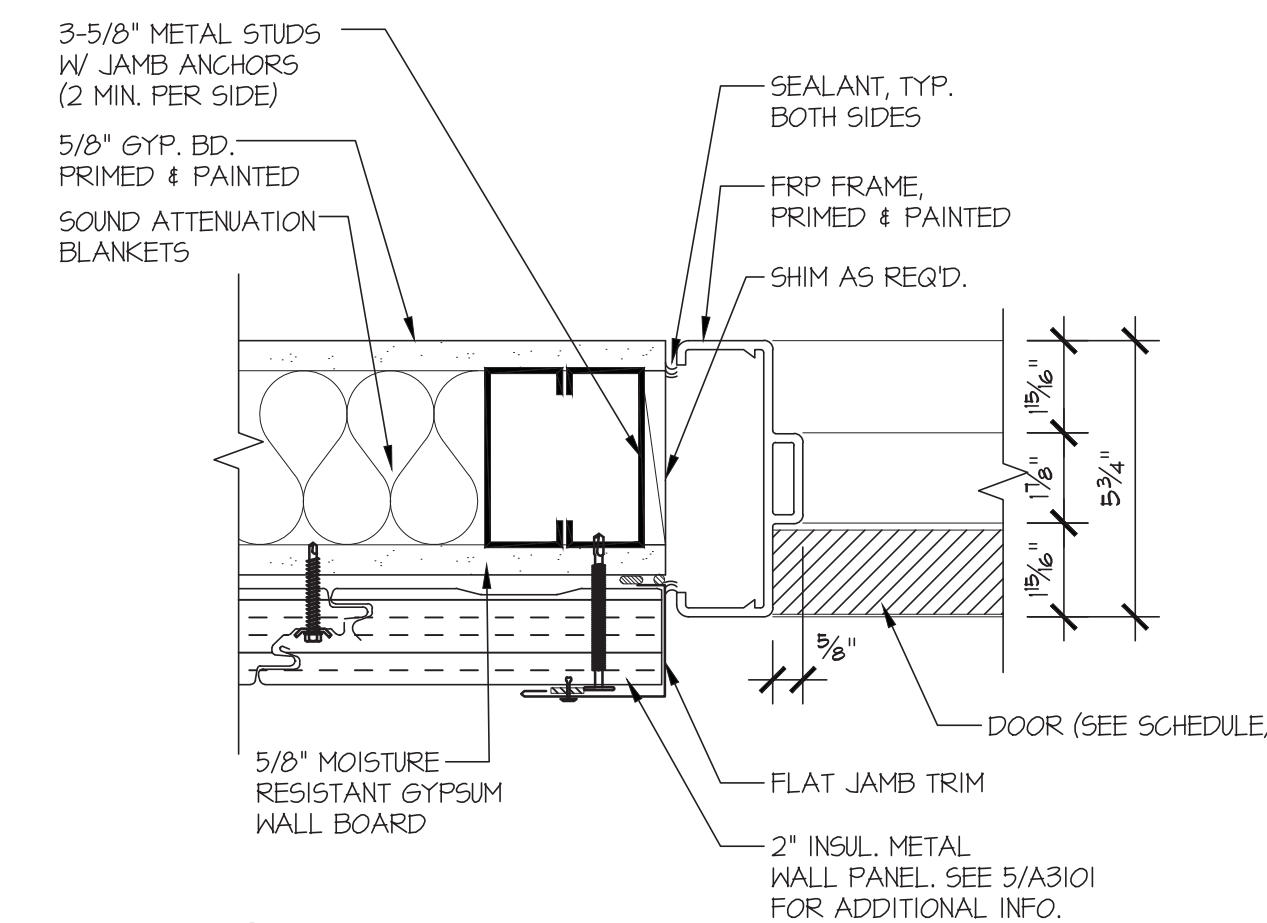

J3 JAMB DETAIL
SCALE: 3" = 1'-0"

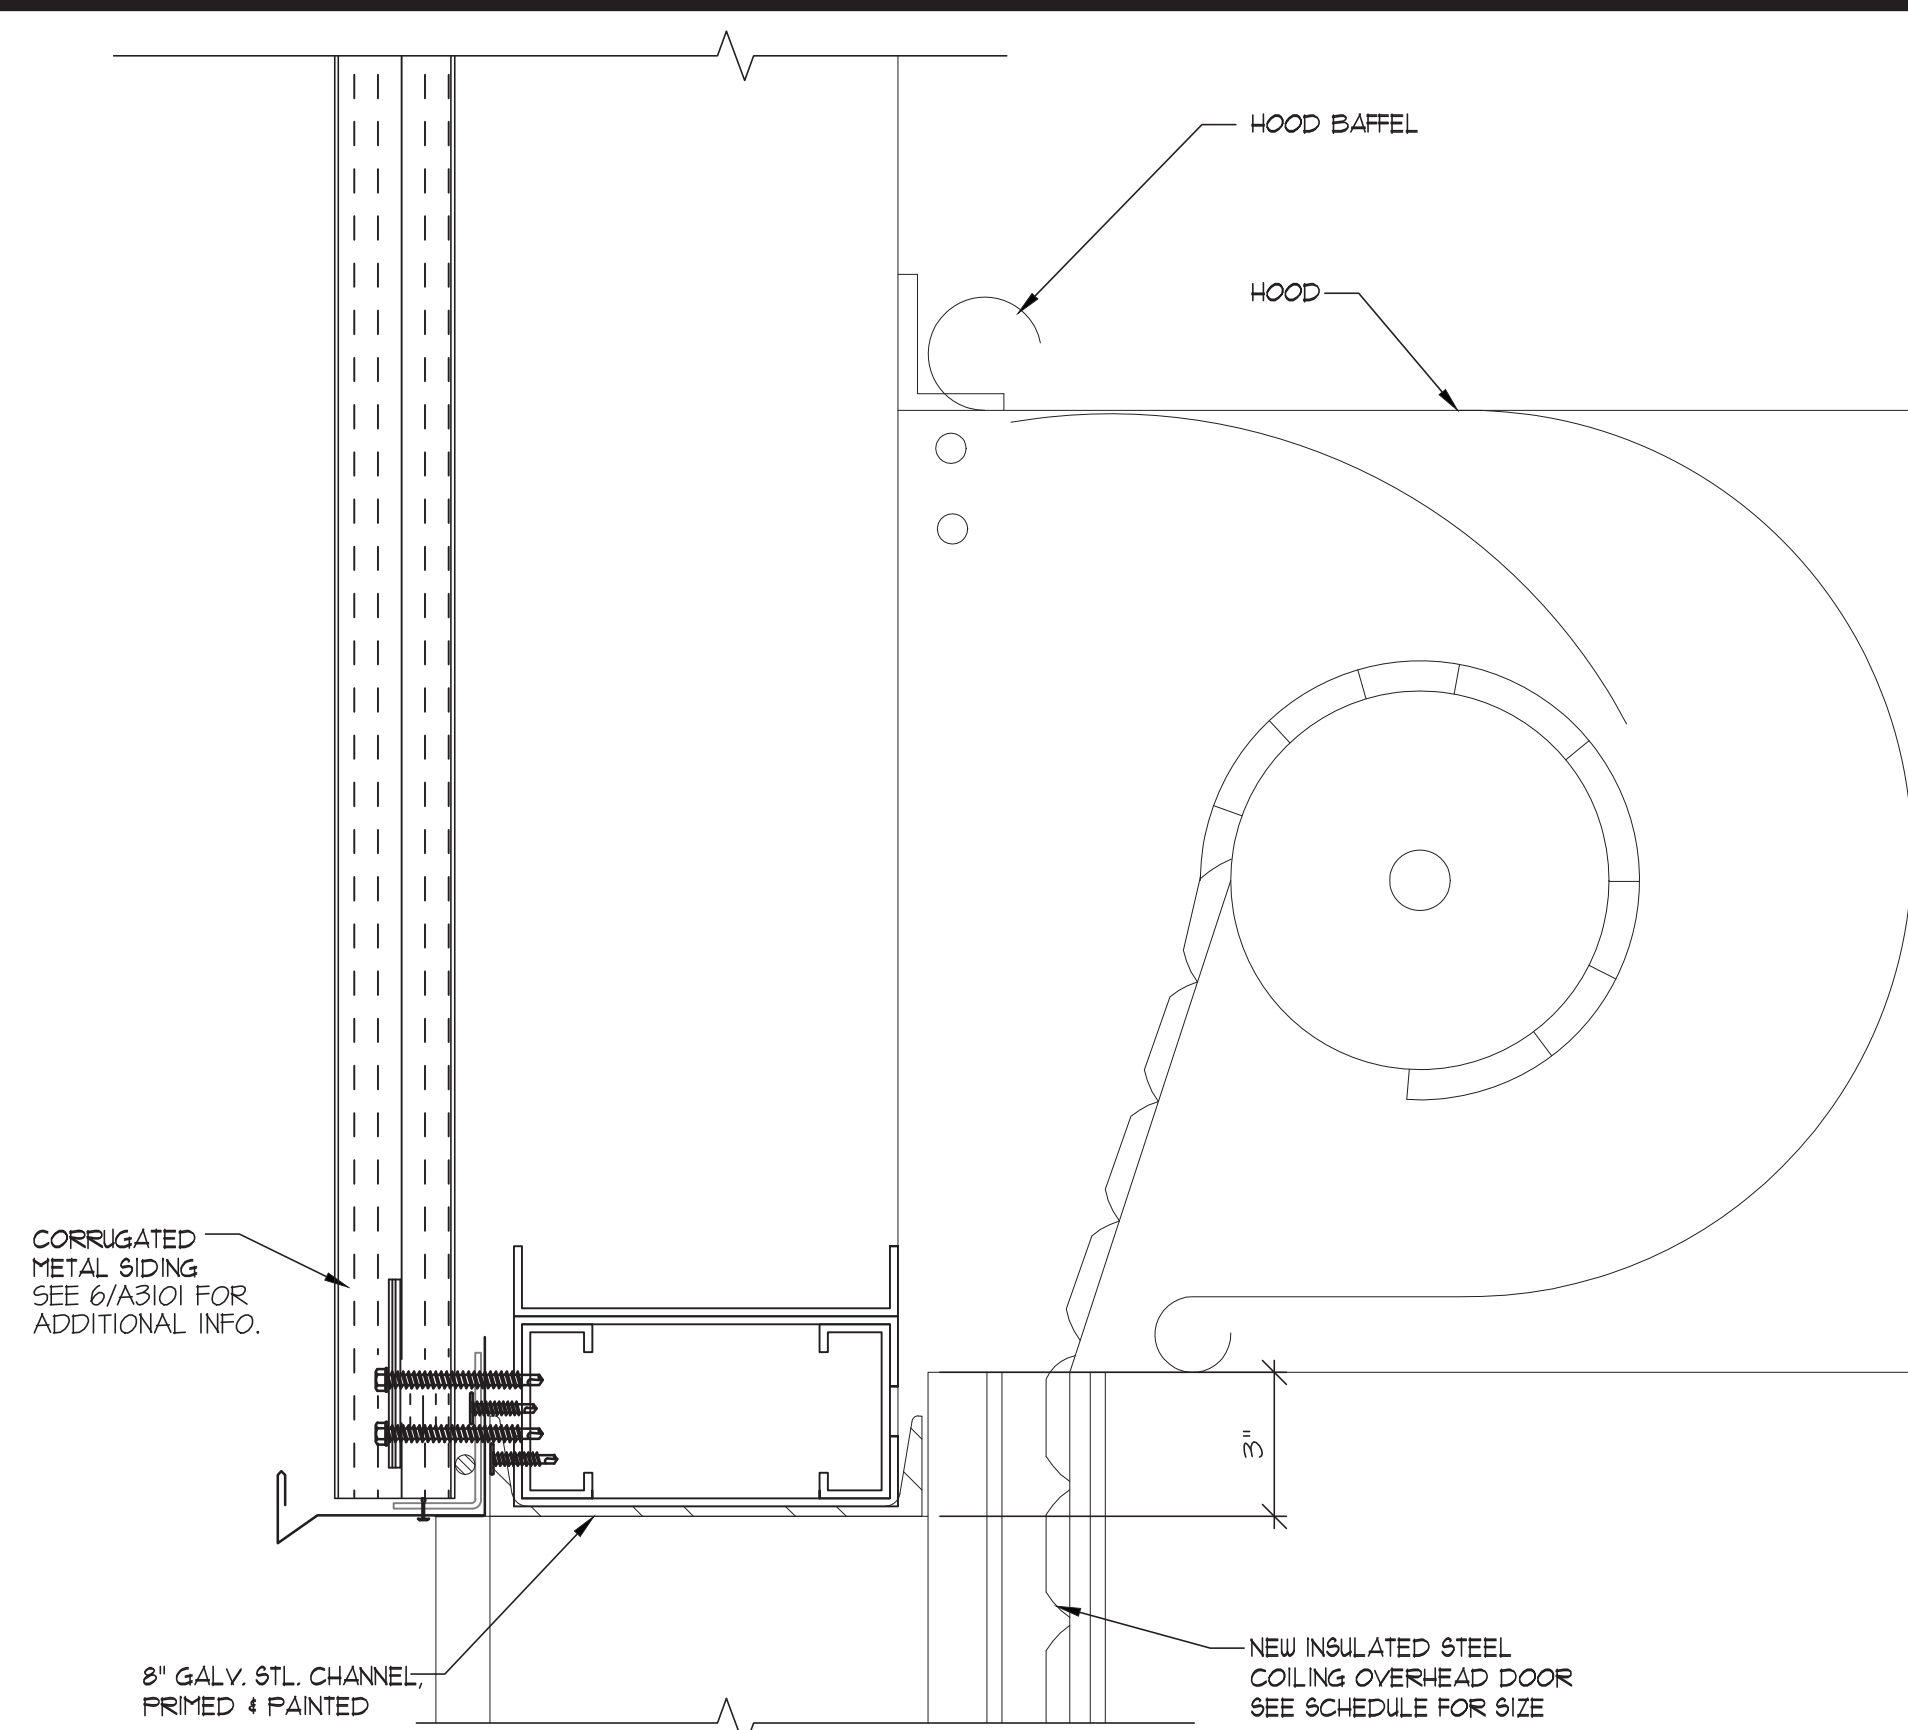


H6 HEAD DETAIL
SCALE: 3" = 1'-0"

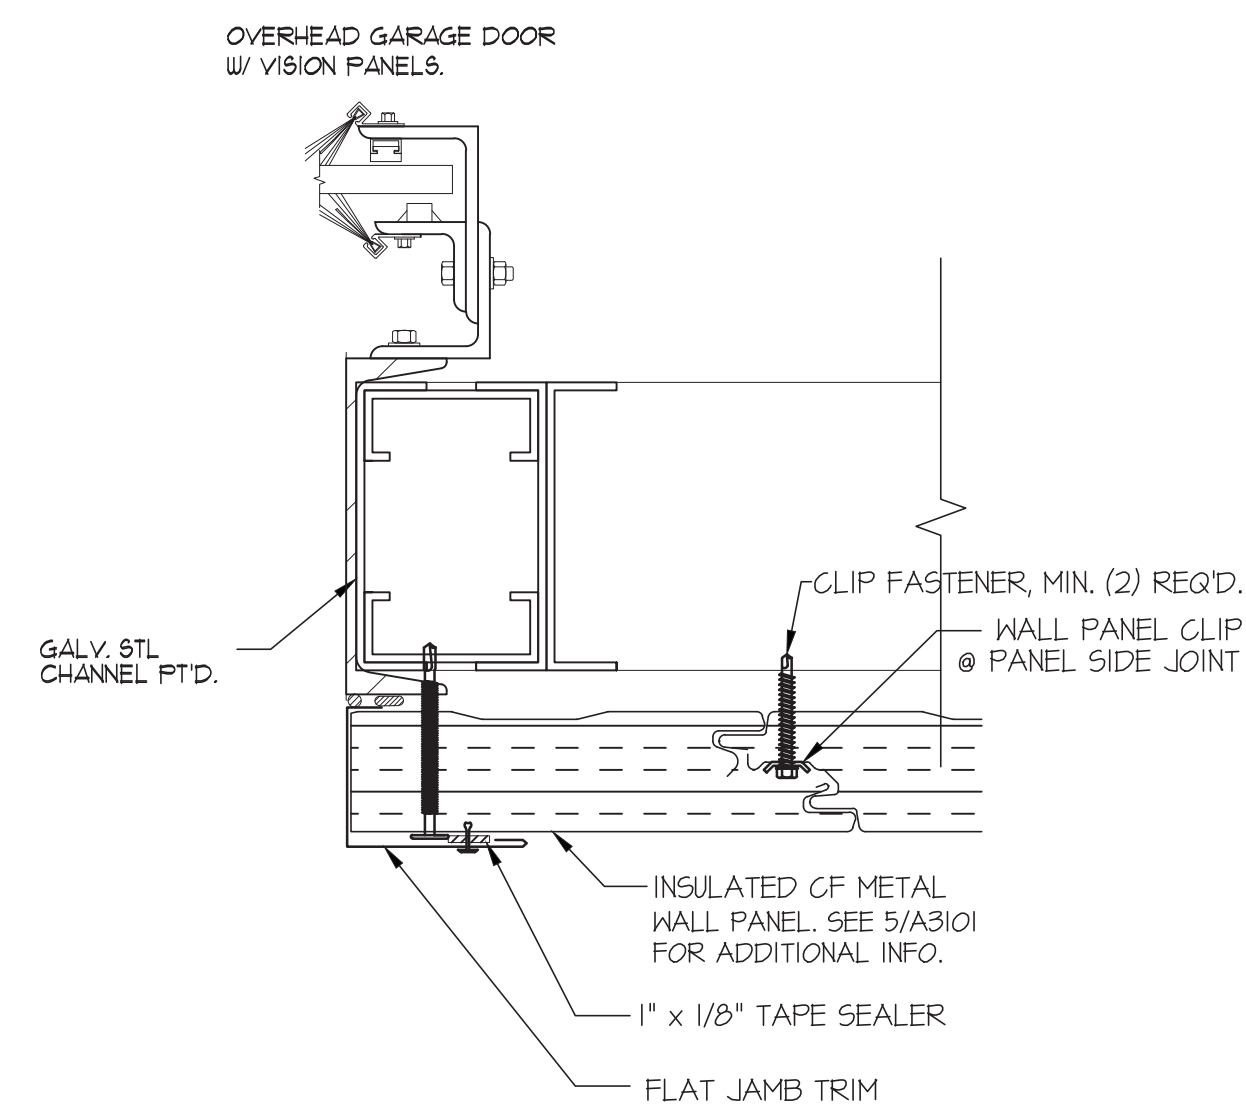

J6 JAMB DETAIL
SCALE: 3" = 1'-0"

DOOR SCHEDULE													
EXTERIOR DOOR	ACCESS CONTROL HARDWARE SET	MARK	SIZE	THICK	TYPE				DETAILS			FIRE RATING IN MINUTES	REMARKS
					DOOR TYPE	MTL.	FRAME TYPE	MTL.	H	J	S		
●	1	100	(2) 4'-0" x 10'-0"	1 3/4"	D1	FRP	FI	FRP	H1	J1	-	-	MONORAIL CUTOUT
●	2	101	3'-0" x 7'-0"	1 3/4"	D3	FRP	FI	FRP	H1	J1	-	-	-
	5	102	3'-0" x 7'-0"	1 3/4"	D1	FRP	FI	FRP	H3	J3	-	-	-
	5	103	3'-0" x 7'-0"	1 3/4"	D3	FRP	FI	FRP	H3	J3	-	-	-
●	2	104	3'-0" x 7'-0"	1 3/4"	D3	FRP	FI	FRP	H1	J1	-	-	-
●	-	105	10'-0" x 12'-0"	1 3/4"	D4	STL	F-	STL	H6	J6	-	-	ELECTRICALLY OPERATED ROLL-UP
●	-	106	10'-0" x 12'-0"	1 3/4"	D4	STL	F-	STL	H6	J6	-	-	ELECTRICALLY OPERATED ROLL-UP
●	2	200	3'-0" x 7'-0"	1 3/4"	D2	FRP	FI	FRP	H1	J1	-	-	-
	4	201	3'-0" x 7'-0"	1 3/4"	D2	FRP	FI	FRP	H3	J3	-	-	-
	4	202	3'-0" x 7'-0"	1 3/4"	D2	FRP	FI	FRP	H2	J2	-	-	-
	3	203	3'-0" x 7'-0"	1 3/4"	D1	FRP	FI	FRP	H2	J2	-	-	-

GENERAL NOTES DOORS, FRAMES & HARDWARE										KEY:	
1. INTERIOR DOOR CLOSERS MUST BE SET NO HIGHER THAN 5 POUNDS OF PRESSURE TO OPERATE (TYP. FOR INTERIOR NON-RATED DOORS ONLY).										ALUM	ALUMINUM
2. OPENING HARDWARE IS CENTERED A MAXIMUM OF 48" ABOVE FINISH FLOOR.										HM	HOLLOW METAL
3. MINIMUM STRIKE SIDE CLEARANCE ON FULL SIDE OF DOOR:										WD	WOOD
A. 24" MIN. EXTERIOR DOORS.										FRP	FIBERGLASS REINFORCED PANEL
B. 18" MIN. INTERIOR DOORS, FRONT APPROACH.										STL	STAINLESS STEEL
C. 36" MIN. INTERIOR DOORS, HINGE APPROACH (IF CORRIDOR IS 60" MINIMUM).											
D. 42" MIN. INTERIOR DOORS, HINGE APPROACH (IF CORRIDOR IS LESS THAN 60", BUT GREATER THAN 54").											
E. 24" MIN. INTERIOR DOORS, LATCH APPROACH.											
4. MINIMUM STRIKE SIDE CLEARANCE ON PUSH SIDE OF DOOR:											
A. 0" FRONT APPROACH.											
B. 12" MIN. FRONT APPROACH W/LATCH AND CLOSER.											
C. 54" MIN. TOTAL WIDTH, HINGE APPROACH.											
D. 24" MIN. LATCH APPROACH.											
5. DOOR CLOSERS MUST BE SET SO THAT IT TAKES AT LEAST 3 SECONDS TO CLOSE FROM AN OPEN POSITION OF 70° TO WITHIN 3° OF THE LATCH.											
6. ALL WIRING CONDUIT IDENTIFIED ON THE DRAWINGS, OR REQUIRED FOR THE INSTALLATION OF ELECTRONIC COMPONENTS, THAT IS WITHIN HOLLOW METAL FRAMES SHALL BE PROVIDED AS PART OF THE HOLLOW METAL FRAME, WITH TERMINATIONS APPROPRIATE FOR EXTENSION BY OTHER TRADES, G.C. COORD.											
7. SEE SPECIFICATIONS FOR DOOR HARDWARE SETS, TYP.											

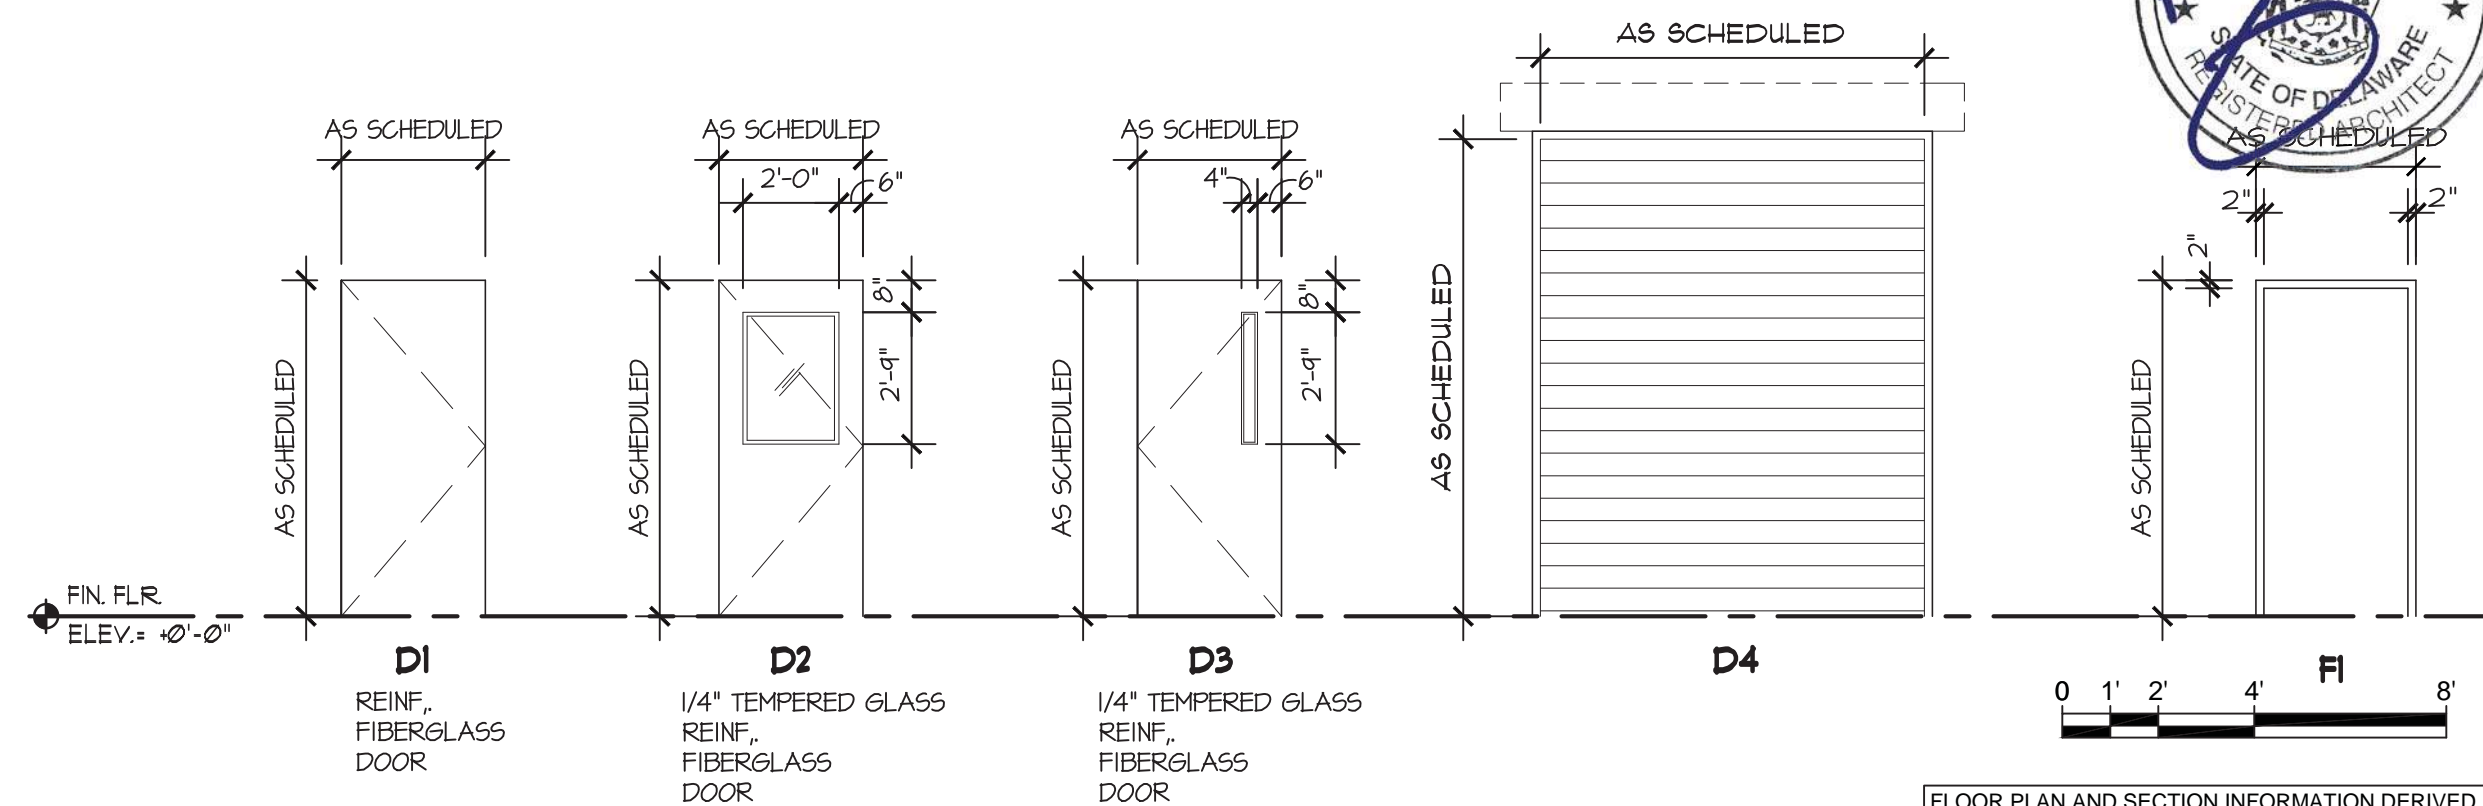

FLOOR PLAN AND SECTION INFORMATION DERIVED FROM: CITY OF NEWARK, WATER TREATMENT FACILITIES PLANT, CONTRACT W-90-11 PREPARED BY TATMAN & LEE ASSOCIATES, INC. DATED 10/1/1990









CURTIS WATER TREATMENT PLANT IMPROVEMENTS
WINDOW & DOOR DETAILS
215 PAPER MILL ROAD
NEWARK, DELAWARE
CITY OF NEWARK DEPT. OF PUBLIC WORKS AND WATER RESOURCES
220 SOUTH MAIN STREET
NEWARK, DELAWARE 19711

NO.	DATE	BY	REVISIONS

PROJECT	CNEW1612
DATE	APRIL 2017
DRAWING SCALE	AS SHOWN
DRAWN BY	RG ARCHITECTS
APPROVED BY	RG ARCHITECTS

ALL DIMENSIONS MUST BE VERIFIED BY CONTRACTOR AND OWNER MUST BE NOTIFIED OF ANY DISCREPANCIES BEFORE PROCEEDING WITH WORK

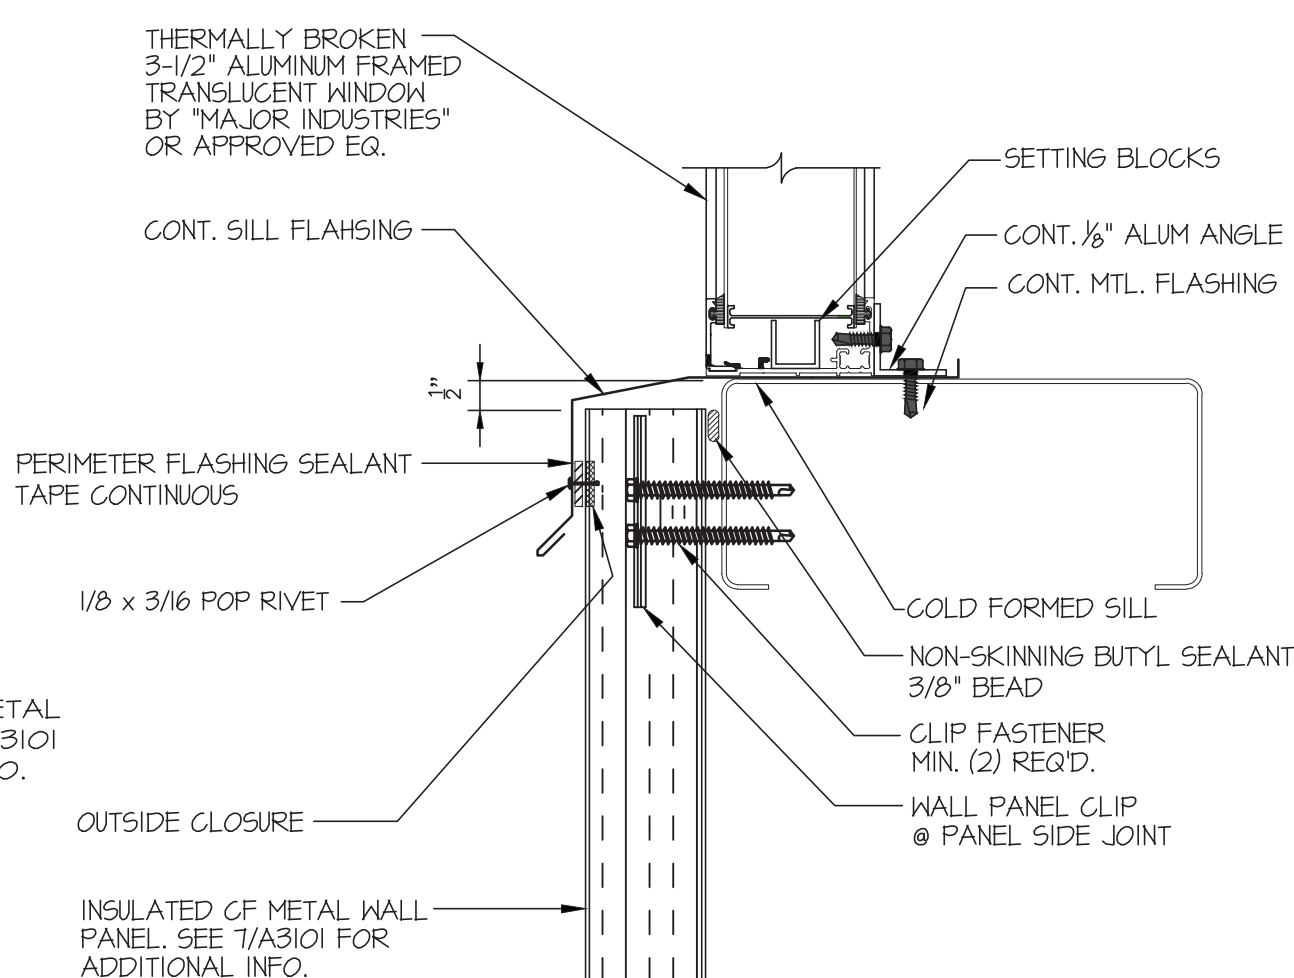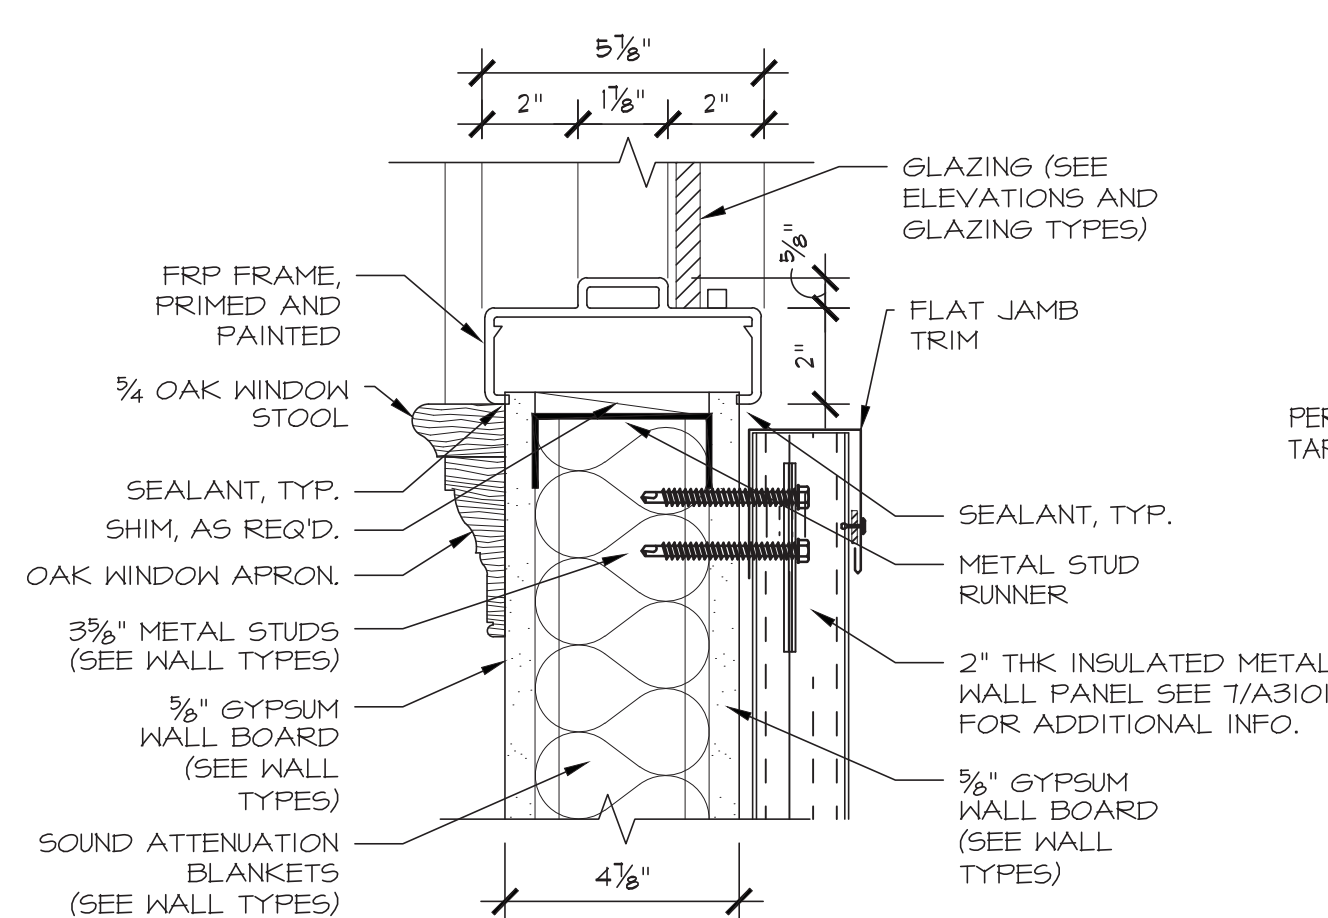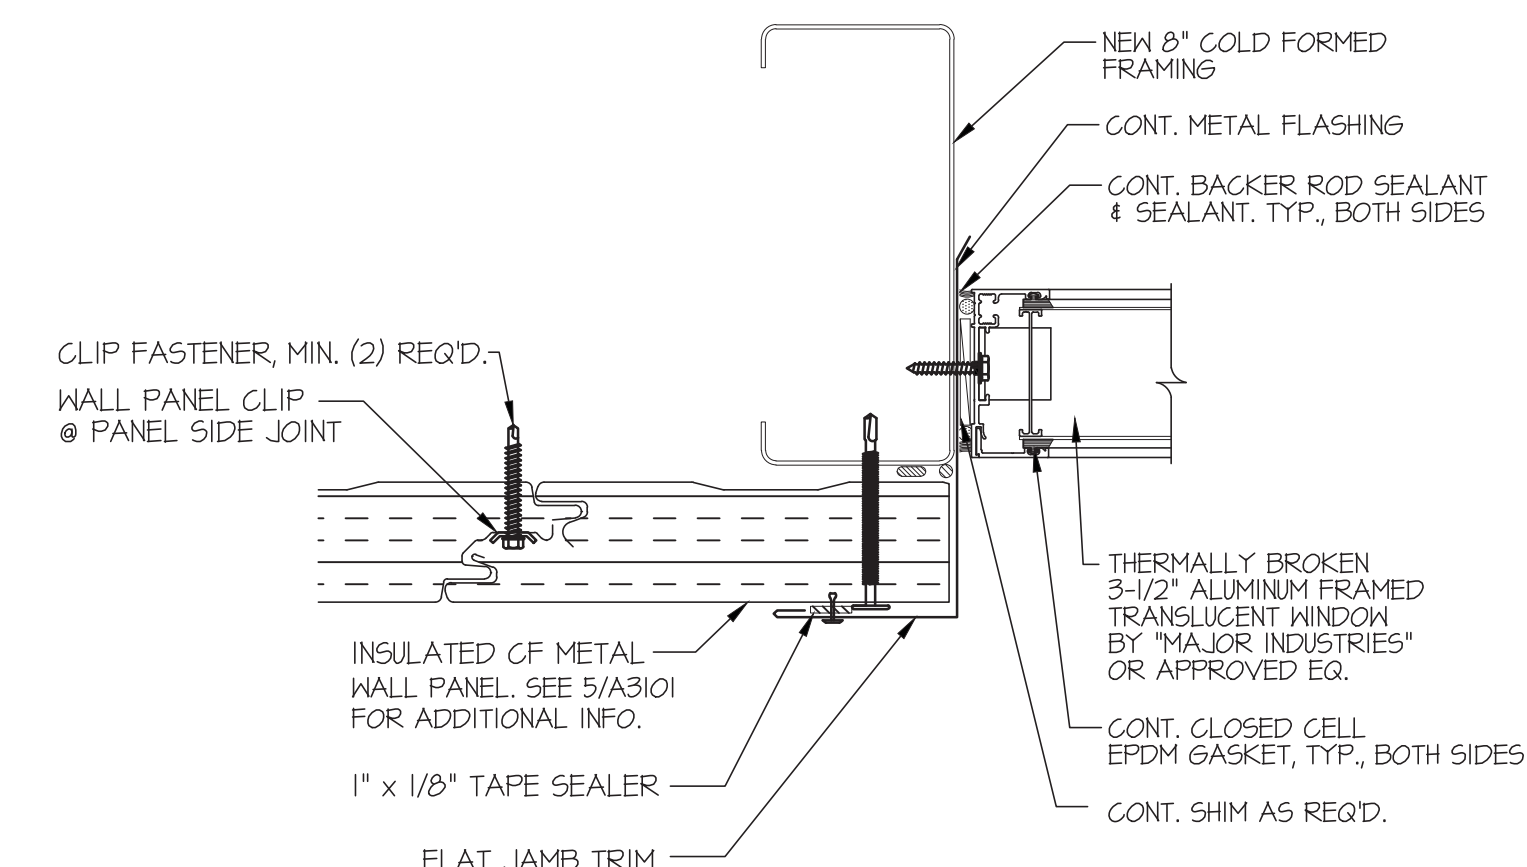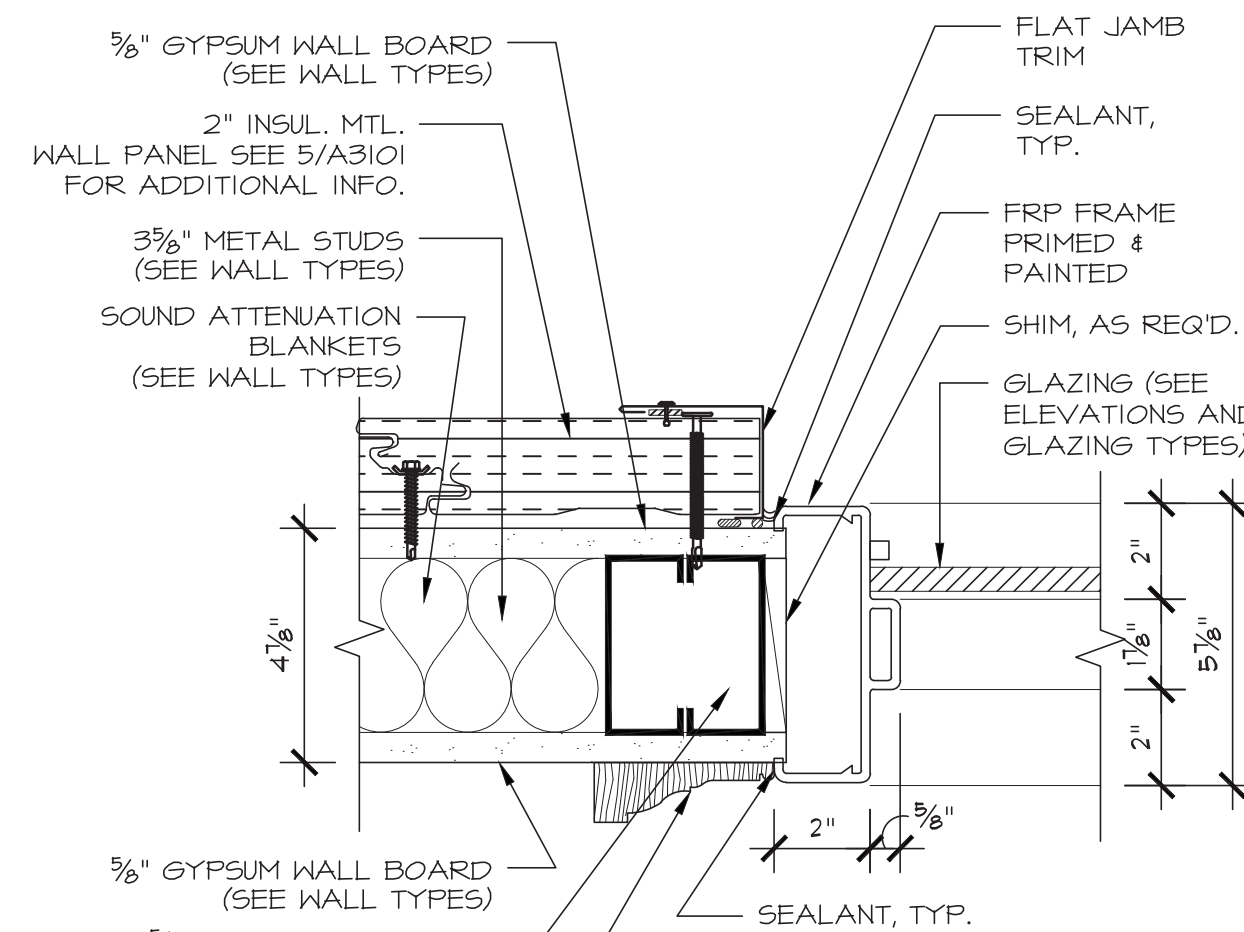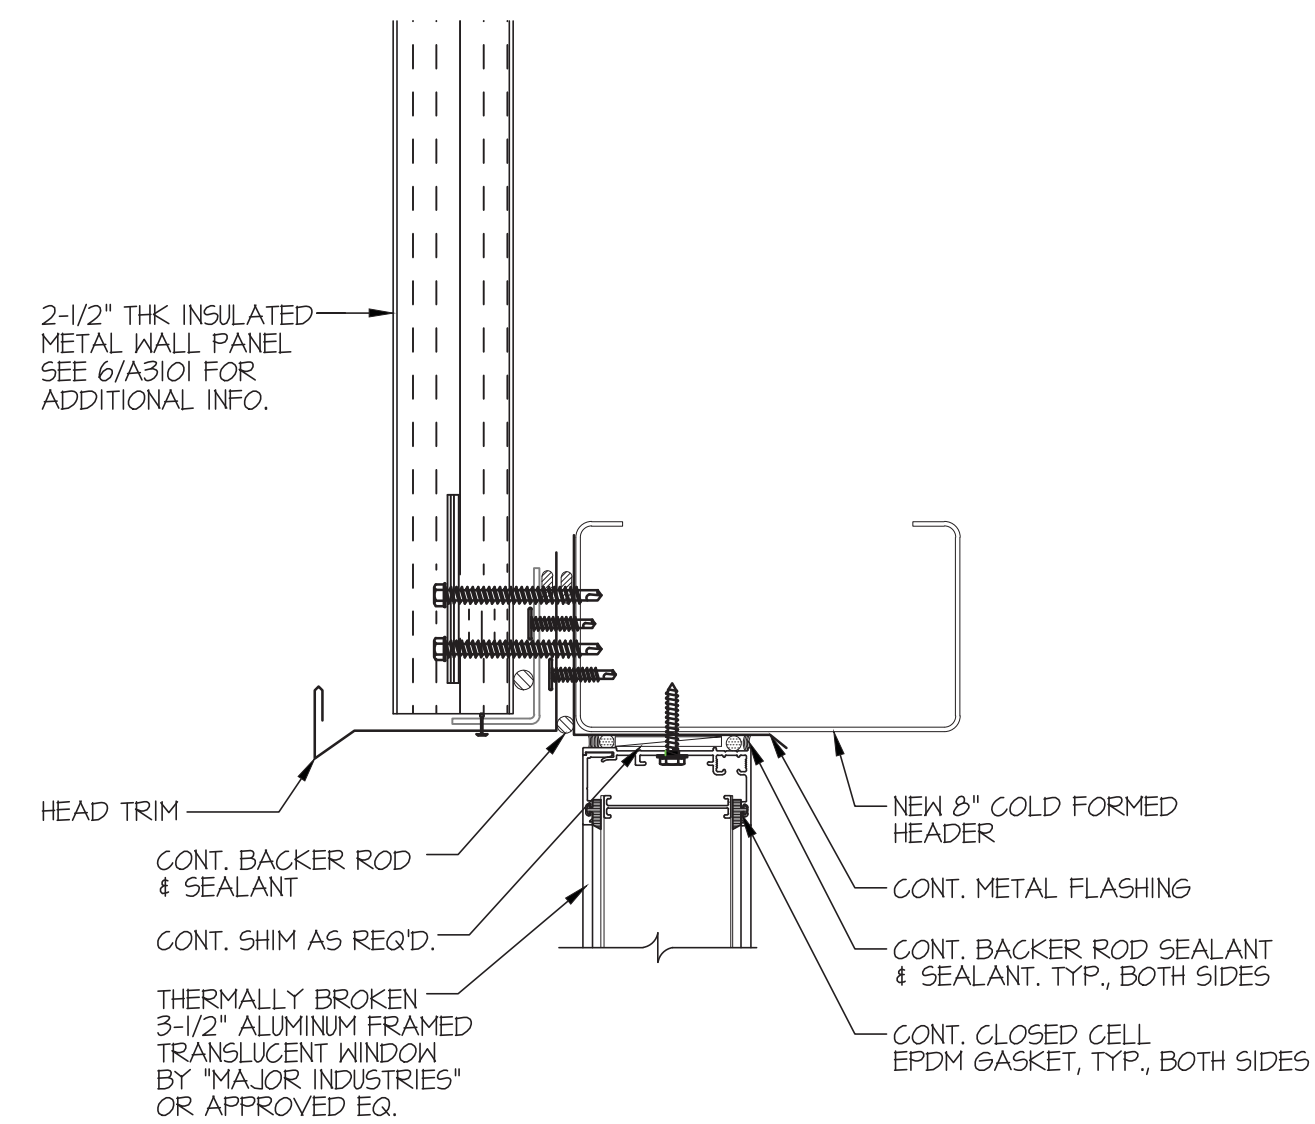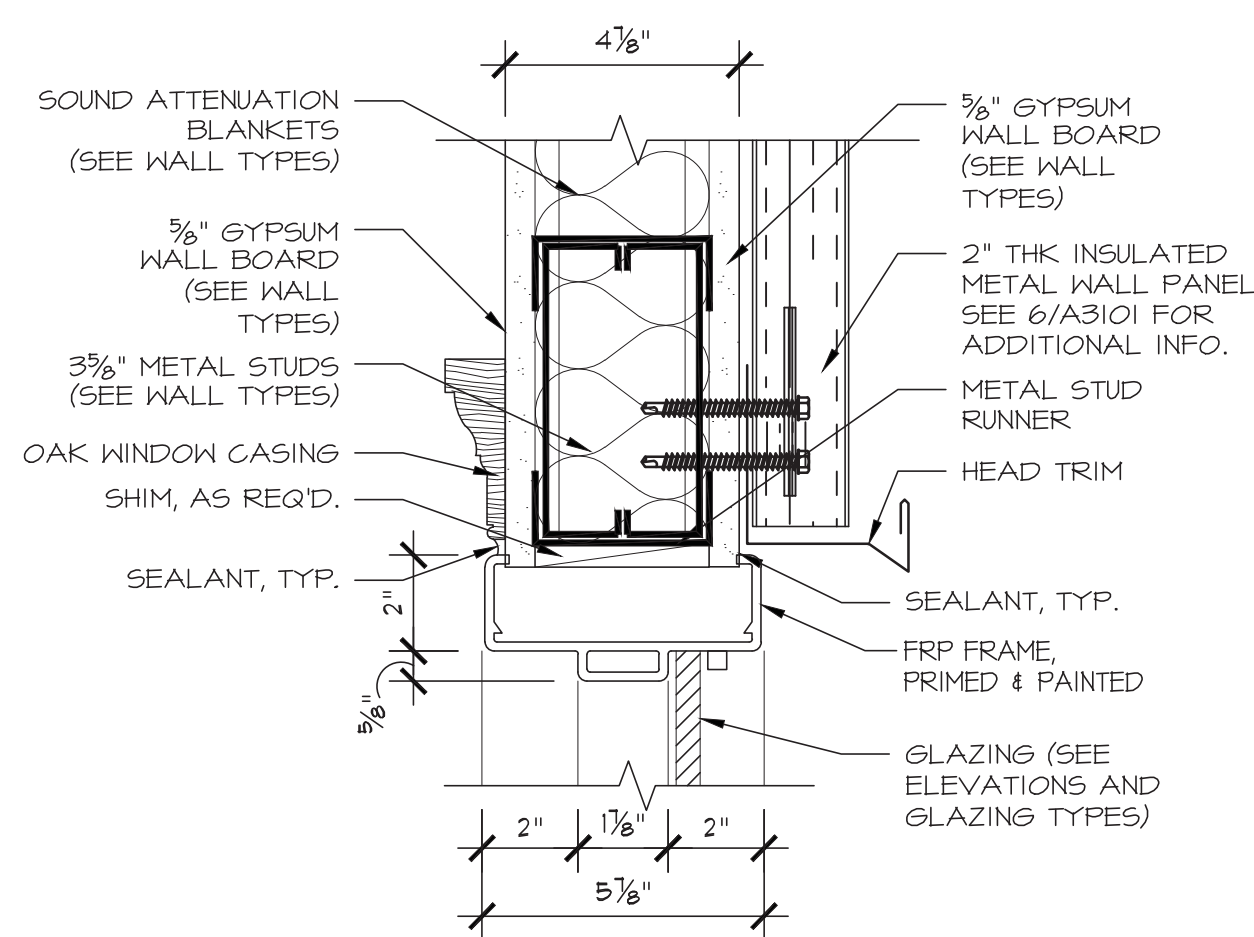

TEMPERED GLASS

PENNONI ASSOCIATES INC.
Christiana Executive Campus
121 Continental Drive, Suite 207
Newark, DE 19713-4310
T 302.655.4451 F 302.654.2895

CITY OF NEWARK DEPT. OF PUBLIC WORKS AND WATER RESOURCES
220 SOUTH MAIN STREET

220 SOUTH MAIN STREET
NEWARK, DELAWARE 19711


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A4002

SHEET 17 OF 54




FLOOR PLAN AND SECTION INFORMATION DERIVED FROM "CITY OF NEWARK, WATER TREATMENT FACILITIES PLANT, CONTRACT W-90-1" PREPARED BY TATMAN & LEE ASSOCIATES, INC. DATED 10/1/1990

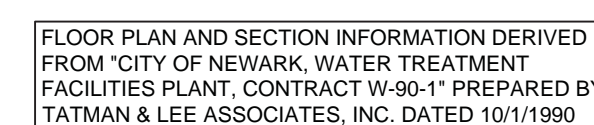


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3 STAIR • STAIR BOTTOM & HANDRAIL ATTACHMENT DETAIL
SCALE : N.T.S.




1 STAIR • WALL ATTACHED DETAIL
SCALE : N.T.S.

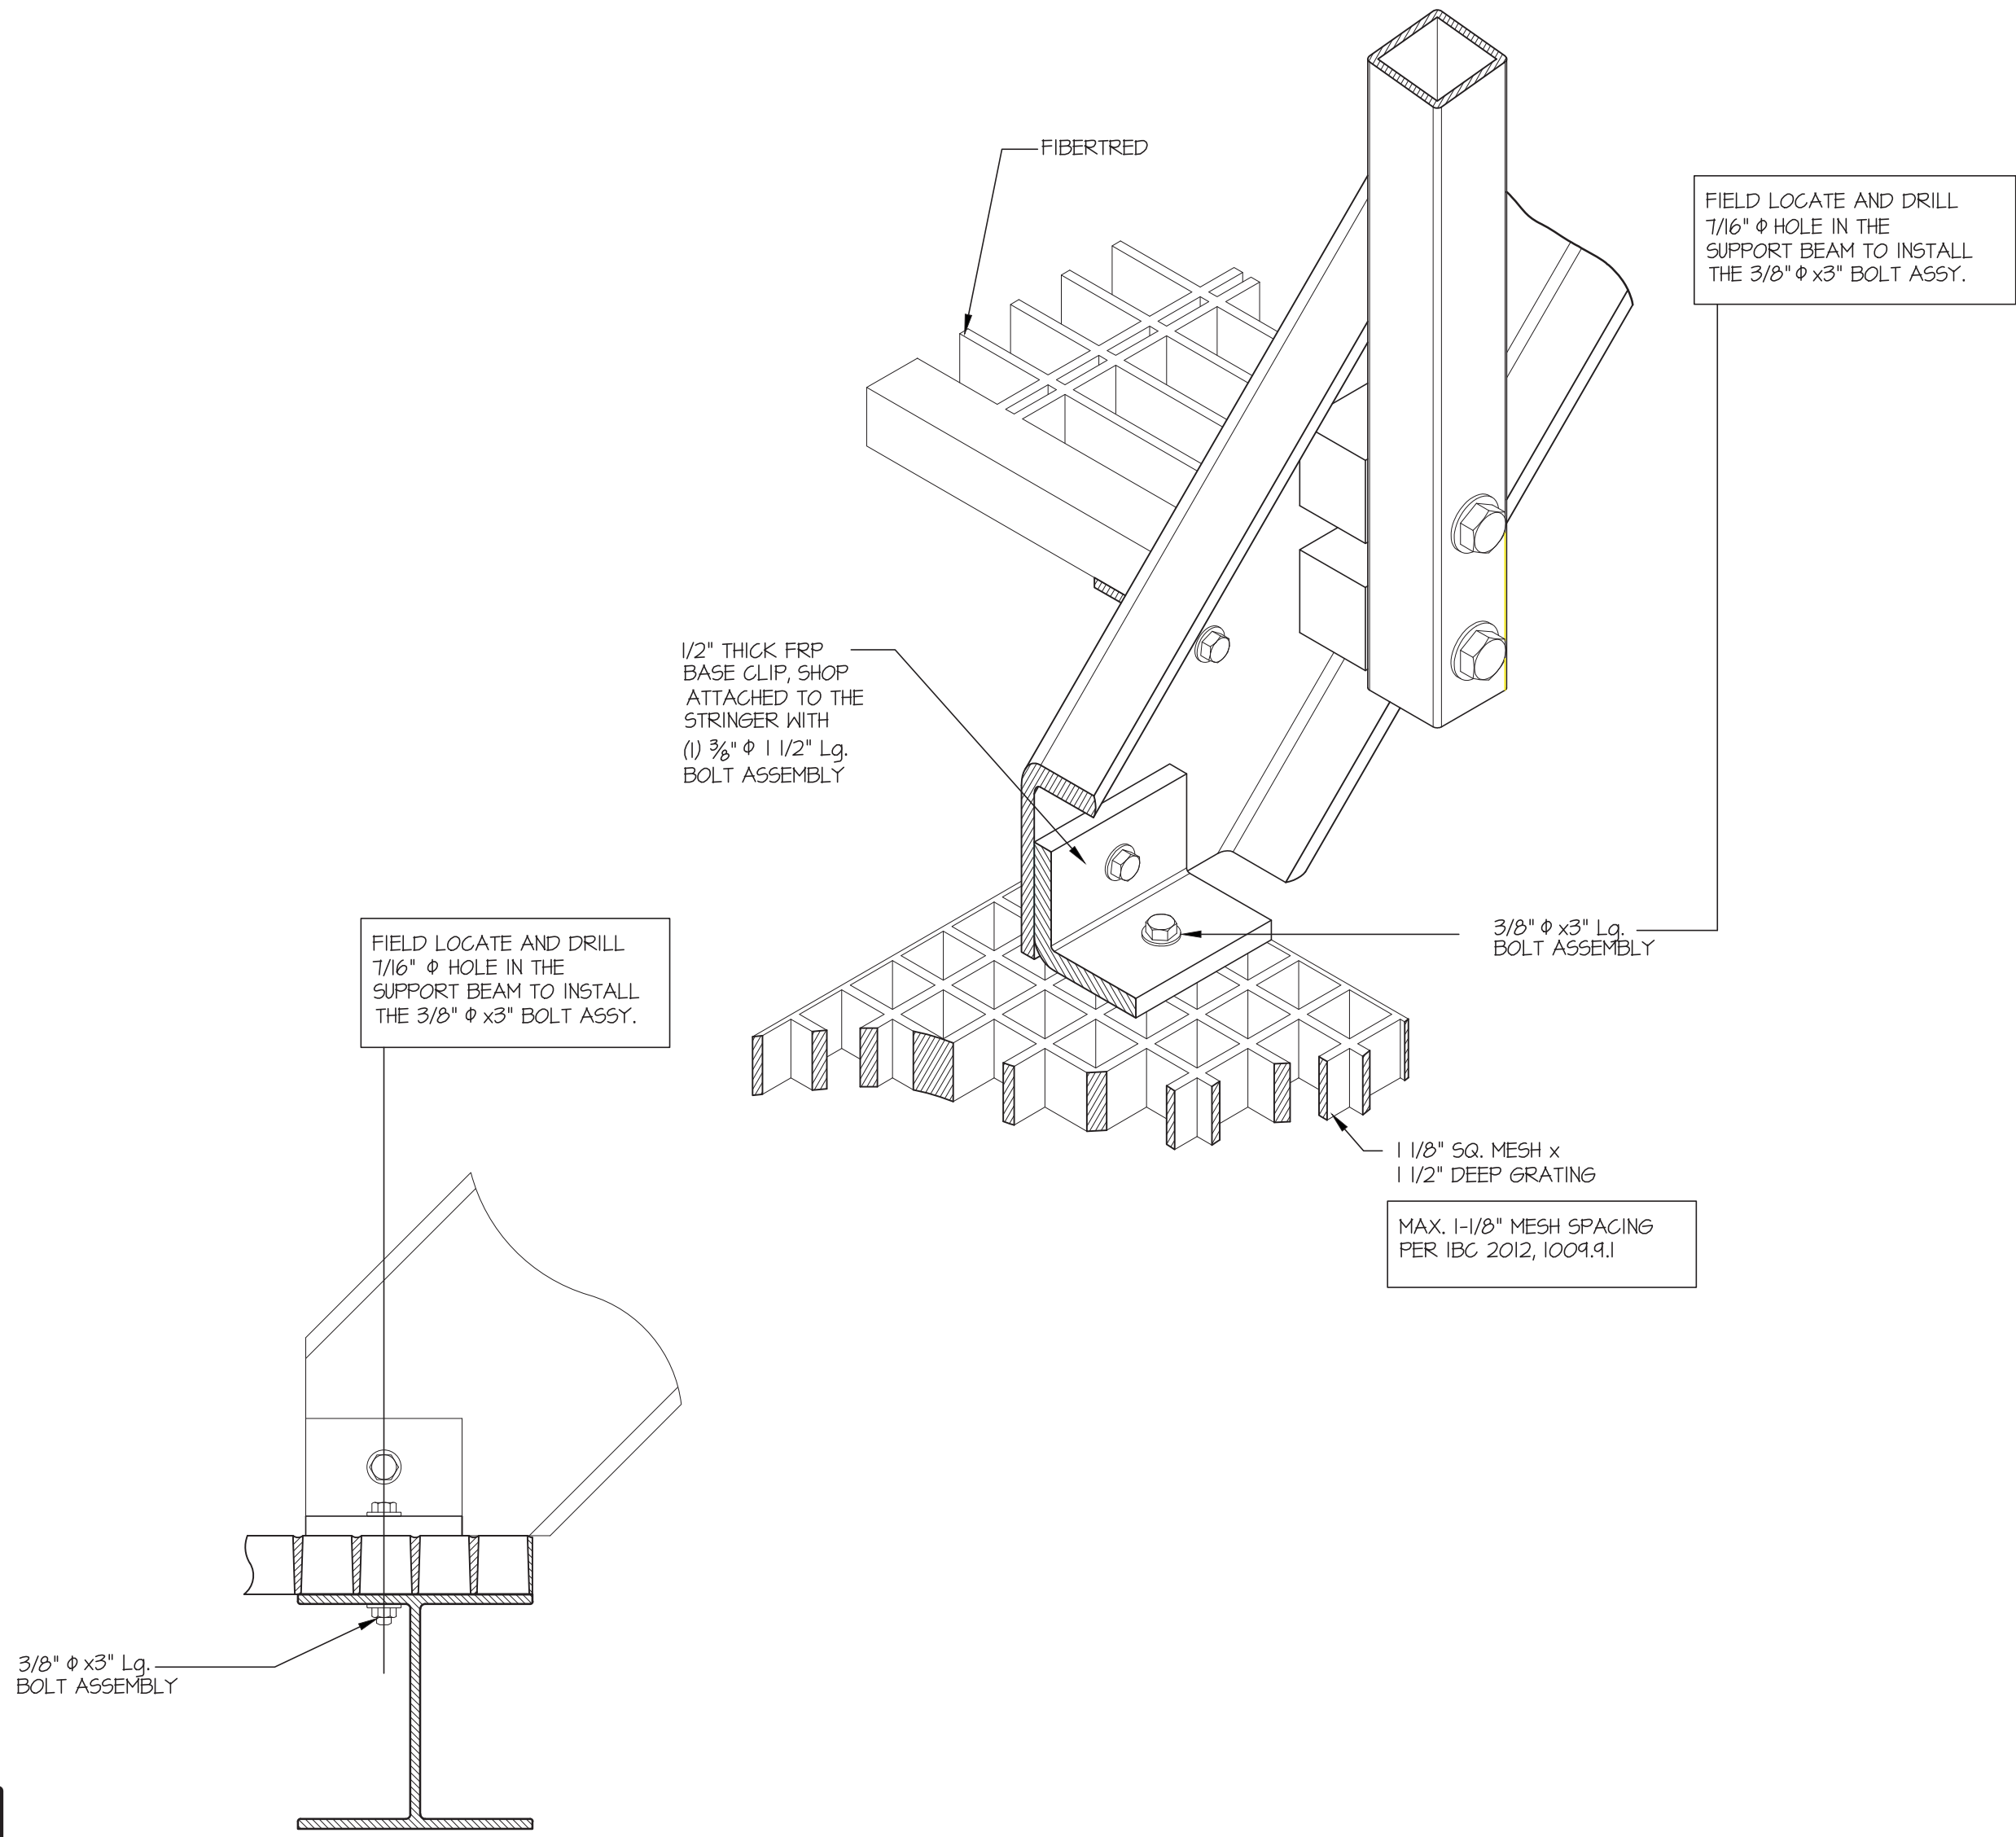


4 STAIR • TOP OF STAIR ATTACHMENT DETAIL
SCALE : N.T.S.

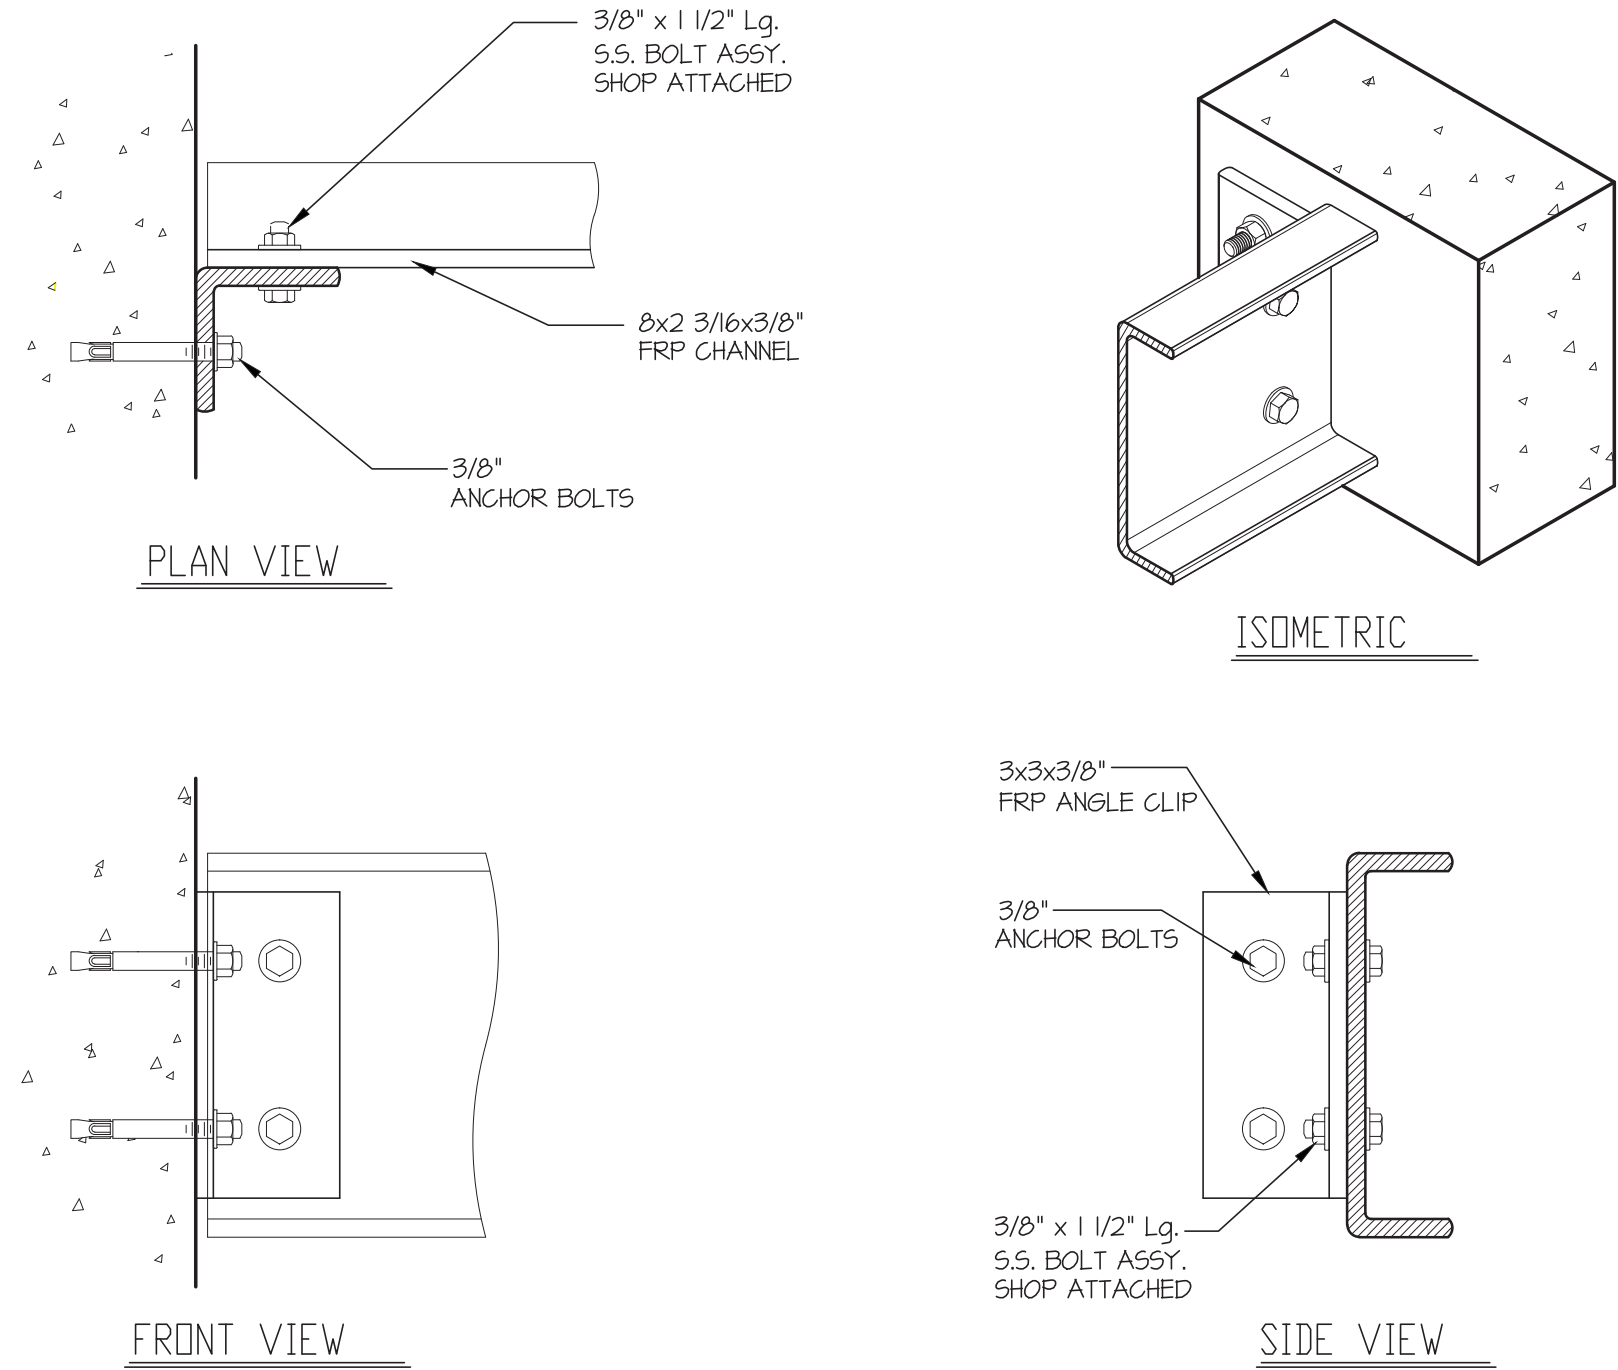

2 STAIR • POST BASE DETAIL
SCALE : N.T.S.

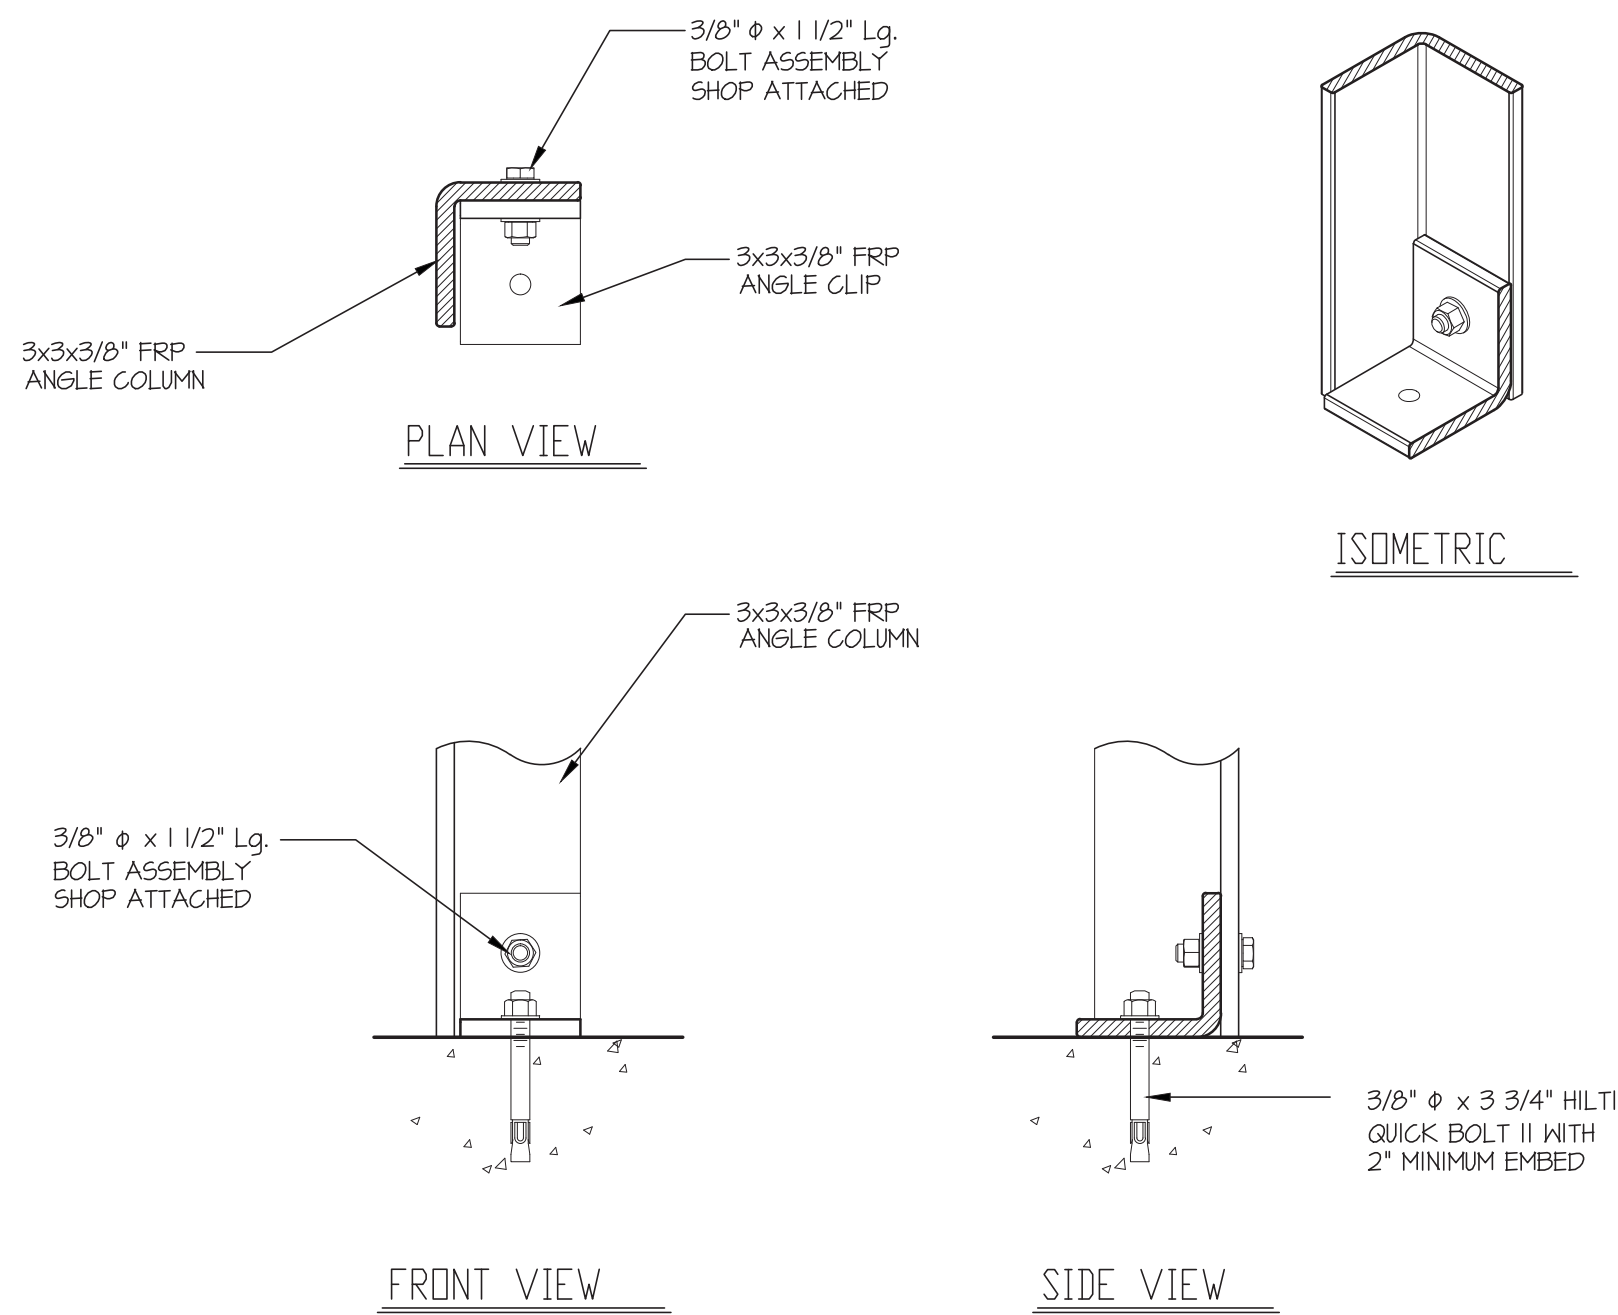

FLOOR PLAN AND SECTION INFORMATION DERIVED FROM: CITY OF NEWARK, WATER TREATMENT FACILITIES PLANT, CONTRACT W-90-1* PREPARED BY TATMAN & LEE ASSOCIATES, INC. DATED 10/1/1990

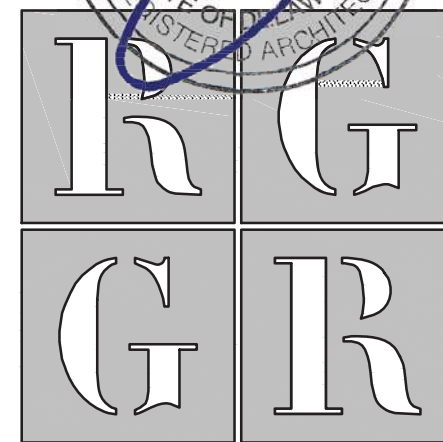

RG Architects, LLC
200 West Main St., Middletown, DE 19709
302.376.8100 302.376.9851 fax
www.rgarchitects.net

0 1' 2' 4' 8'

CURTIS WATER TREATMENT PLANT
IMPROVEMENTS
215 PAPER MILL ROAD
NEWARK, DELAWARE
STAIR CONNECTION DETAILS
CITY OF NEWARK DEPT. OF PUBLIC WORKS AND WATER RESOURCES
220 SOUTH MAIN STREET
NEWARK, DELAWARE 19711

NO.	DATE	REVISIONS	BY

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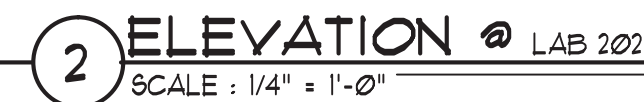
PROJECT CNEW1612
DATE APRIL 2017
DRAWING SCALE AS SHOWN
DRAWN BY RG ARCHITECTS
APPROVED BY RG ARCHITECTS

A5102
SHEET 19 OF 54


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Christiana Executive Campus
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Newark, DE 19713-4310
T 302.655.4451 F 302.654.2895




H C FIXTURE MANUEVERING CLEARANCES



GENERAL NOTES:

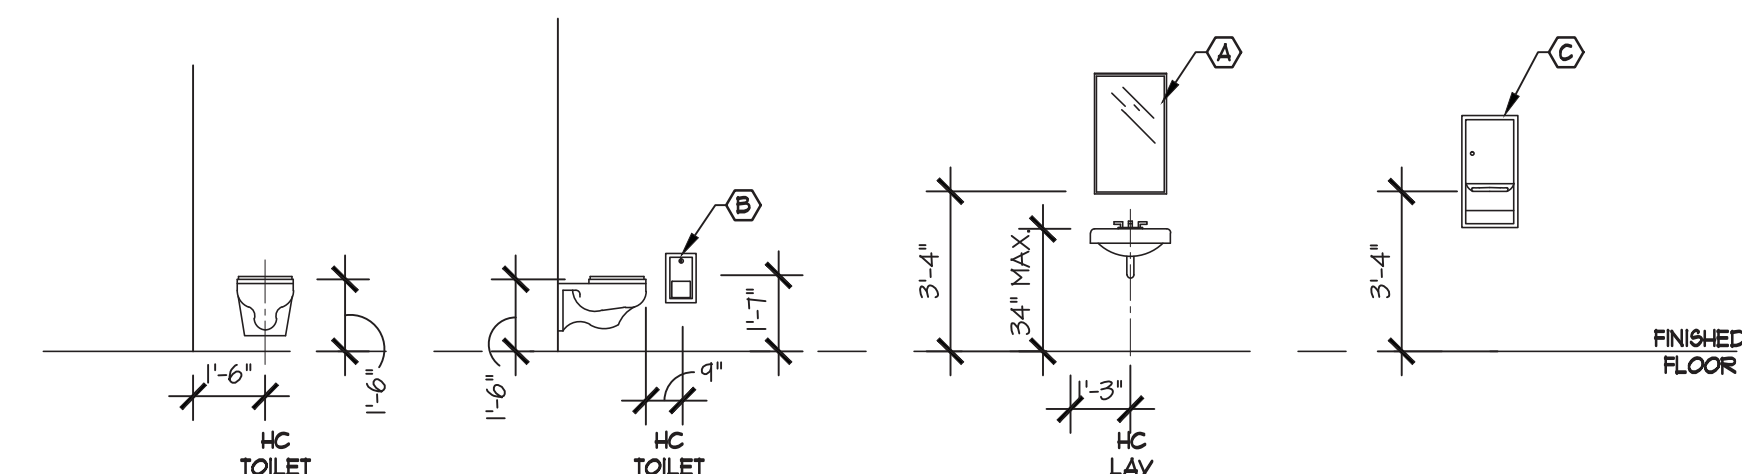1. FIELD VERIFY ALL OVERALL DIMENSIONS PRIOR TO SHOP DRAWING SUBMITTAL.
2. PROVIDE ALL NECESSARY BLOCKING FOR WALL MOUNTED CABINETRY AND SHELVING.
 - FLOOR MOUNTED: 2X6 @ 2" BELOW FINISHED COUNTER.
 - WALL MOUNTED AND HIGH CABINETS: (2) 2X6 LOW AND HIGH.
 - SHELVING: 2X6 AT ALL SHELF STANDARDS
3. PROVIDE LOCKS ON ALL CABINETS AND DRAWERS

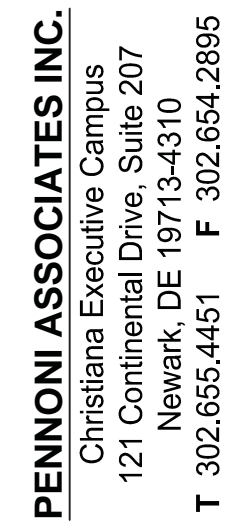

ALL DIMENSIONS MUST BE VERIFIED BY CONTRACTOR
AND OWNER MUST BE NOTIFIED OF ANY
DISCREPANCIES BEFORE PROCEEDING WITH WORK

CURTIS WATER TREATMENT PLANT IMPROVEMENTS 215 PAPER MILL ROAD NEWARK, DELAWARE INTERIOR ELEVATIONS, SECTIONS, & DETAILS

CITY OF NEWARK DEPT. OF PUBLIC WORKS AND WATER RESOURCES
220 SOUTH MAIN STREET
NEWARK, DELAWARE 19711


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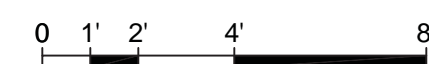
PROJECT	CNEW1612
DATE	APRIL 2017
DRAWING SCALE	AS SHOWN
DRAWN BY	RG ARCHITECTS
APPROVED BY	RG ARCHITECTS

A6001

SHEET 20 OF 54



ARCHITECTS
R G Architects, LLC
200 West Main St., Middletown, DE 19709
302.376.8100 302.376.9851 fax
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FLOOR PLAN AND SECTION INFORMATION DERIVED FROM "CITY OF NEWARK, WATER TREATMENT FACILITIES PLANT, CONTRACT W-90-1" PREPARED BY TATMAN & LEE ASSOCIATES, INC. DATED 10/1/1990

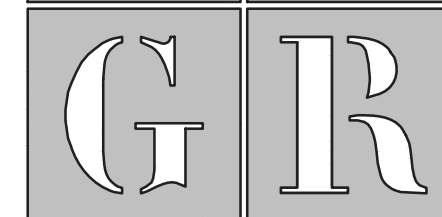

PROJECT STATUS: CONSTRUCTION PLANS

PLOTTED: 4/12/2017 3:28 PM, BY: Brian Miller
 PLOTSTYLE: RGA.ctb

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\\projects\cview\cview\1612\Curfile WTP Improvements\DESIGN_PUBLISH\HS0001.dwg PLOTTED: 1/18/2017 11:16 AM, BY: David S. Bobik PLOTSTYLE: PA1Structural.ctb PROJECT STATUS: DRAFT

21. All contact with

22. Framing members shall be equally spaced and parallel or at right angles to one another with their webs in a vertical plane, unless noted otherwise.
23. Provide holes, as required, for attaching other materials to structural steel; refer to architectural drawings.
24. All columns shall be furnished with cap plates and base plates of sizes called for and shall be shop welded.
25. Notify the SER of any fabrication and erection errors or deviations and receive written approval before any field corrections are made.
26. Fabricator shall take full responsibility for errors and or required corrections to steel fabricated prior to SER's and Architect's approval of shop drawings.

1. All stud and/or joist framing members shall be of the type, size and gage as shown on the plans and shall be manufactured by Dietrich Industries or approved equal.
2. Light gage framing labeled as structural members on structural drawings are load carrying members. Members supplied shall meet or exceed the capacities of the members shown.
3. All framing members and accessories shall be formed from steel having a galvanized coating meeting the requirements of ASTM A653.
4. All galvanized joists, studs, headers and accessories shall be formed from steel that corresponds to the requirements of the latest AISI standards with amendments.
5. All studs, joists, tracks, bridging and accessories shall have the following material strengths:

a. 16 gage and heavier.....	Fy = 50 KSI
b. 18 gage and lighter.....	Fy = 33 KSI
6. Unless noted otherwise, all connections are to be fastened with a minimum of (3) #12-14 screws or equivalent welds as noted.

1. Structural steel material, design, detailing, fabrication and erection shall be in accordance with the following references:
 - "Specification for Structural Steel Buildings", AISC's 13th Edition
 - "Structural Welding Code, AISC D11", AISC
 - "Engineering for Steel Construction", AISC
 - "Detailing for Steel Construction", AISC
2. The steel contractor shall furnish an affidavit from the producer of the steel certifying that the steel meets the minimum requirements as defined by the applicable ASTM Specification.
3. The structural steel contractor shall verify the foundation construction for anchor rod location, elevation of top of concrete and/or leveling plates and bearing plates, alignment, etc., prior to start of erection.
4. The steel contractor is responsible for confirming and correlating all quantities and dimensions, selecting fabrication processes and techniques of construction, sequence of connections, coordinating the work with that of all other trades and performing his work in a safe and satisfactory manner.
5. Coordinate with architectural drawings.

6. Unless noted otherwise, Angles, channels, plate and I-beams shall conform to ASTM A36.
7. Structural steel pipe shall conform to ASTM A53, Type E or S, or ASTM A501.
8. Anchor rods shall conform to ASTM F1554, Grade 36, unless noted otherwise.
9. Bolts shall be designed as bearing type bolts, except as noted herein or on plan. Bearing bolts shall be installed in accordance with the " snug tight " condition as outlined in the AISC "Specifications for Structural Joints Using ASTM A325 or A440 Bolts", latest revision. Connection bolts shall have a hardened washer placed under the turned element.
10. The fabricator is responsible for the selection, design and detailing of all connections not fully detailed in the Contract Documents. The fabricator shall submit shop drawings in accordance with the drawings for design intent only. The fabricator shall have a Professional Engineer registered in DE prepare and/or review the connection designs prior to submitting the shop drawings for review and approval. Connections shall be designed and detailed in accordance with AISC's "Steel Construction Manual".

structural drawings, the connections selected than have a minimum capacity equal to 50% of the total uniform load. In the case of composite design, the connections selected shall have a minimum value equal to 75% of the total uniform load as shown in AISI's tables of Uniform Load Connections. The effect of concentrated loads shall be considered. No steel connection shall consist of less than two (2) high-strength bolts or equivalent welds.

12. Steel connections shall be bolted with 3/4" (min.) diameter A325-TC high-strength bolts or welded, unless noted or approved otherwise. Bolts shall be spaced 3" o.c. (min.), unless approved otherwise by the SER.

to pipe and tube columns. Provide through plates if required per AISC's guidelines.

15. All welding shall be done by AWS certified welders in accordance with AWS D1.1 (latest edition). Minimum fillet weld

10. Steel welding rods shall be E 70XX (low hydrogen & 50 ksi material).

18. Splicing of structural steel members where not detailed on the Contract Documents is prohibited without prior written

19. Steel shall have a shop coat of a VOC compliant rust-inhibitive primer, except where steel is to receive

cleaning (SSPC-SP3) prior to painting, unless noted otherwise.

steel shall be thoroughly cleaned by power tool cleaning prior to galvanizing. The steel erector shall touch up any points of welding or damage to the galvanized finish in accordance with ASTM A780. Galvanizing of connectors shall conform to ASTM A153.


1. Foundations have been designed for an allowable bearing capacity and footing elevations established in accordance with available information from adjacent sites, similar soil conditions in the project vicinity, and/or soil guidelines from IBC. A new Subsurface Investigation Report, with foundation recommendations, has not been provided by the Owner for this project at the time of design. Engage a licensed qualified Geotechnical Engineer to verify the soil information and bearing capacity during construction.
2. Footings shall bear on undisturbed natural soils and/or engineered fill with a minimum bearing capacity of 2,000 psf.
3. Investigate existing foundation locations and elevations along adjacent structures, via test pits or other methods, prior to the commencement of work.
4. Maintain a maximum 1:1 slope from the bottom edge of any excavation to adjacent excavations or bottom of foundations.
5. Compact soil to not less than the following percentages of maximum dry density of modified proctor (ASTM D1557) unless noted otherwise:
 - Under building foundations - 95%
 - Under building slabs, steps, pavements - 93%

1. Concrete work shall comply with the requirements of the latest adopted editions of ACI "Building Code Requirements for Structural Concrete and Commentary (ACI 318)", ACI "Specifications for Structural Concrete (ACI 301)", and ACI "Measuring, Mixing, Transporting, and Placing Concrete (ACI 304)".

- mixing drums, buggies, chutes, conveyors or other equipment made of aluminum.
22. Repair concrete exhibiting voids due to snap ties, honeycombs, rock pockets, and runs, spalls or otherwise damaged surfaces, with dry pack or cement grout. Finish flush with adjoining surfaces. At the discretion of the SER, or as, qualified by lab testing, excessive honeycombs or exposed reinforcement that jeopardize the design, shall be removed and replaced at the expense of the contractor.
23. Bonding agent or cement slurry coat shall be used where new concrete is placed against existing concrete, unless noted otherwise.
24. All concrete shall be formed, unless otherwise approved by the SER. All pours shall be terminated by forms. Provide keys between adjacent pours.
25. All concrete, including foundation work, shall be vibrated. Proper use of vibrators is required. Vibrators shall not be used to transport concrete.
26. Chamfer all exposed concrete corners/edges unless noted otherwise on Architectural Drawings.
27. All embedments, including anchor rods, shall be in place prior to placing concrete.
28. Concrete shall not be pumped through aluminum pipes and shall not be placed in contact with aluminum forms, mixing drums, buggies, chutes, conveyors or other equipment made of aluminum.
29. Repair concrete exhibiting voids due to snap ties, honeycombs, rock pockets, and runs, spalls or otherwise damaged surfaces, with dry pack or cement grout. Finish flush with adjoining surfaces. At the discretion of the SER, or as, qualified by lab testing, excessive honeycombs or exposed reinforcement that jeopardize the design, shall be removed and replaced at the expense of the contractor.

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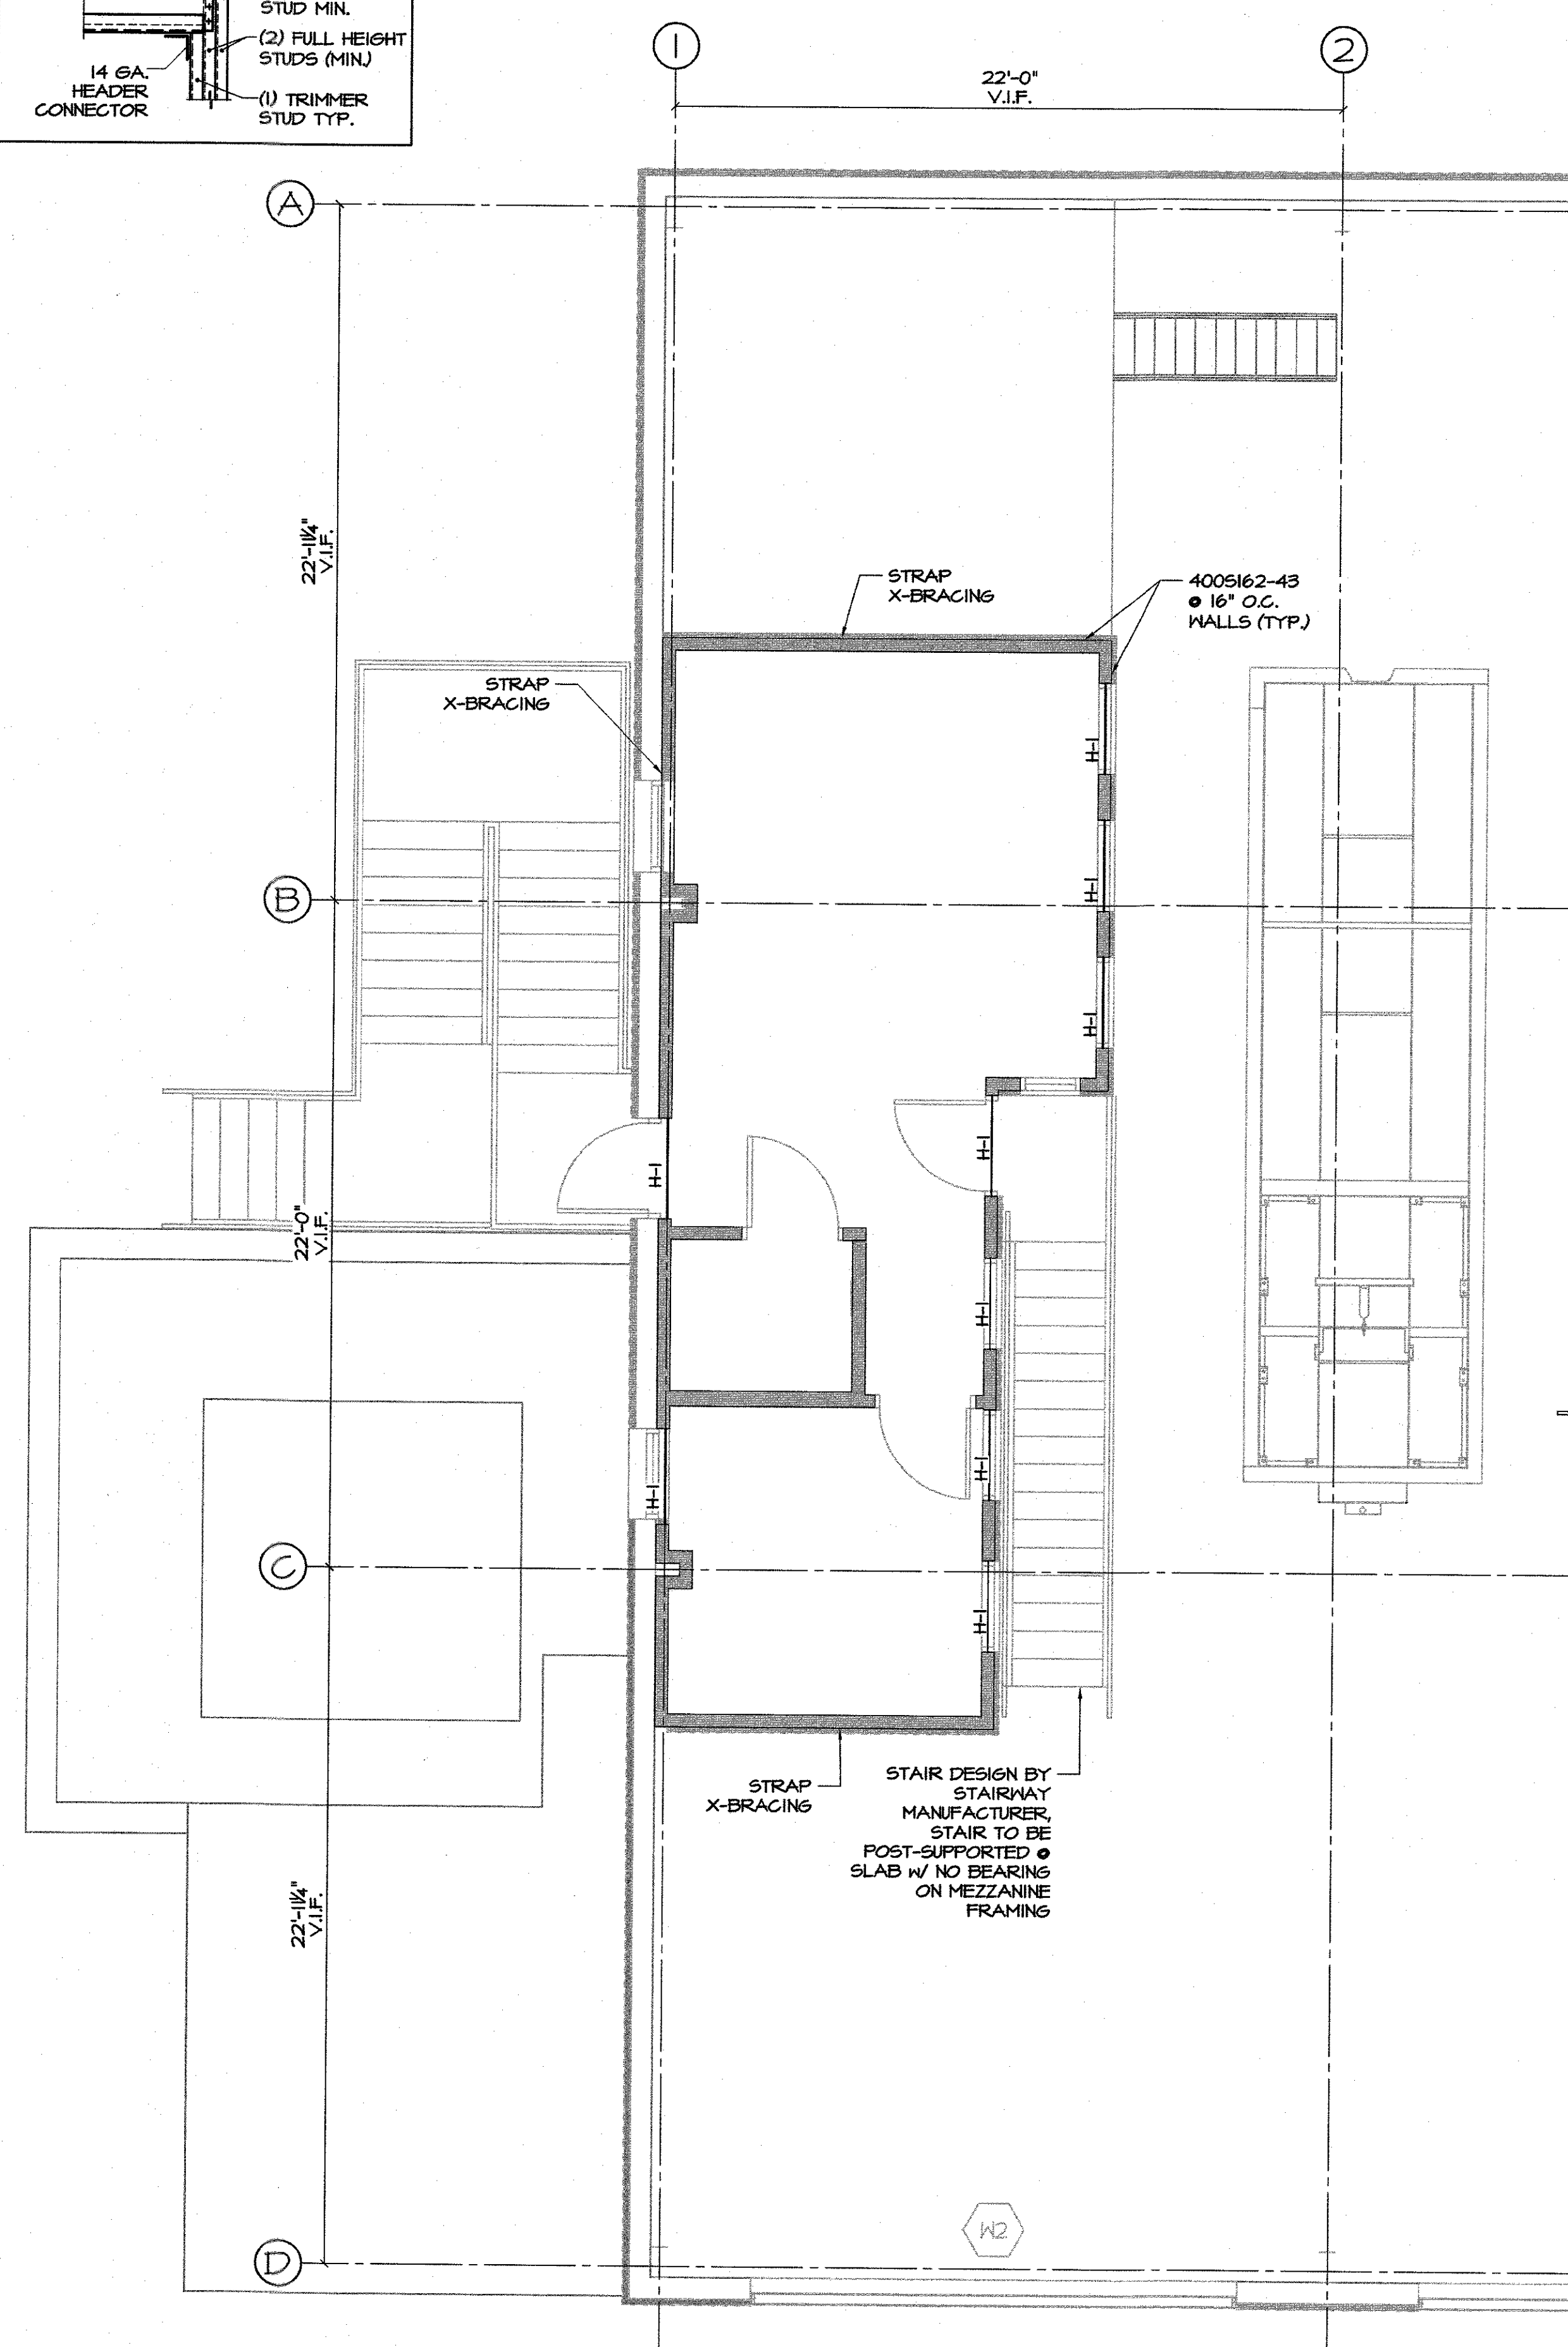
MEZZANINE FRAMING PLAN

SCALE: 1/4" = 1'-0"

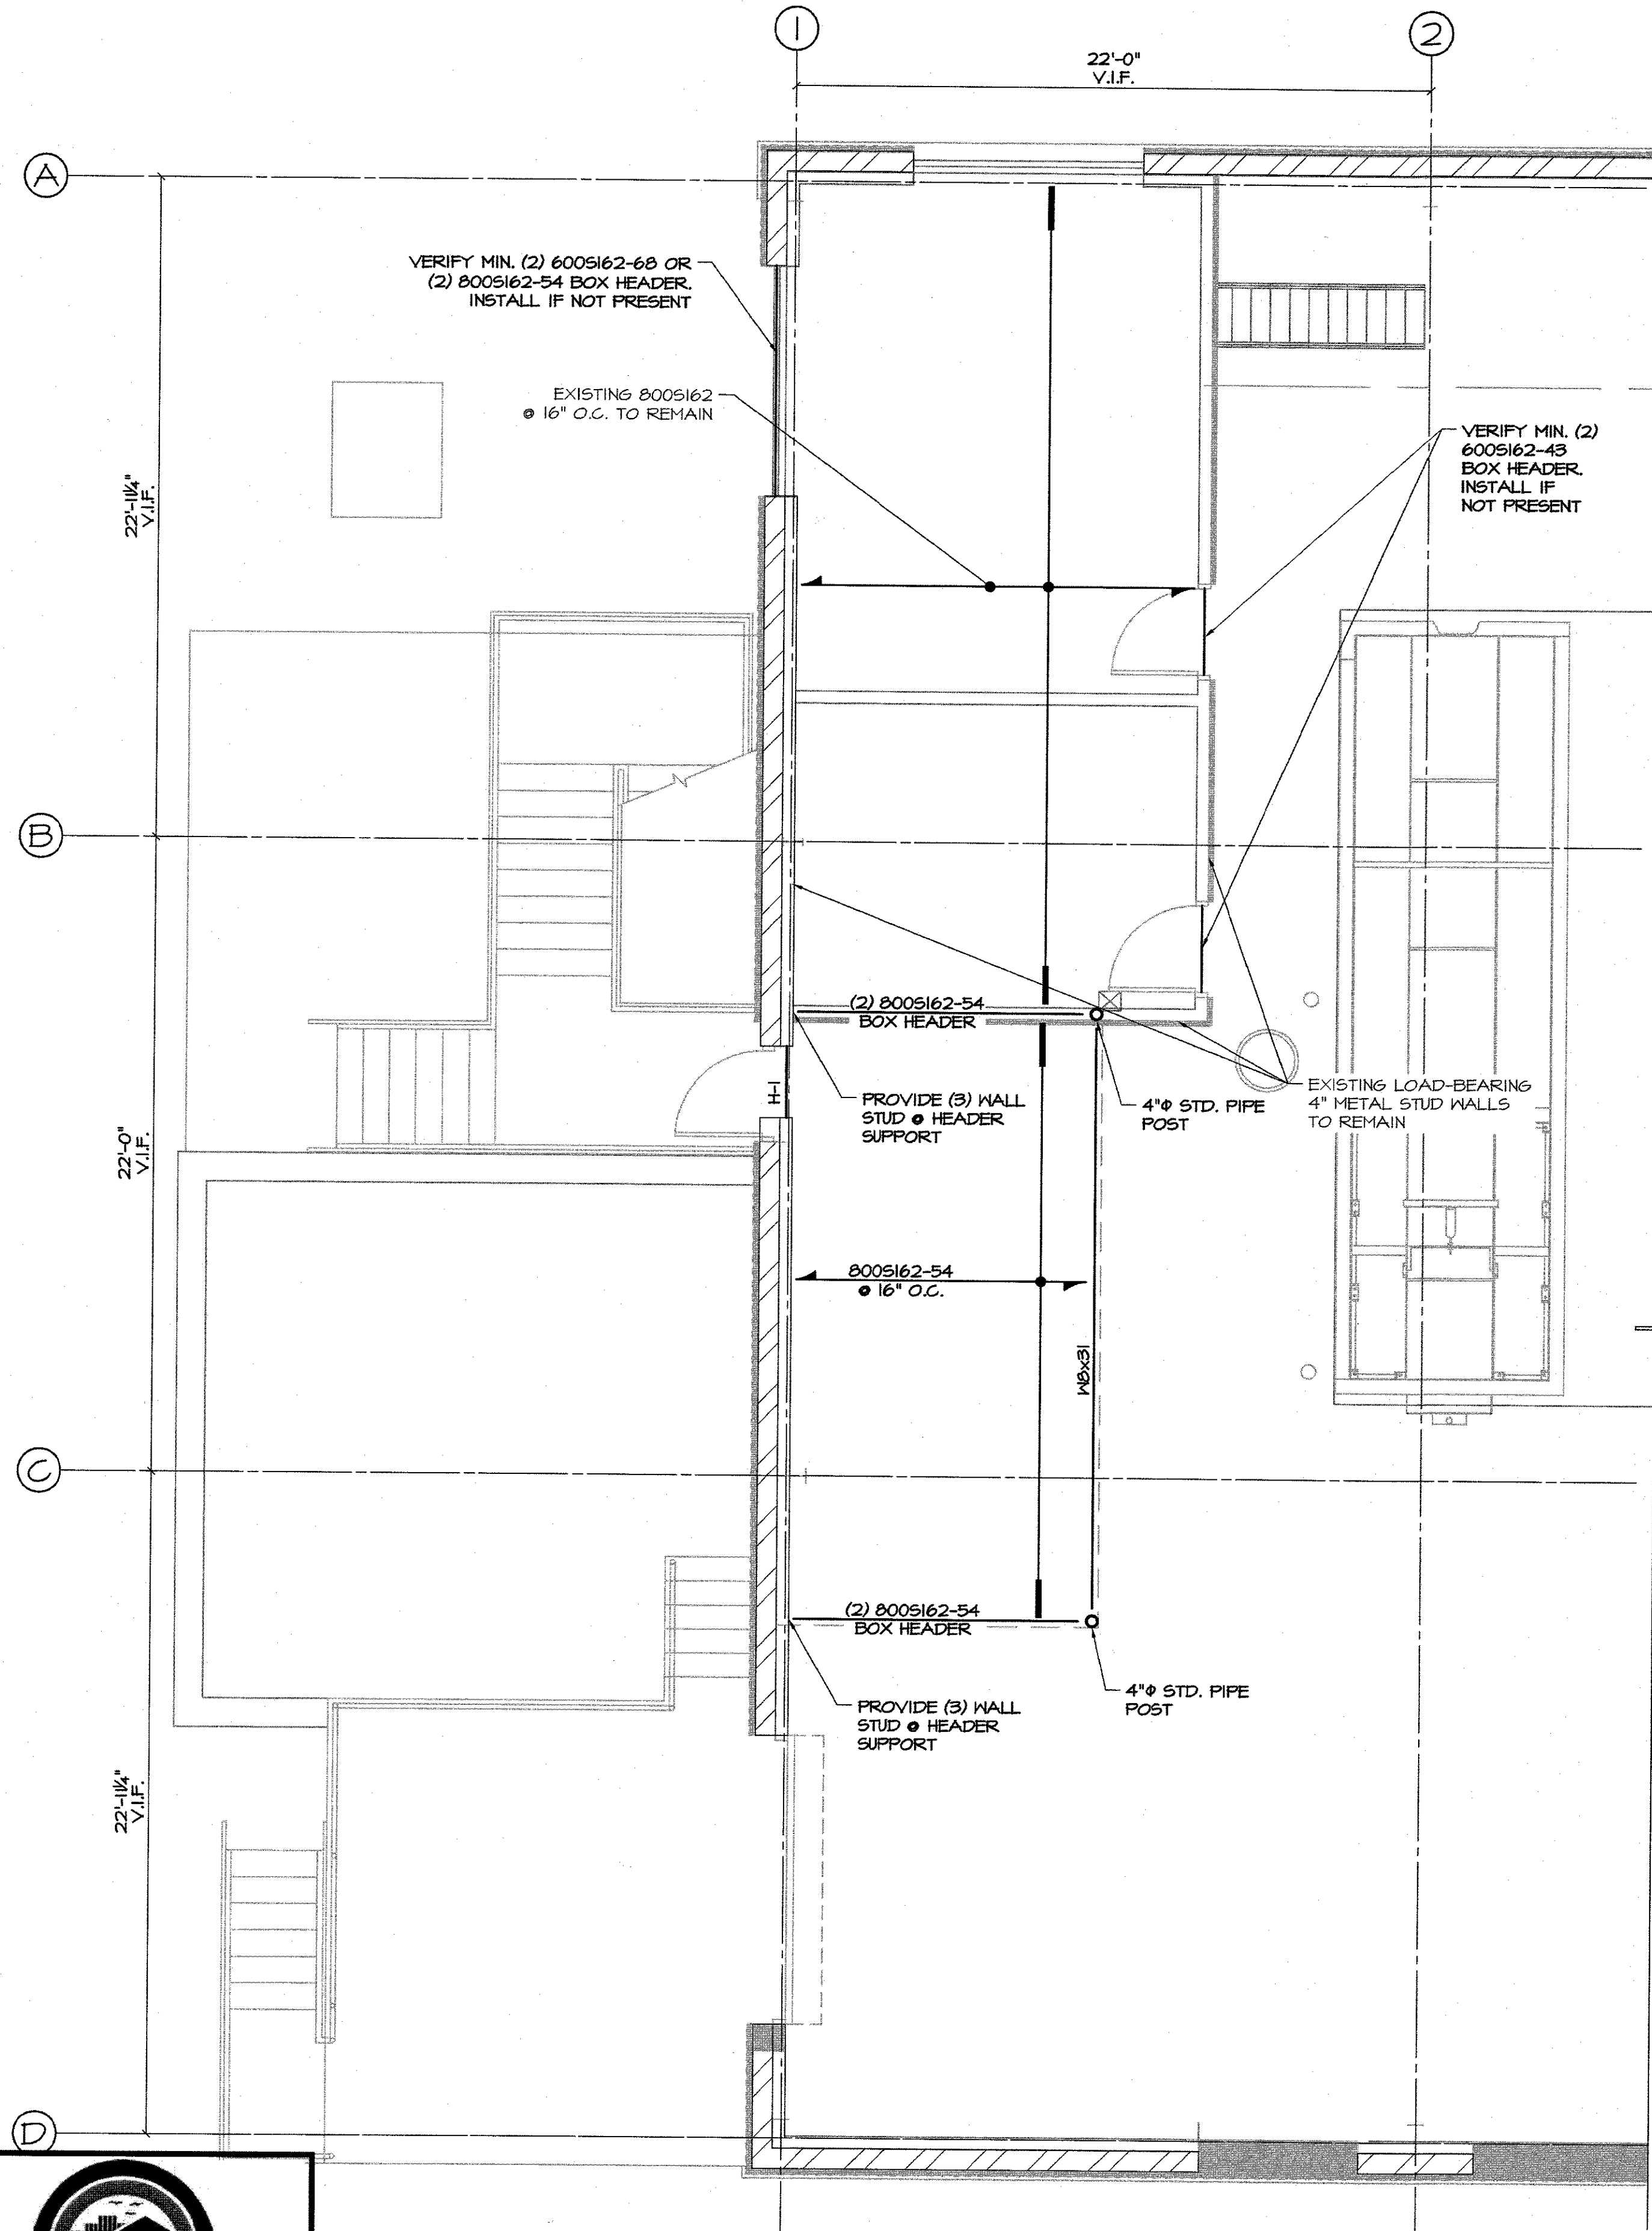NOTE:

1. VERIFY EXISTING METAL FLOOR AND WALL STUD SIZES DURING CONSTRUCTION. MINIMUM SIZE TO BE 400S162-43 @ 16" O.C. FOR WALLS AND 800S162-54 @ 16" O.C. FOR FLOOR. NOTIFY ENGINEER IF ANY DISCREPANCIES ARE NOTED.

HEADER SCHEDULE		
MARK	DESCRIPTION	DETAIL
H-1	BOX HEADER (2) 600S162-43 W/ 400T125-43 TOP AND BOTTOM TRACK. PROVIDE WEB STIFFENERS IN EACH END OF BOX HEADER	<p>(5) 12-14 SCREWS PER SIDE AT HEADER TO STUD MIN. (2) FULL HEIGHT STUDS (MIN) (1) TRIMMER STUD TYP.</p>



MEZZANINE CEILING FRAMING PLAN

SCALE: 1/4" = 1'-0"

NOTE:

1. MEZZANINE CEILING TO BE ACOUSTIC DROP CEILING TILE SUSPENDED FROM EXISTING BUILDING ROOF FRAMING. CONNECT CEILING TO METAL STUD WALLS.


CURTIS WATER TREATMENT PLANT
IMPROVEMENTS

215 PAPER MILL ROAD
NEWARK, DELAWARE

STRUCTURAL MEZZANINE PLAN

CITY OF NEWARK DEPT. OF PUBLIC WORKS AND WATER RESOURCES
220 SOUTH MAIN STREET
NEWARK, DELAWARE 19711

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INDEMNIFY AND HOLD HARMLESS PENNONI ASSOCIATES
FROM ALL CLAIMS, DAMAGES, LOSSES AND EXPENSES
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PROJECT	CNEW1612
DATE	APRIL 2017
DRAWING SCALE	1/4" = 1'-0"
DRAWN BY	RJK
APPROVED BY	GEL





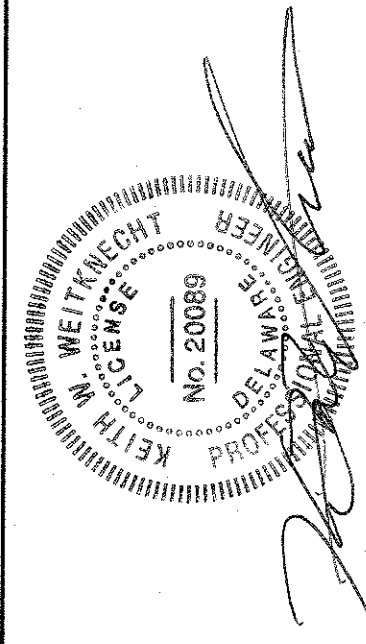
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SHEET 23 OF 39





PENNONI ASSOCIATES INC.
Christiana Executive Campus
121 Continental Drive, Suite 207
Newark, DE 19713-4310
T 302.655.4451 F 302.654.2895

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ANCHOR ROD SCHEDULE								
MARK	MATERIAL	QTY.	DIA.	EMBT	HOOK	PROJ.	THREAD	ANCHOR PLATE
①	F1554-36 KSI	4	3/4"	4"	3"	4"	3 1/2"	N/A

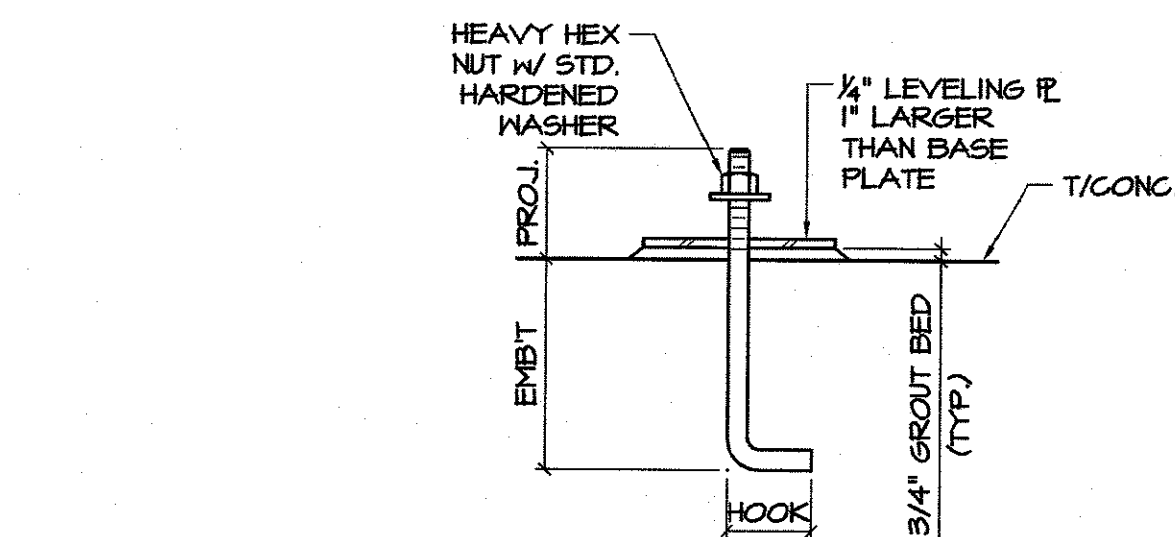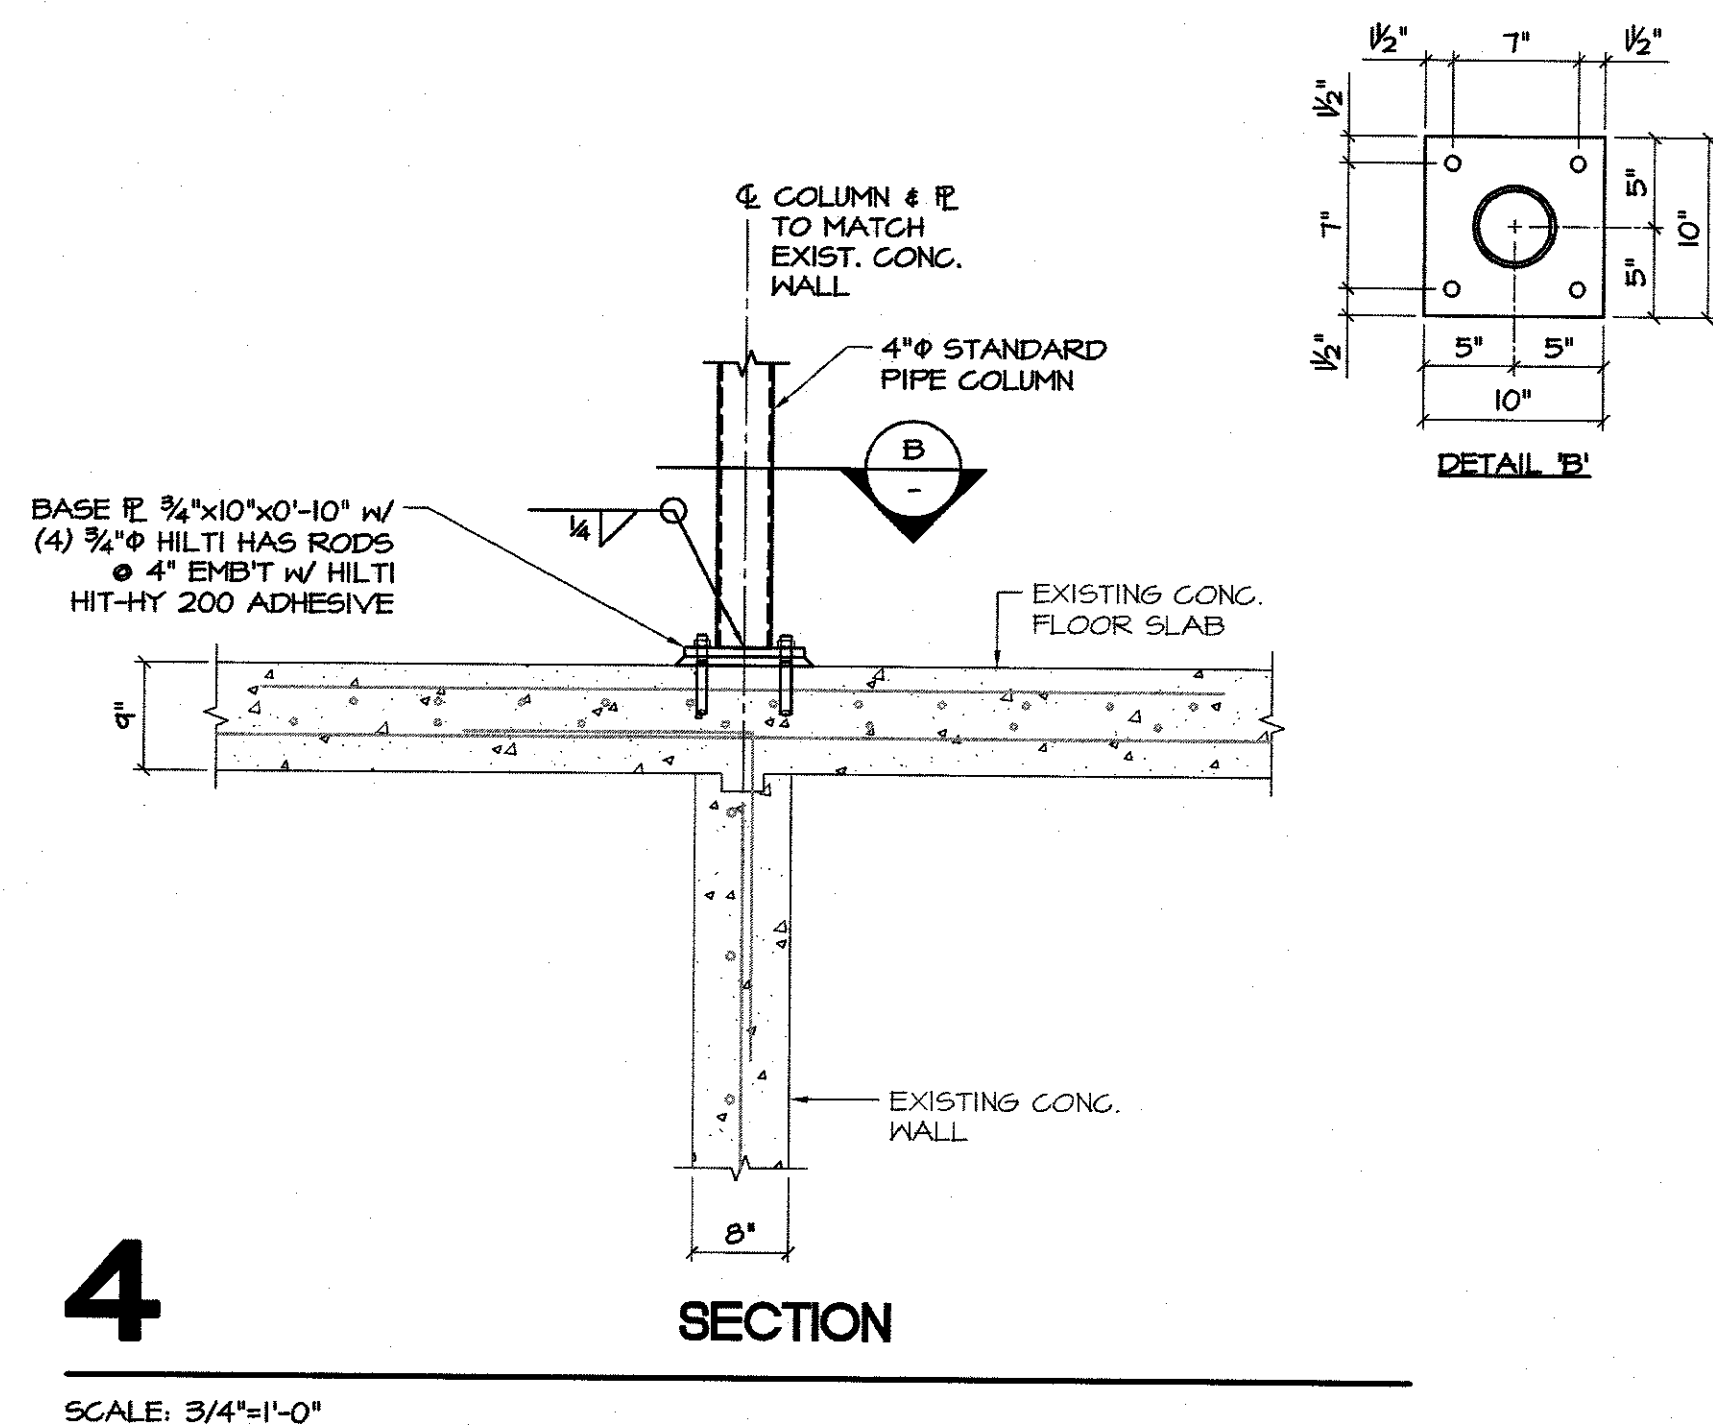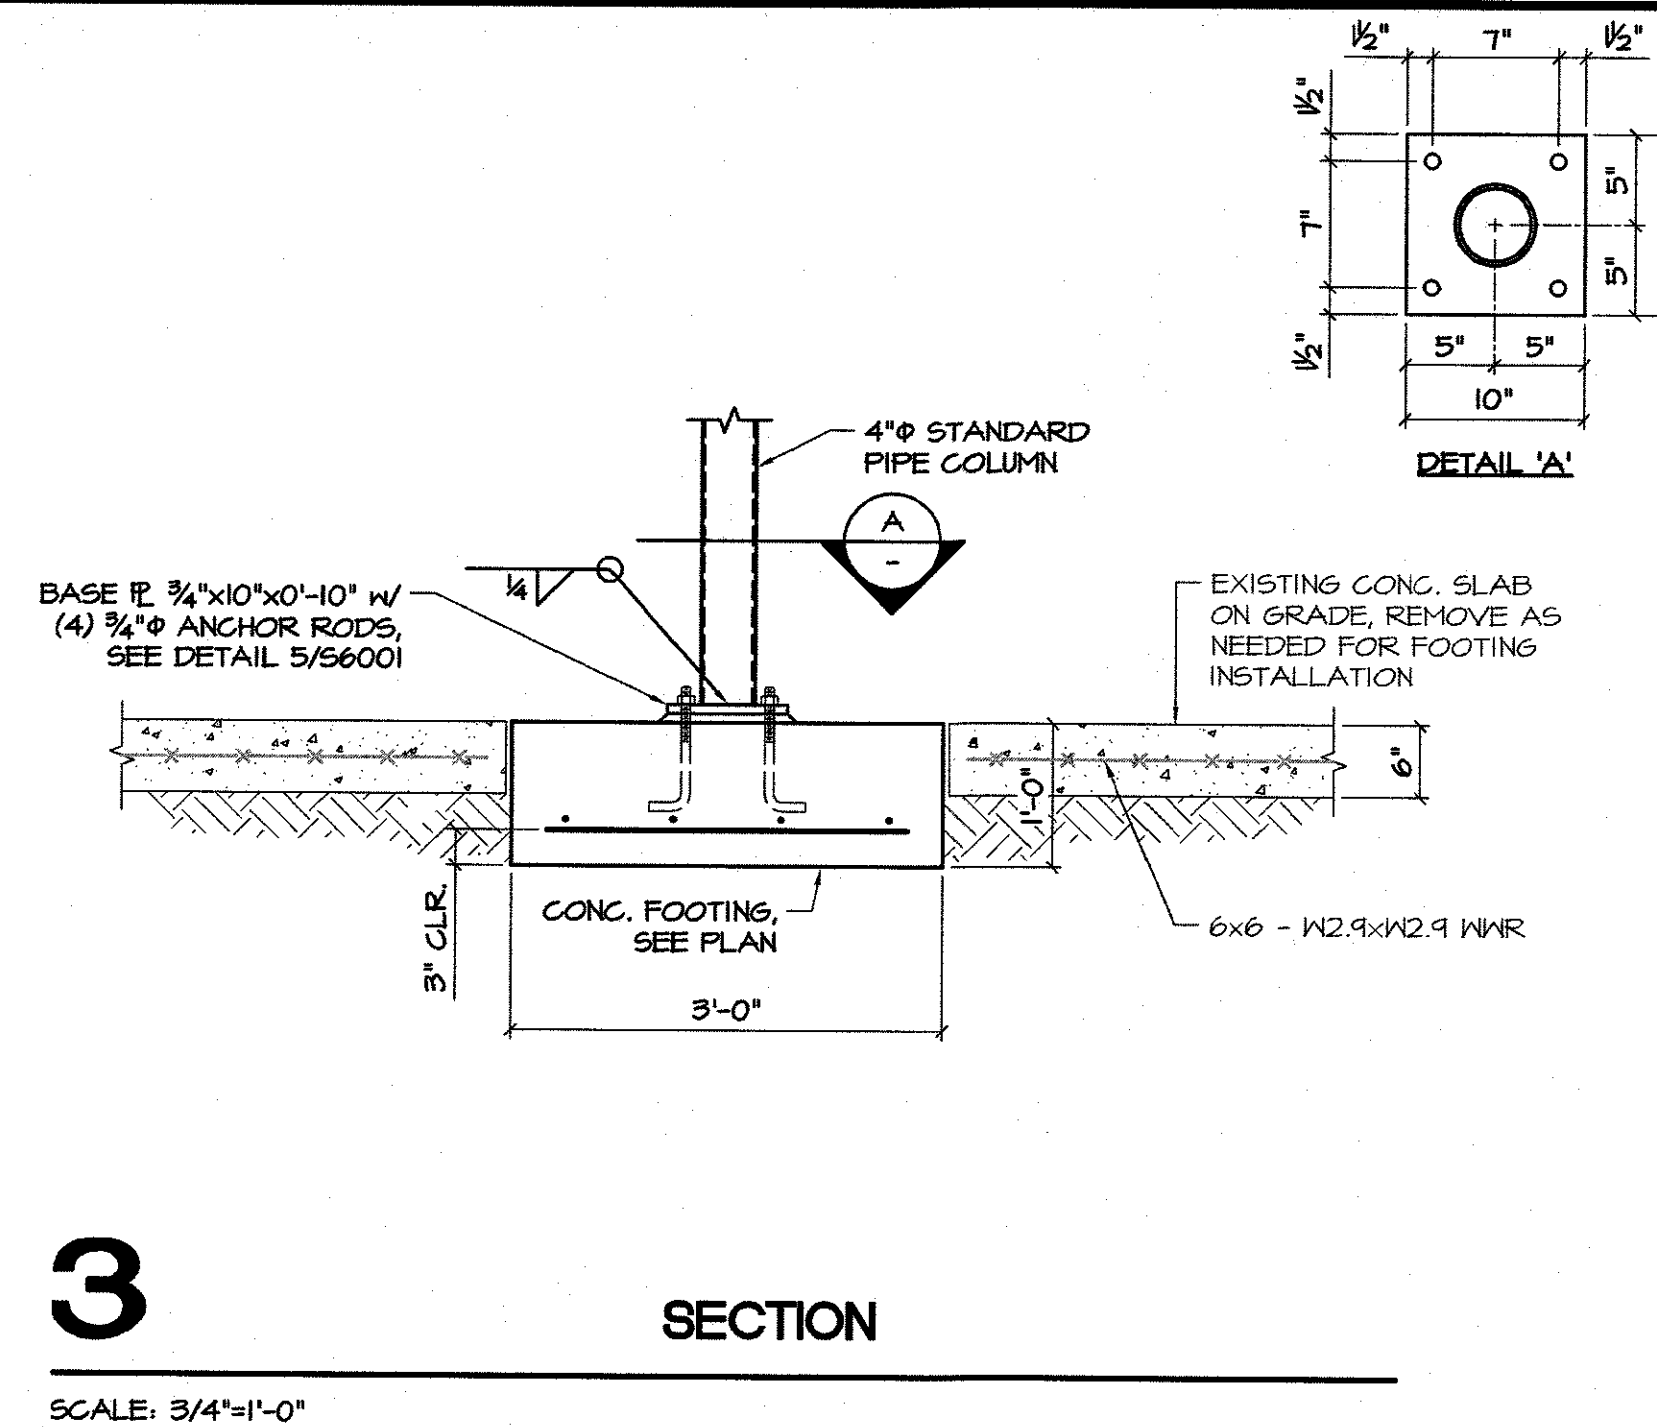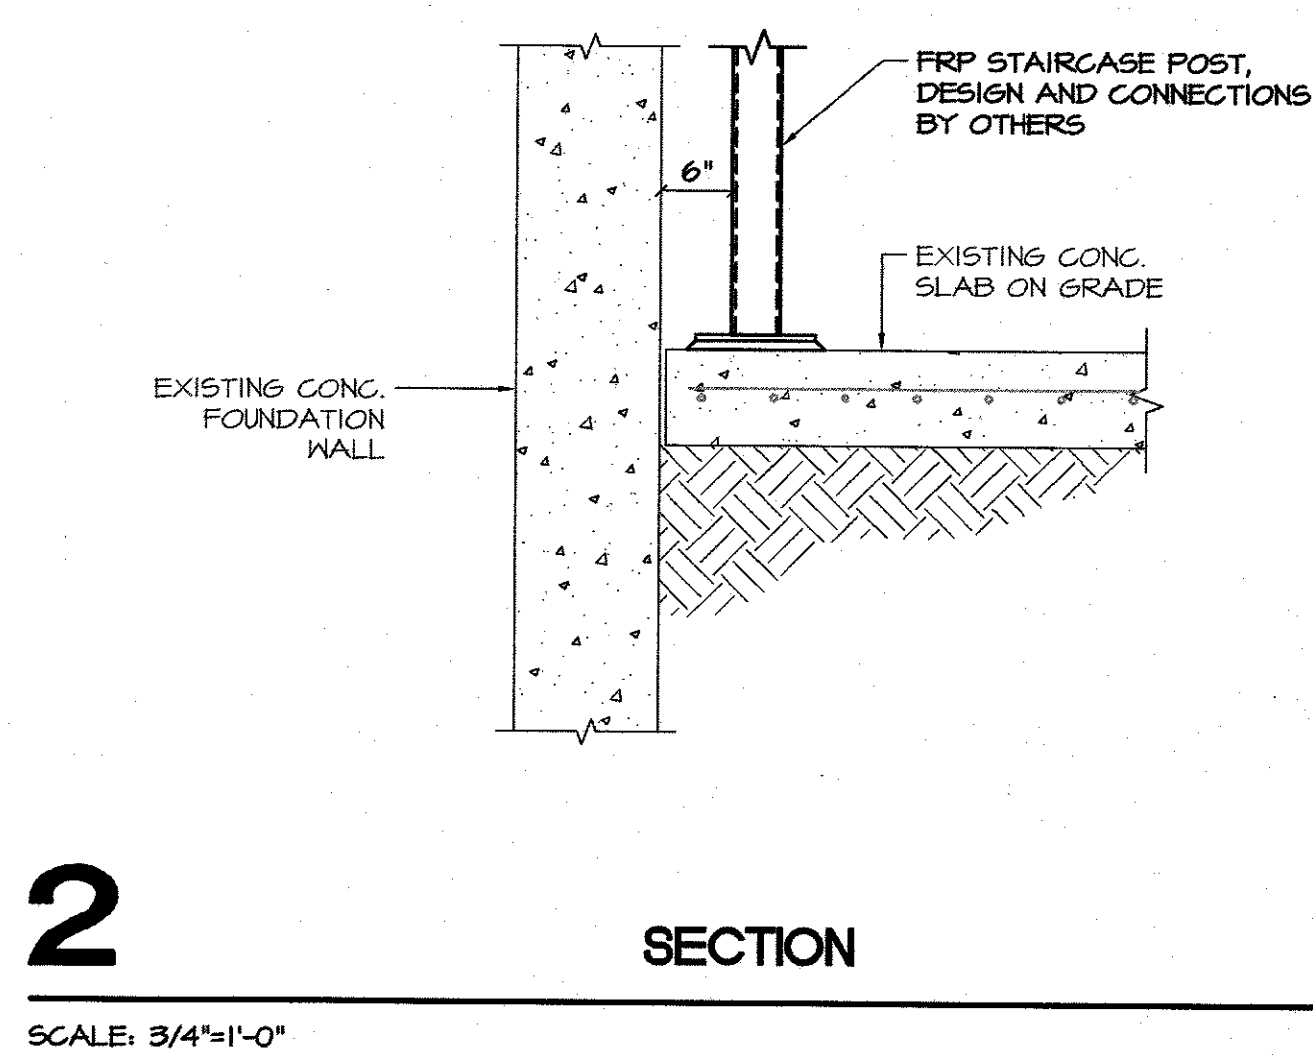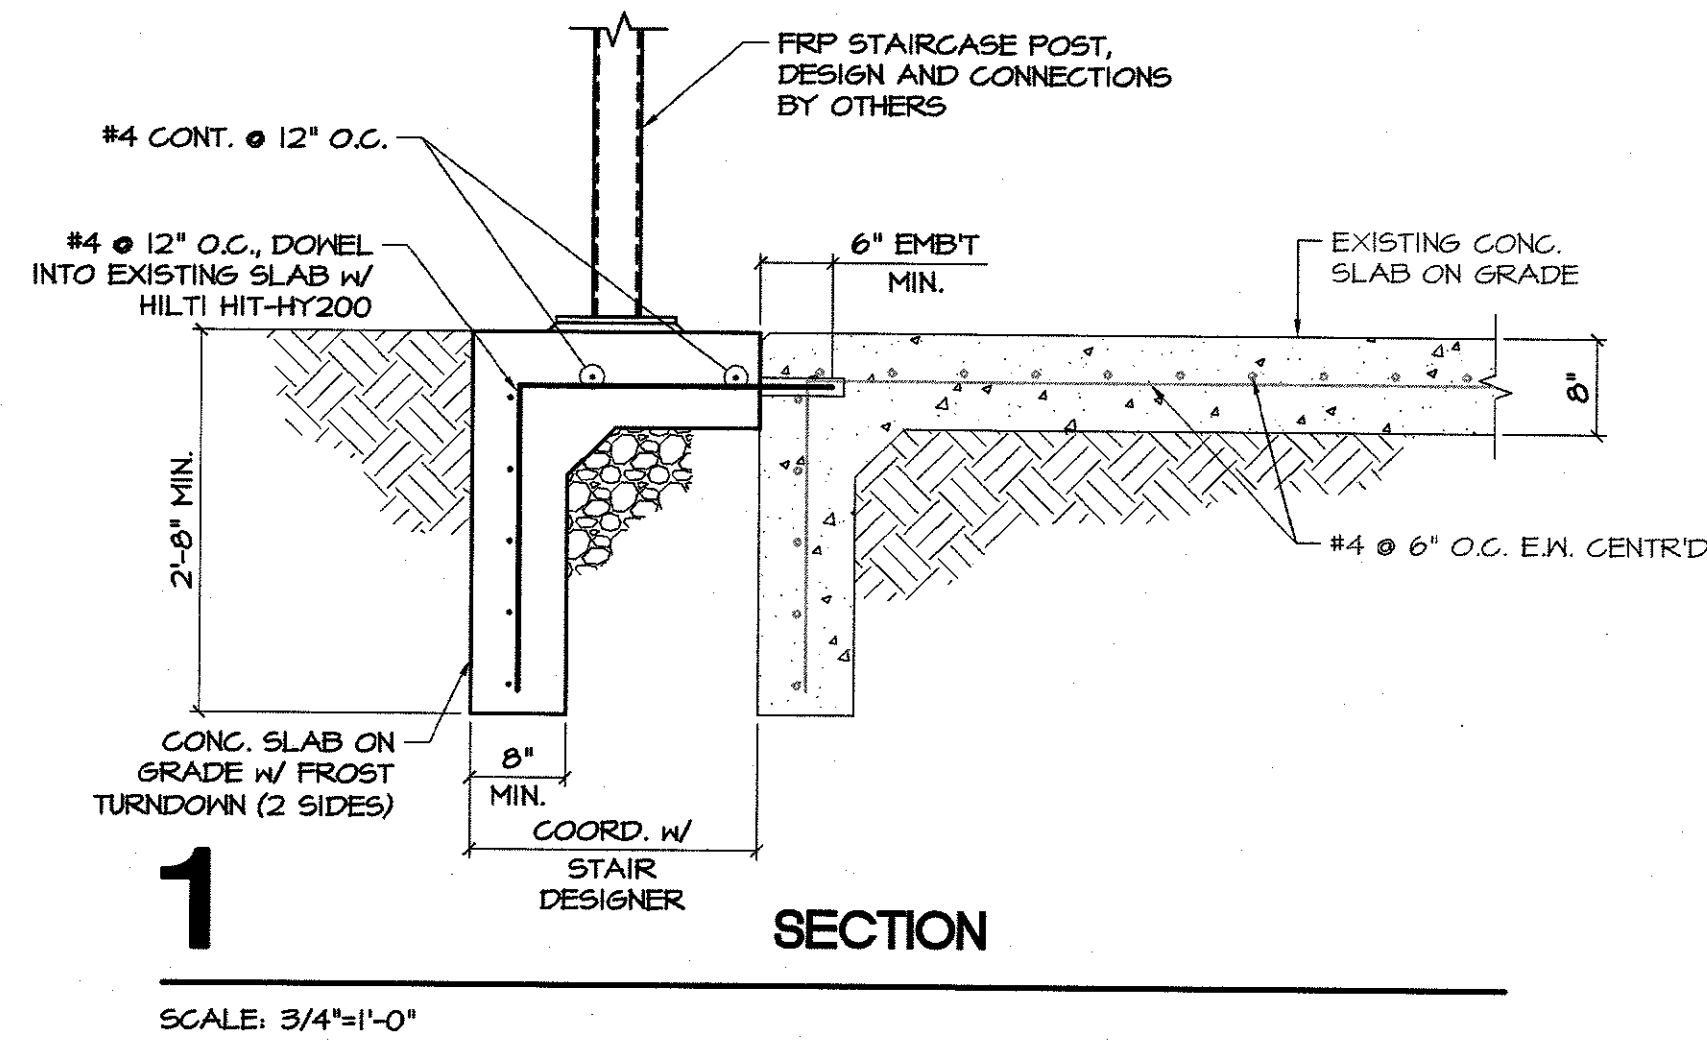

50th
Pennoni
PENNONI ASSOCIATES INC.
Christiana Executive Campus
121 Continental Drive, Suite 207
Newark, DE 19713-4310
T. 302.655.4451 F. 302.654.2895

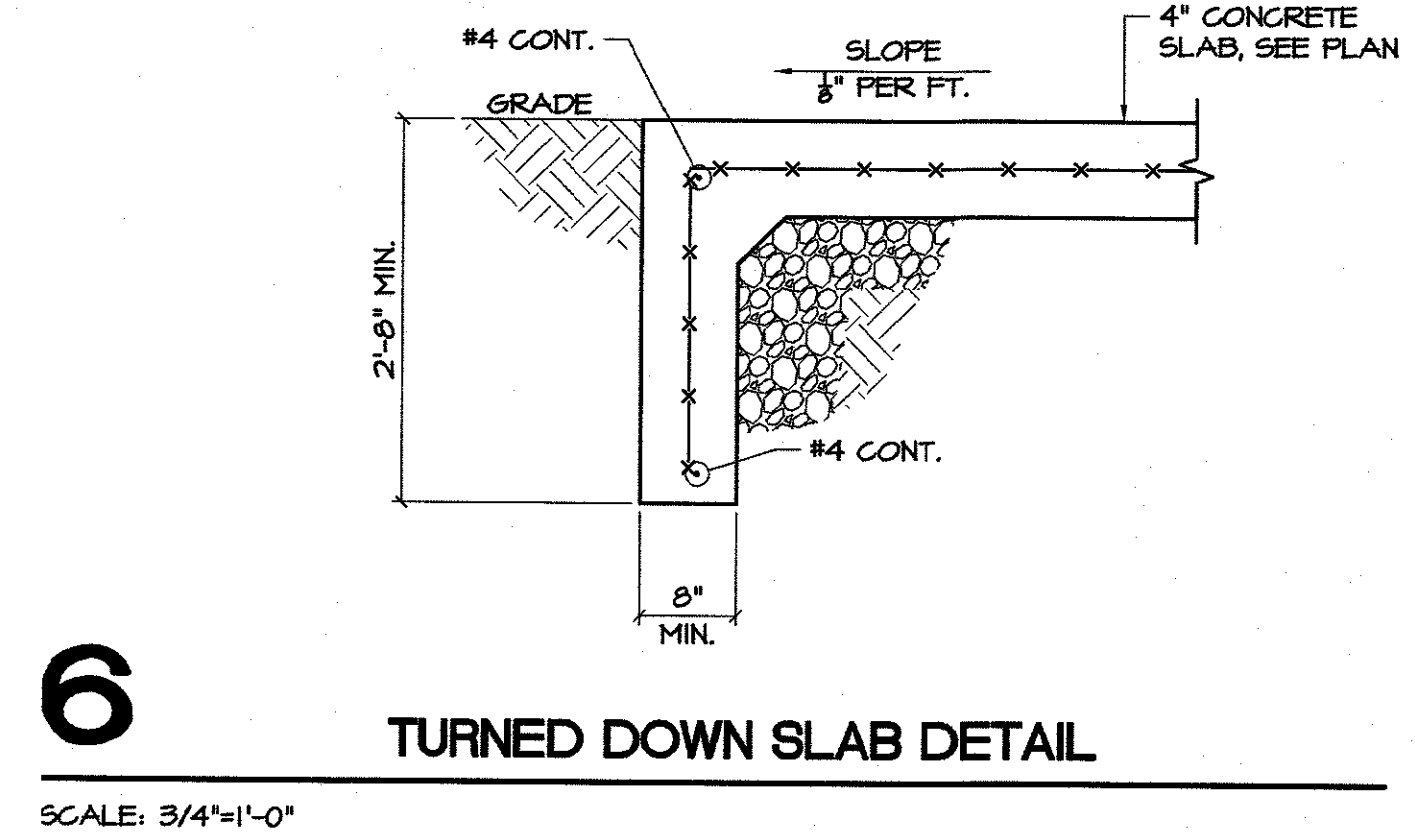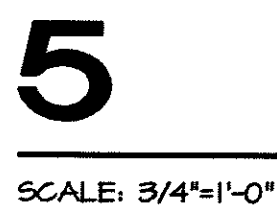
ALL DIMENSIONS MUST BE VERIFIED BY CONTRACTOR
AND RECORDED BEFORE PROCEEDING WITH WORK
DISCREPANCIES BEFORE PROCEEDING WITH WORK
No. 20093
KELLY W. METTING
Professional Engineer
State of Delaware

CURTIS WATER TREATMENT PLANT
IMPROVEMENTS
215 PAPER MILL ROAD
NEWARK, DELAWARE
STRUCTURAL DETAILS
CITY OF NEWARK DEPT. OF PUBLIC WORKS AND WATER RESOURCES
220 SOUTH MAIN STREET
NEWARK, DELAWARE 19711


NO.	DATE	REVISIONS	BY

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PROJECT CNEW1612
DATE APRIL 2017
DRAWING SCALE AS SHOWN
DRAWN BY RJK
APPROVED BY GEL
S6001
SHEET 24 OF 39

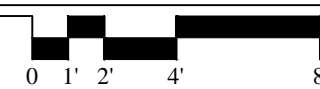

PROJECT STATUS: CONSTRUCTION PLANS
PLOT STYLE: NEW.DWG
PLOT DATE: 4/12/2017 1:39 PM BY: Brian Miller
PROJECT: CURTIS WATER TREATMENT PLANT IMPROVEMENTS

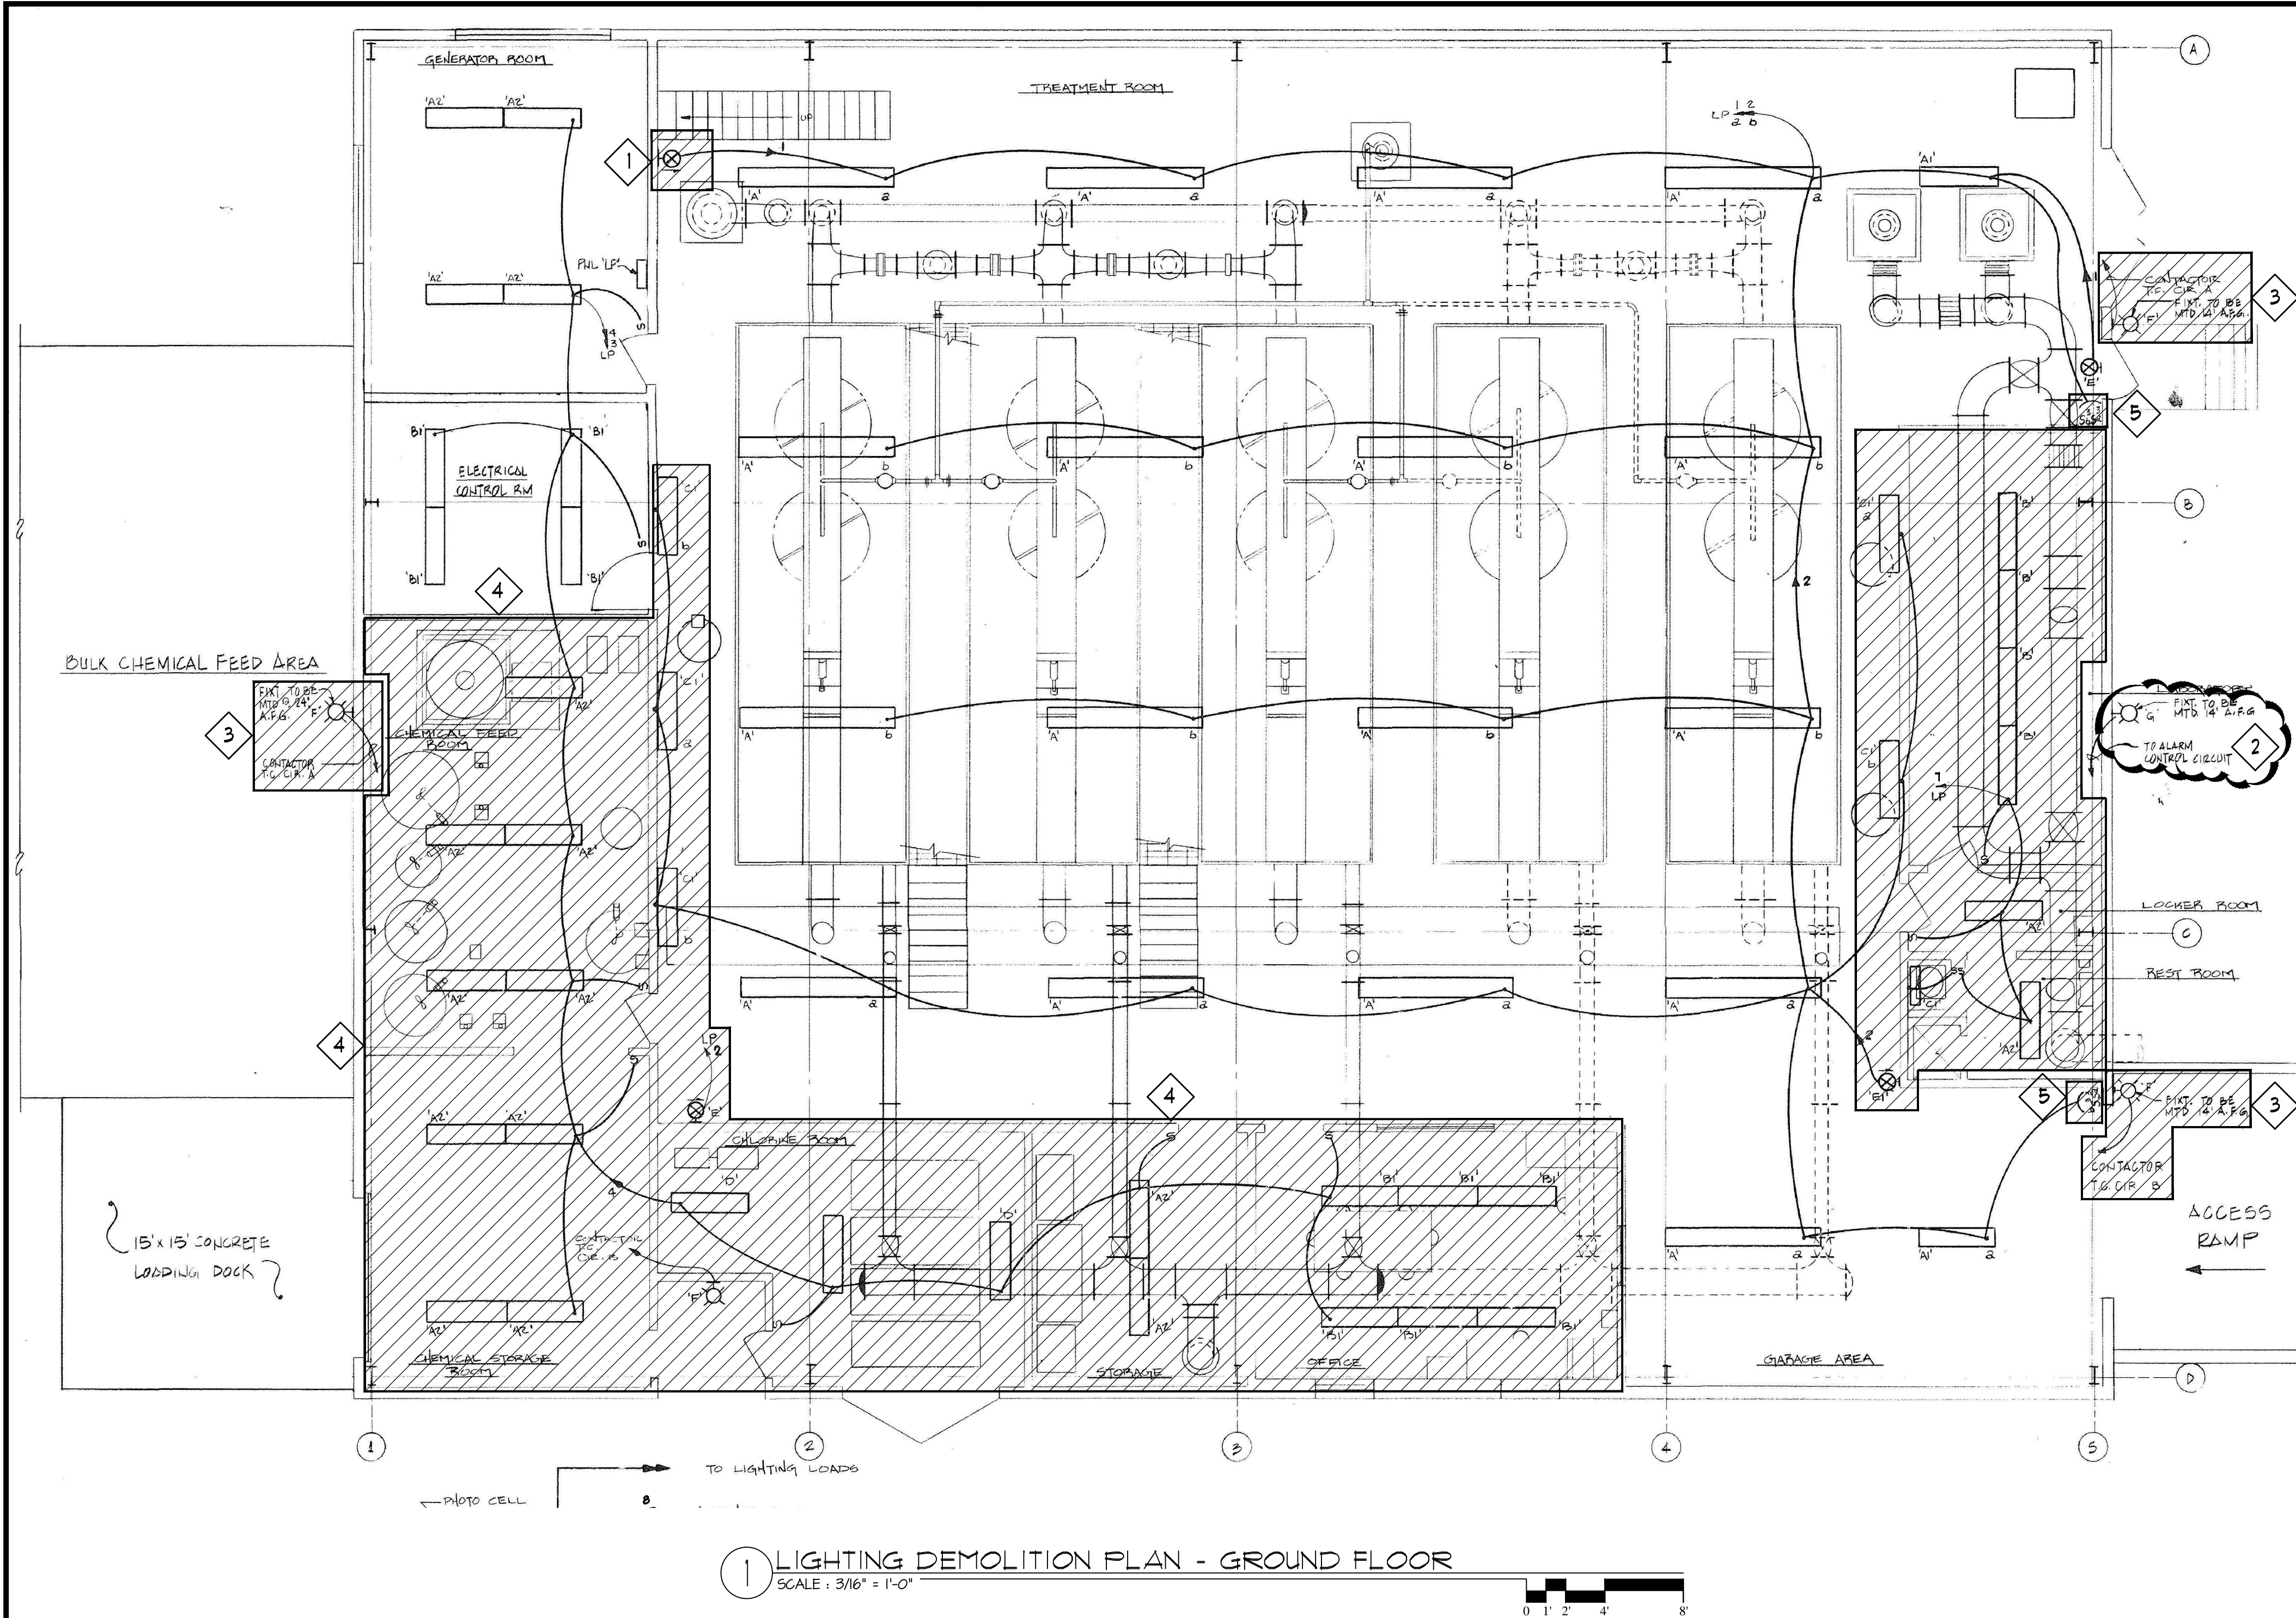

1 LIGHTING DEMOLITION PLAN - GROUND FLOOR
SCALE: 3/16" = 1'-0"

SPECIFIC DEMOLITION NOTES

1. REMOVE EXIT SIGN, CIRCUITING, CONDUIT, SUPPORTS, ETC. IN ITS ENTIRETY FROM WALL BACK TO SOURCE TO ALLOW DEMOLITION AND CONSTRUCTION OF NEW WALL.
2. REMOVE OUTDOOR ALARM STROBE FIXTURE, REWORK/RELOCATE FIXTURE, CIRCUIT, AND CONDUIT AS NECESSARY TO ALLOW REMOVAL OF SIDING. FIXTURE SHALL BE RE-MOUNTED IN NEW WORK.
3. REMOVE OUTDOOR LIGHT FIXTURE, REMOVE CIRCUIT AND CONDUIT BACK TO BUILDING INTERIOR TO ALLOW REMOVAL OF SIDING. SEE DUG. EL1001 (NEW WORK) FOR NEW FIXTURE LOCATIONS.
4. RETAIN (1) "TYPE A2" 4" GASKETED FIXTURES FOR REUSE IN NEW WORK.
5. REMOVE LIGHT SWITCH, SWITCH LEG, AND CONDUIT FROM WALL. COIL AND STORE SWITCH LEG FOR REUSE IN NEW WORK PLAN. SEE DUG. EL1001 (NEW WORK) FOR NEW LIGHT SWITCH LOCATIONS.

DEMOLITION LEGEND:

COMPLETELY DISMANTLE & REMOVE ALL DEVICES, WIRING, CONDUIT, SUPPORTS, ETC. WITHIN HATCHED CLOUDS BACK TO SOURCE.

GENERAL ELECTRICAL DEMOLITION NOTES:

1. CONTRACTOR TO VERIFY ALL FIELD CONDITIONS, CIRCUIT ROUTING, SIZES, REMOVAL AND DISPOSAL METHODS PRIOR TO BEGINNING THE DEMOLITION WORK. COORDINATE DEMOLITION AND TIMING WITH CONSTRUCTION MANAGER AND OWNER PRIOR TO BEGINNING WORK.
2. GENERAL CONTRACTOR IS RESPONSIBLE TO REMOVE FROM BUILDING SITE DEBRIS, TRASH, AND OTHER DISCARDED MATERIALS AND/OR EQUIPMENT RESULTING FROM DEMOLITION OPERATIONS. TRANSPORT AND LEGALLY DISPOSE OFF SITE.
3. IF HAZARDOUS MATERIALS ARE ENCOUNTERED DURING DEMOLITION OPERATIONS, COMPLY WITH APPLICABLE REGULATIONS, LAWS, AND ORDINANCES CONCERNING REMOVAL, HANDLING, AND PROTECTION AGAINST EXPOSURE OR ENVIRONMENTAL POLLUTION.
4. COORDINATE ALL DEMOLITION WITH OWNER AND OTHER TRADES. CONFIRM THE EXTENT, TIMING, AND TERMS TO BE SALVAGED WITH OWNER. CONTRACTOR SHALL SCHEDULE WORK TO LIMIT OVERALL OPERATIONAL DOWNTIME.
5. DURING DEMOLITION ALL UNUSED HANGERS, STRAPS, ANCHORS AND SUPPORTS SHALL BE REMOVED. CONDUIT LEFT UNUSED OR ABANDONED IN PLACE SHALL BE REMOVED.
6. ALL REMOVED EQUIPMENT (I.E. FANS, CONDENSING UNITS, COILS, ETC.) SHALL BE DISPOSED OF PROPERLY ACCORDING TO THE REQUIREMENTS OF THE AUTHORITY HAVING JURISDICTION.
7. ALL EXISTING UNUSED CONDUIT AND SLEEVE PENETRATIONS THROUGH WALLS, FLOORS, PLATFORMS OR ROOFS SHALL BE PATCHED TO MATCH EXISTING FINISHES.
8. CARE MUST BE TAKEN TO PROTECT EXISTING TREATMENT EQUIPMENT IN THE AREA WHICH WILL REMAIN IN SERVICE.



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CURTIS WATER TREATMENT PLANT
IMPROVEMENTS
215 PAPER MILL ROAD
NEWARK, DELAWARE
LIGHTING DEMOLITION GROUND FLOOR PLAN

CITY OF NEWARK DEPT. OF PUBLIC WORKS AND WATER RESOURCES
220 SOUTH MAIN STREET
NEWARK, DELAWARE 19711


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PROJECT	CNEW1612
DATE	APRIL 2017
DRAWING SCALE	AS SHOWN
DRAWN BY	DAP
APPROVED BY	DVH


DE1002
SHEET 26 OF 54

RCP AND SECTION INFORMATION DERIVED FROM
CITY OF NEWARK, WATER TREATMENT FACILITIES
PLANT, CONTRACT W-86-1-1 PREPARED BY TATMAN &
LEE ASSOCIATES, INC. DATED 10/1/1990



FOR GENERAL DEMOLITION NOTES SEE DRAWING DE1001
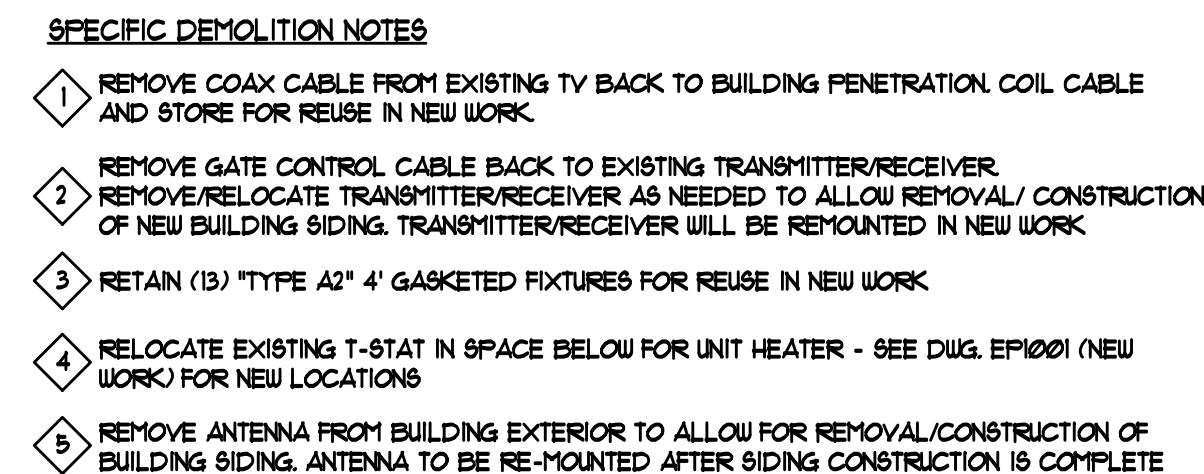
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**CURTIS WATER TREATMENT PLANT
IMPROVEMENTS**
215 PAPER MILL ROAD
NEWARK, DELAWARE

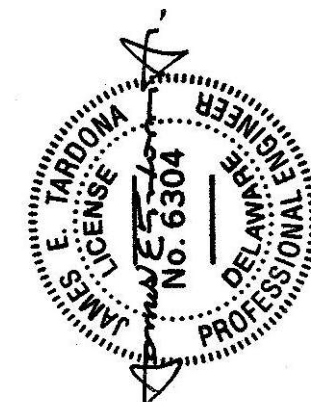POWER&LIGHTING DEMO PLATFORM

CITY OF NEWARK DEPT. OF PUBLIC WORKS AND WATER RESOURCES
220 SOUTH MAIN STREET
NEWARK, DELAWARE 19711

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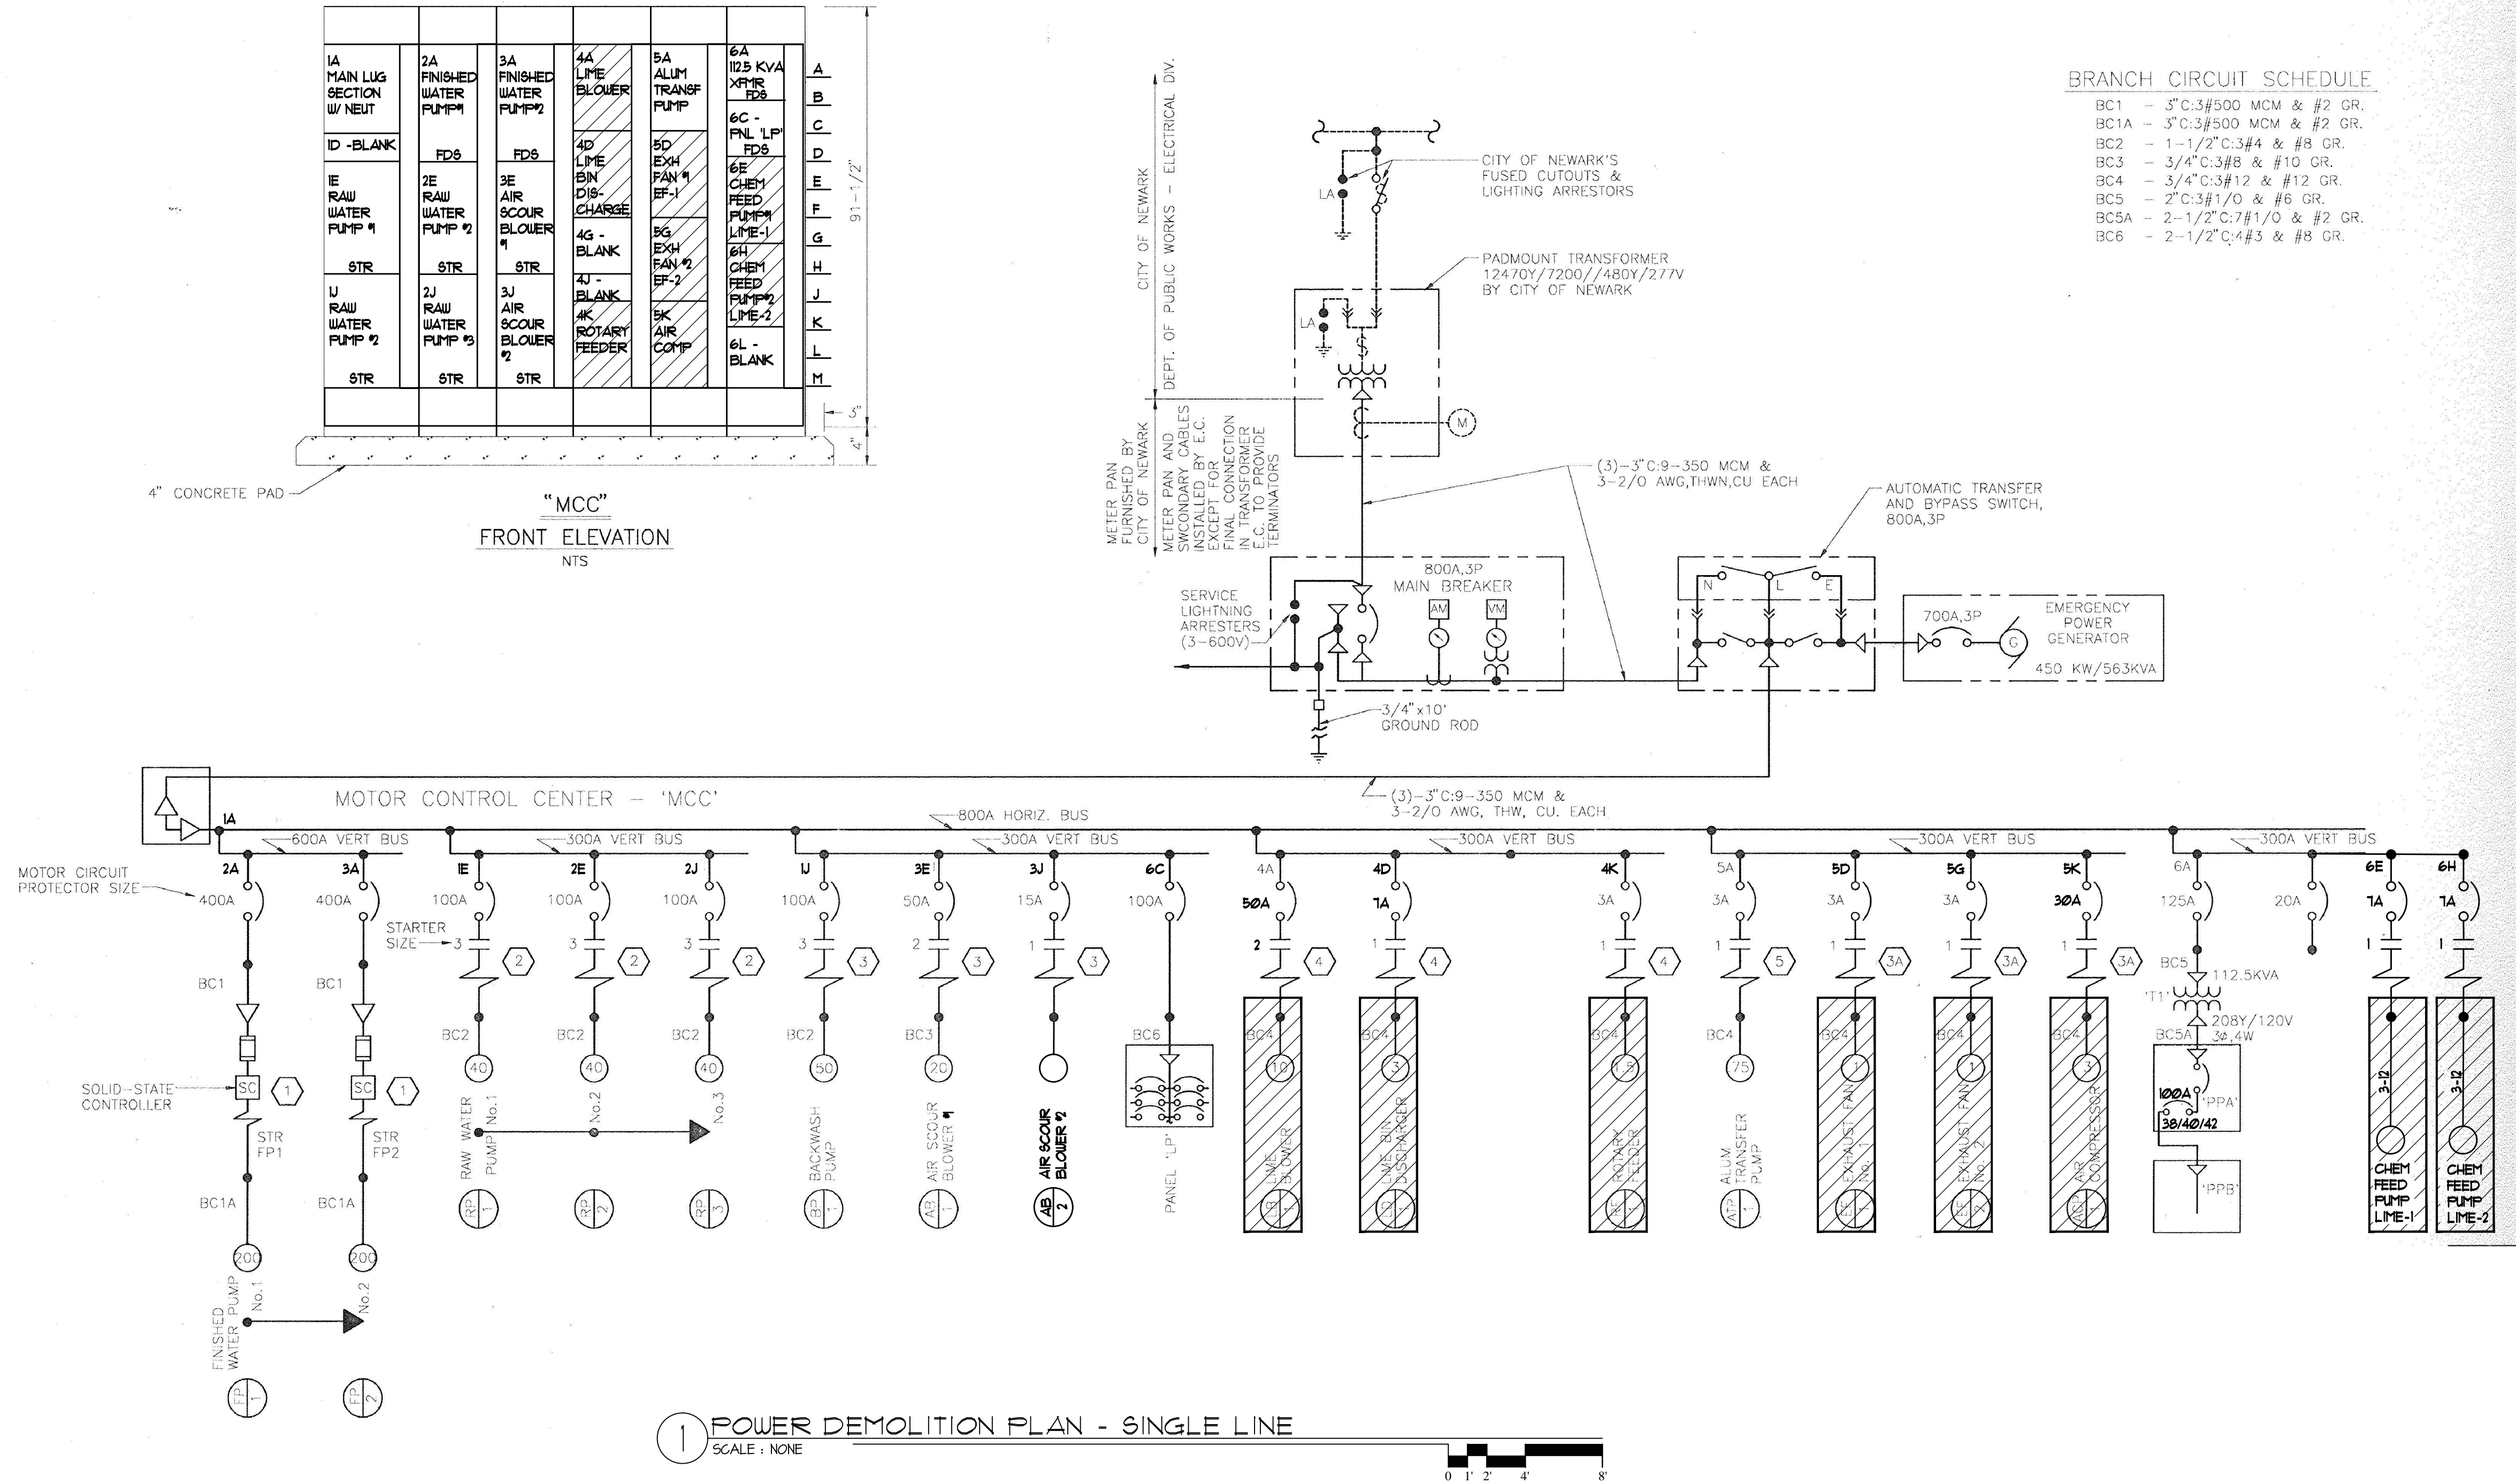
PROJECT	CNEW1612
DATE	APRIL 2017
DRAWING SCALE	AS SHOWN
DRAWN BY	DAP
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DE1003

SHEET 27 OF 54

FLOOR PLAN AND SECTION INFORMATION DERIVED FROM "CITY OF NEWARK, WATER TREATMENT FACILITIES PLANT, CONTRACT W-90-1" PREPARED BY TATMAN & LEE ASSOCIATES, INC. DATED 10/1/1990





FLOOR PLAN AND SECTION INFORMATION DERIVED FROM: CITY OF NEWARK, WATER TREATMENT FACILITIES PLANT, CONTRACT W-90-11 PREPARED BY TATMAN & LEE ASSOCIATES, INC. DATED 10/1/1990

CURTIS WATER TREATMENT PLANT IMPROVEMENTS
SINGLE LINE DIAGRAM DEMOLITION
CITY OF NEWARK DEPT. OF PUBLIC WORKS AND WATER RESOURCES
215 PAPER MILL ROAD
NEWARK, DELAWARE
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NEWARK, DELAWARE 19711

NO.	DATE	REVISIONS	BY

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PROJECT	CNEW1612
DATE	APRIL 2017
DRAWING SCALE	AS SHOWN
DRAWN BY	DAP
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W:\PROJECTS\NEWARK\NEW12\CON\WTP-Improvements\DESIGN\Drawings\Demolition\Background.dwg PLOTTED: 4/22/2017 1:29 PM BY: Brian Miller PROJECT STATUS: CONSTRUCTION PLANS



Panel PPA											
Curtis Water Treatment Plant											
LAST UPDATED 1/13/17											
VOLTS: 208Y/120											
PHASE: 3											
WIRE: 4											
FED FROM : MCC ckt 6A via 112.5KVA Transformer 'T1'											
Surf/Flush mounted Manuf: Cutler Hammer / EATON											
CKT No	DESIGNATION	BRANCH WIRING	C.B. AMPS	LOAD VA	PH	LOAD VA	C.B. AMPS	BRANCH WIRING	DESIGNATION	CKT No	
1	Recept: Treatment room		20		A	20			IG Office	2	
3	Recept: Office		20		B	20			Recept: Storage Rm	4	
5	Recept: Chlorine		20		C	20			Recept: Chemical Storage	6	
7	Recept: Lab, Tur Meters, & Rec		20		A	20			Recept: Lab	8	
9	Recept: Lab, Locker Rm		20		B	20			Ref Lab	10	
11	Recept: Treatment Rm		20		C	20			Recept: Storage & Mezz, Telephone	12	
13	Plugmold Lab		20		A	20			Plugmold Lab	14	
15	Recept: Treatment Rm		20		B	20			Recept: Chemical Rm	16	
17	Recept: Elec Control Rm		20		C	20			Recept: Generator Rm	18	
19	Heat Trace Alum Tank		20		A				AC-1 Office AC/Heater	20	
21	EF-6		15		B					22	
23					C	20			Day Tank	24	
25	EF-4		20		A	20			Fume Hood	26	
27	F-1		15		B				AC-1 Office AC/Heater	28	
29					C	30				30	
31	F-2		15		A	15			Lights, recpt, wet well	32	
33					B					34	
35	Heat Trace Alum Tank		20		C	50			AH-1	36	
37	CJ-1		40		A					38	
39					B	100			Panel PPB	40	
41	Heat Trace Alum Tank		15		C					42	

ITALICS DENOTES ESTIMATED.											
Shaded Areas Indicates - Demolition											
Total											
Date read											
FAX Changes to Panel Directory to Pennoni : (302) 234 - 4610											

CNEW1612 - PPA.xlsx

Page 1 of 1

Panel PPB											
Curtis Water Treatment Plant											
LAST UPDATED 1/13/17											
VOLTS: 208Y/120											
PHASE: 3											
WIRE: 4											
FED FROM : Panel 'PPA' ckts 38/40/42											
Surf/Flush mounted Manuf: Cutler Hammer / EATON											
CKT No	DESIGNATION	BRANCH WIRING	C.B. AMPS	LOAD VA	PH	LOAD VA	C.B. AMPS	BRANCH WIRING	DESIGNATION	CKT No	
1	Mixer Alum & Polymer		20		A	20			Mixer Polymer & Potassium Permanganate	2	
3	Mixer Activated Carbon		20		B	20			CFP POT 1&2	4	
5	CFP-AC 1&2		20		C	20			CFP P1, P2 & FUT Polymer Pumps	6	
7	BLANK		20		A	20			PWC (Turn off to Adj Float)	8	
9	CFP-F 1&2		20		B	20			MCP	10	
11	Motorized Valves Unit #1		20		C	20			Motorized Valves Unit #2	12	
13	Motorized Valves Unit #3		20		A	20			Motorized Valves Unit #4	14	
15	Motorized Valves Unit #5		20		B	20			Cp Panel	16	
17	Telemetry System		20		C	20			Aquaritrrol & FWEP (Hand Held Contr.)	18	
19	AFP 3-way Alum Valve		20		A	30			LFP Line Panel - Auger	20	
21	Motor Operated Door		20		B	20			Battery Charger	22	
23	LCP		20		C					24	
25	EF-3				A	20			Jacket Heater	26	
27	Chlorine Exhaust		20		B	20			LTP	28	
29	RCP-1		20		C	20			Chlorine Pump Treatment Rm	30	
31	RCP-2		20		A					32	
33	RCP-3		20		B	20			BLANK	34	
35	RCP-4		20		C					36	
37	RCP-5		20		A	20			Honeywell Panel	38	
39	Sewer Lift Pump		20		B					40	
41	Sewer Alarm		15		C	30			Block Heater	42	

ITALICS DENOTES ESTIMATED.											
Shaded Areas Indicates - Demolition											
Total											
Date read											
FAX Changes to Panel Directory to Pennoni : (302) 234 - 4610											

CNEW1612 - PPB.xlsx

Page 1 of 1

Panel LP											
Curtis Water Treatment Plant											
LAST UPDATED 1/13/17											
VOLTS: 480Y/277											
PHASE: 3											
WIRE: 4											
FED FROM : MCC ckt 6A											
Surf/Flush mounted Manuf: Cutler Hammer / EATON type PH											
CKT No	DESIGNATION	BRANCH WIRING	C.B. AMPS	LOAD VA	PH	LOAD VA	C.B. AMPS	BRANCH WIRING	DESIGNATION	CKT No	
1	Lights: Treatment Rm. W. Side		20		A	20			Lights: Treatment Rm Center	2	
3	Lights: Chem Stor, Chem treatment, ECR		20		B	20			Lights: Chlor, Office, Storage	4	
5	Lights: Storage Area		20		C	20			Lights: Mezz, Storage Area	6	
7	Lab Lights		20		A	20			Outside Lights ViaTime Clock in ECR	8	
9	Heater, Lab		20		B	20			Unit Heater UH-1	10	
11	UH-2		20		C	20			Unit Heater UH-4	12	
13	UH-3		30		A	30			Unit Heater UH-5	14	
15	UH-6		30		B				BLANK	16	
17	BLANK				C	30			Water Heater	18	
19					A	20			Baseboard Heaters	20	
21			20		B				BLANK	22	
23					C				BLANK	24	
25					A					26	
27	Duct Heater Chemical Room		20		B	15			Duct Heater Chlorine Room	28	
29					C					30	
31					A					32	
33	Holst Chlorine room		15		B	15				34	
35					C					36	



ITALICS DENOTES ESTIMATED.											
Shaded Areas Indicates - Demolition											
Total											
Date read											
FAX Changes to Panel Directory to Pennoni : (302) 234 - 4610											

CNEW1612 - LP.xlsx

Page 1 of 1


1 POWER DEMOLITION PLAN - PANEL SCHEDULES

SCALE : NONE

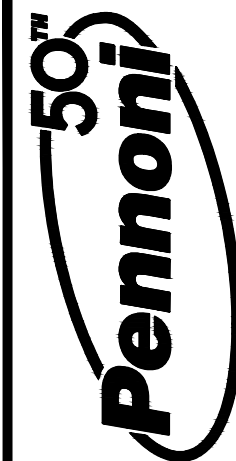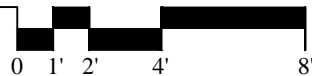

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CURTIS WATER TREATMENT PLANT
IMPROVEMENTS

215 PAPER MILL ROAD
NEWARK, DELAWARE
DEMOLITION - PANEL SCHEDULES

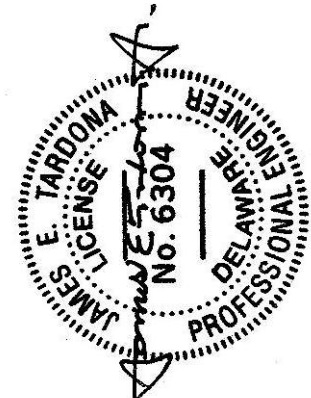CITY OF NEWARK DEPT. OF PUBLIC WORKS AND WATER RESOURCES
220 SOUTH MAIN STREET
NEWARK, DELAWARE 19711

NO.	DATE	REVISIONS	BY


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PROJECT	CNEW1612
DATE	APRIL 2017
DRAWING SCALE	AS SHOWN
DRAWN BY	DAP
APPROVED BY	DVH

DE1005
SHEET 29 OF 54

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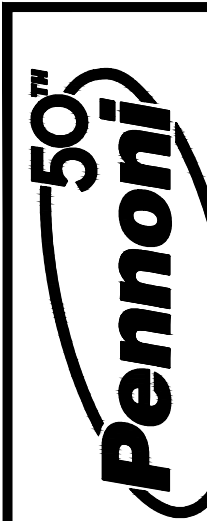
PROJECT: CURTIS WATER TREATMENT PLANT IMPROVEMENTS
DRAWING: POWER NEW WORK GROUND FLOOR
DATE: 4/20/2017 11:30 AM BY: Brian Miller
PLOT FILE: NEWWORK.dwg



1 POWER NEW WORK PLAN - GROUND FLOOR
SCALE: 3/16" = 1'-0"

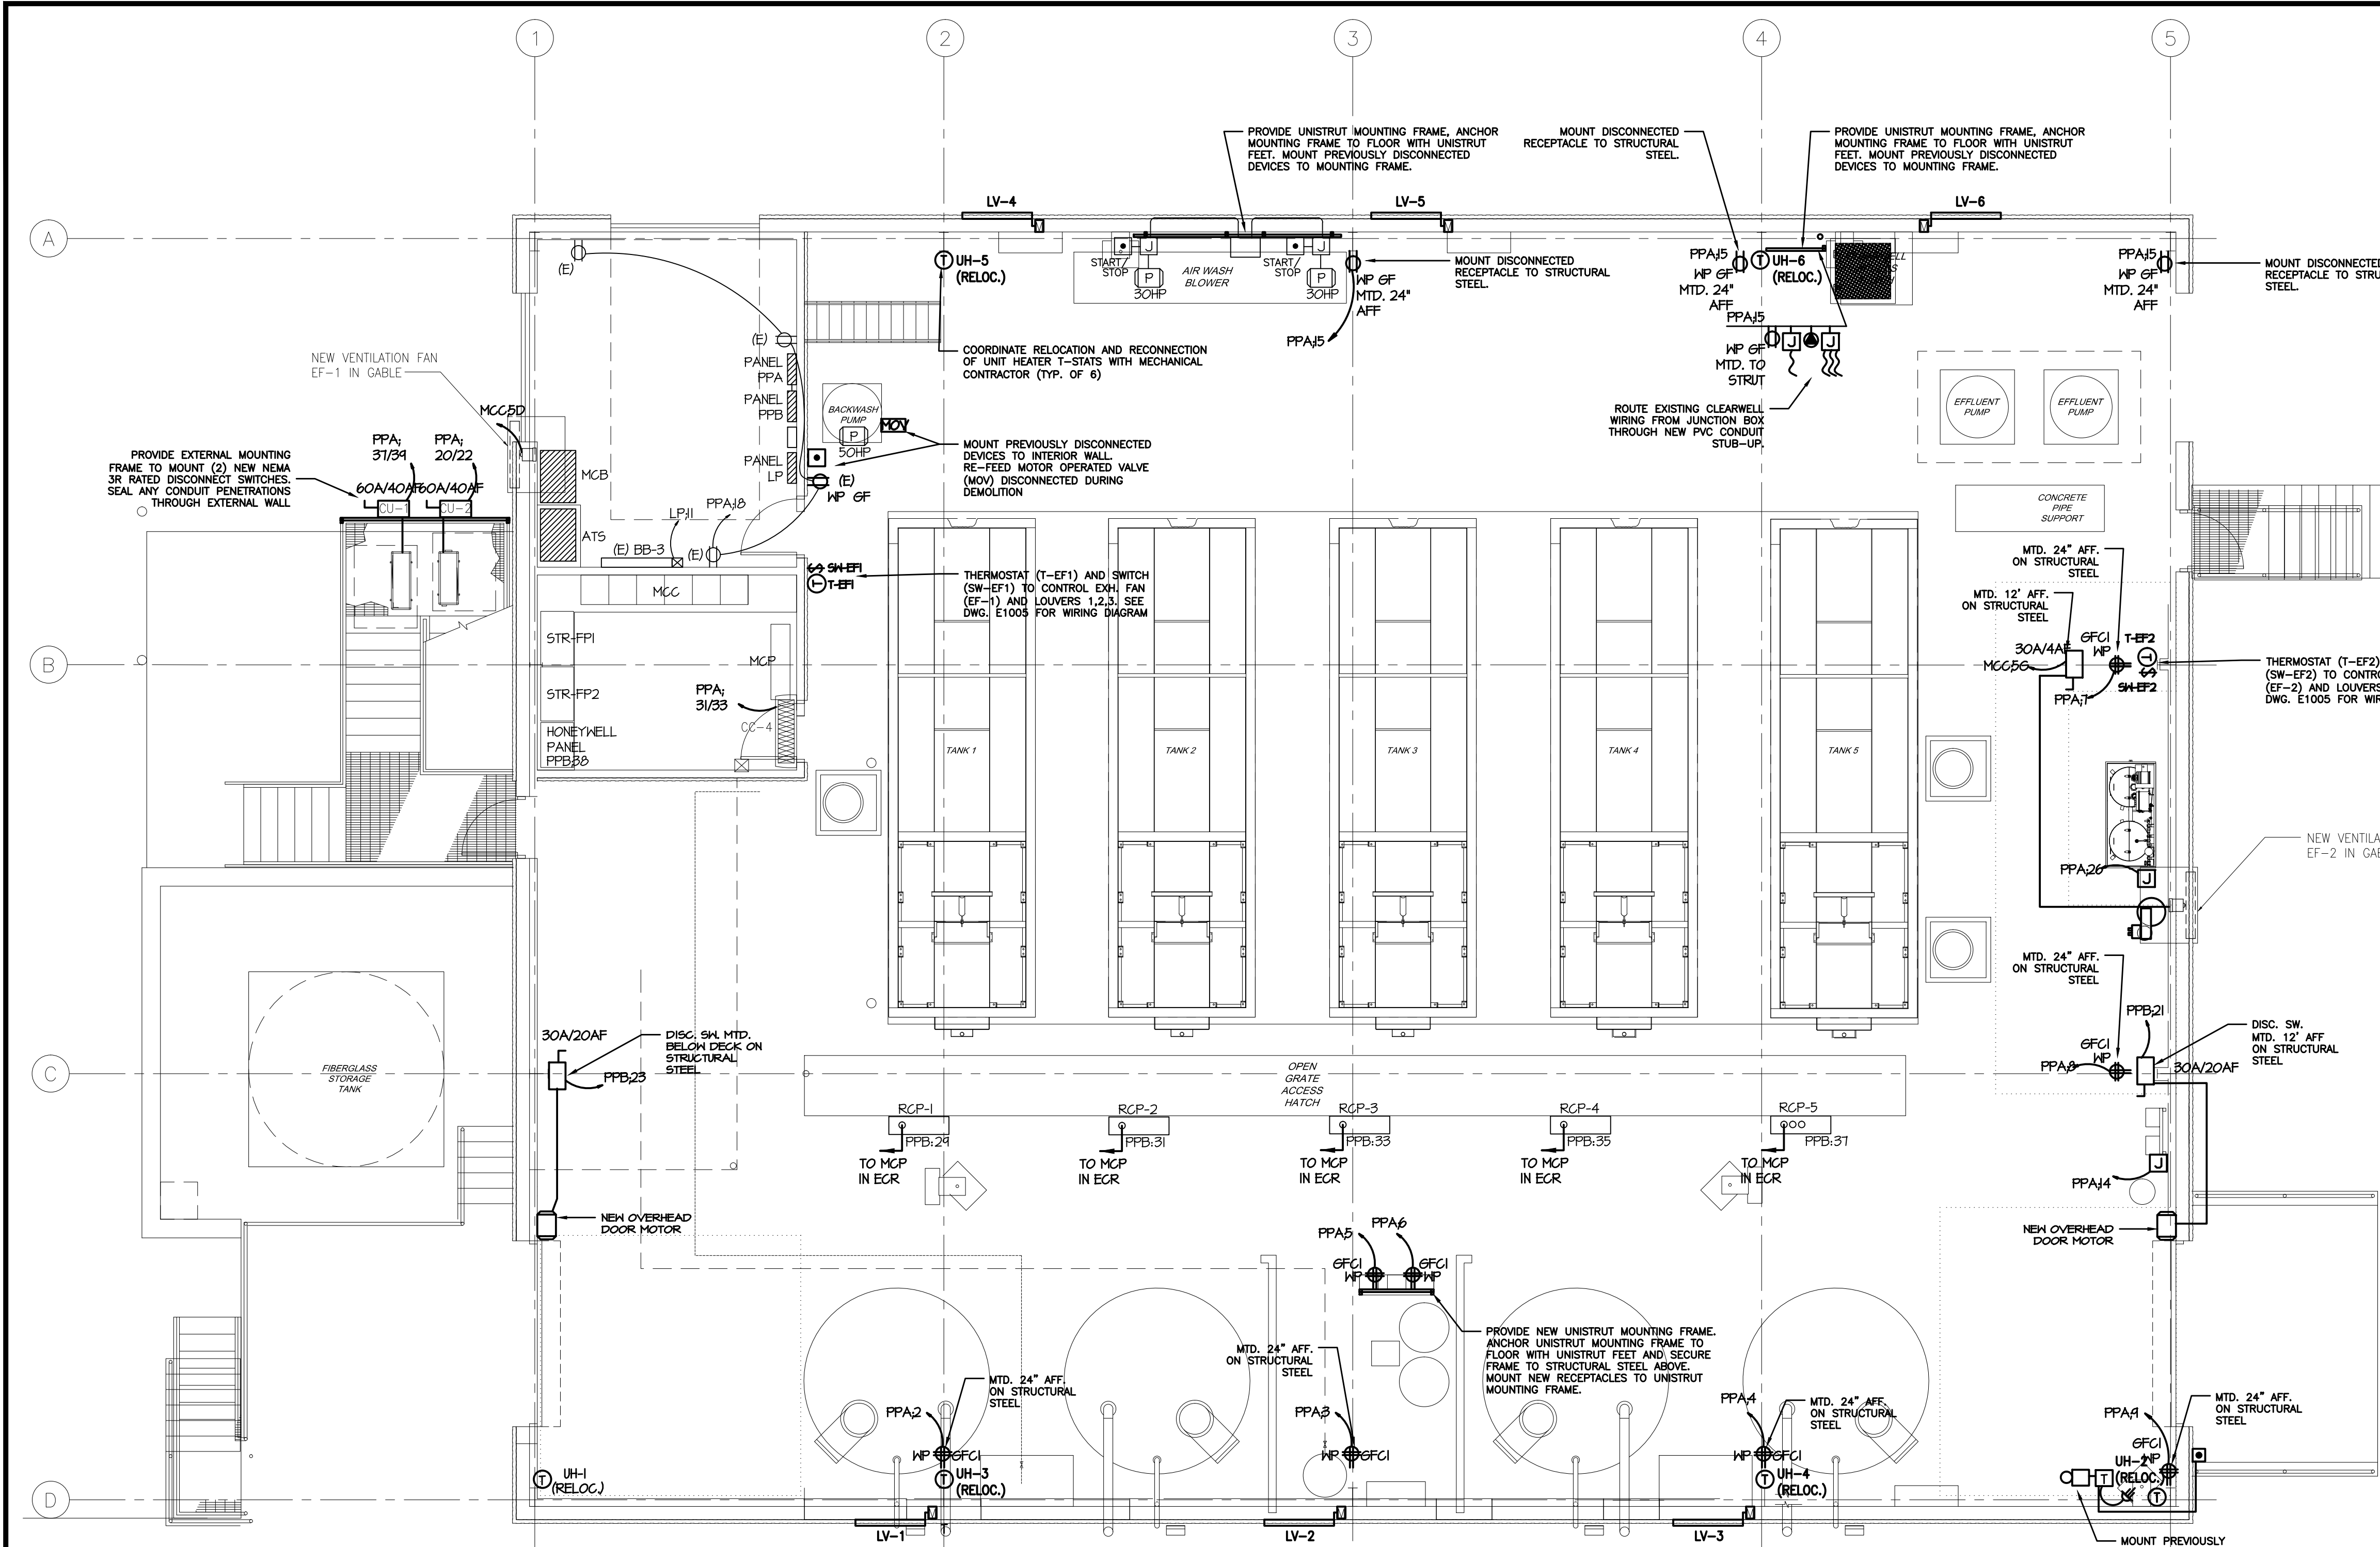POWER PLAN SYMBOLS

- NEHA 2 RATED DISCONNECT SWITCH
30A/4A
- 2-POLE MANUAL SWITCH
- DUPLEX RECEPTACLE
- QUAD RECEPTACLE
- SPECIAL PURPOSE RECEPTACLE
- PUSHBUTTON
- DATA OUTLET
- JUNCTION BOX
- MOTOR
- THERMOSTAT
- SINGLE POLE SWITCH
- WIREMOLD



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CURTIS WATER TREATMENT PLANT
IMPROVEMENTS
POWER NEW WORK GROUND FLOOR
215 PAPER MILL ROAD
NEWARK, DELAWARE
CITY OF NEWARK DEPT. OF PUBLIC WORKS AND WATER RESOURCES
220 SOUTH MAIN STREET
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PROJECT	CNEW1612
DATE	APRIL 2017
DRAWING SCALE	AS SHOWN
DRAWN BY	DAP
APPROVED BY	DVH

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SHEET 30 OF 54

FLOOR PLAN AND SECTION INFORMATION DERIVED
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FACILITIES PLANT, CONTRACT W-90-11 PREPARED BY
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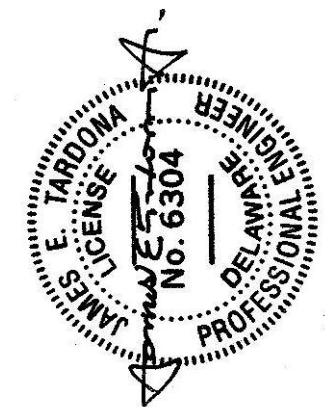


FLOOR PLAN AND SECTION INFORMATION DERIVED
FROM "CITY OF NEWARK, WATER TREATMENT
FACILITIES PLANT, CONTRACT W-90-1" PREPARED BY
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CURTIS WATER TREATMENT PLANT
IMPROVEMENTS
215 PAPER MILL ROAD
NEWARK, DELAWARE

LIGHTING NEW WORK GROUND FLOOR

CITY OF NEWARK DEPT. OF PUBLIC WORKS AND WATER RESOURCES
220 SOUTH MAIN STREET


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PROJECT	CNEW1612
DATE	APRIL 2017
DRAWING SCALE	AS SHOWN
DRAWN BY	DAP
APPROVED BY	DVH

E1003

SHEET 32 OF 54



FLOOR PLAN AND SECTION INFORMATION DERIVED FROM: CITY OF NEWARK, WATER TREATMENT FACILITIES PLANT, CONTRACT W-90-1* PREPARED BY TATMAN & LEE ASSOCIATES, INC. DATED 10/1/1990

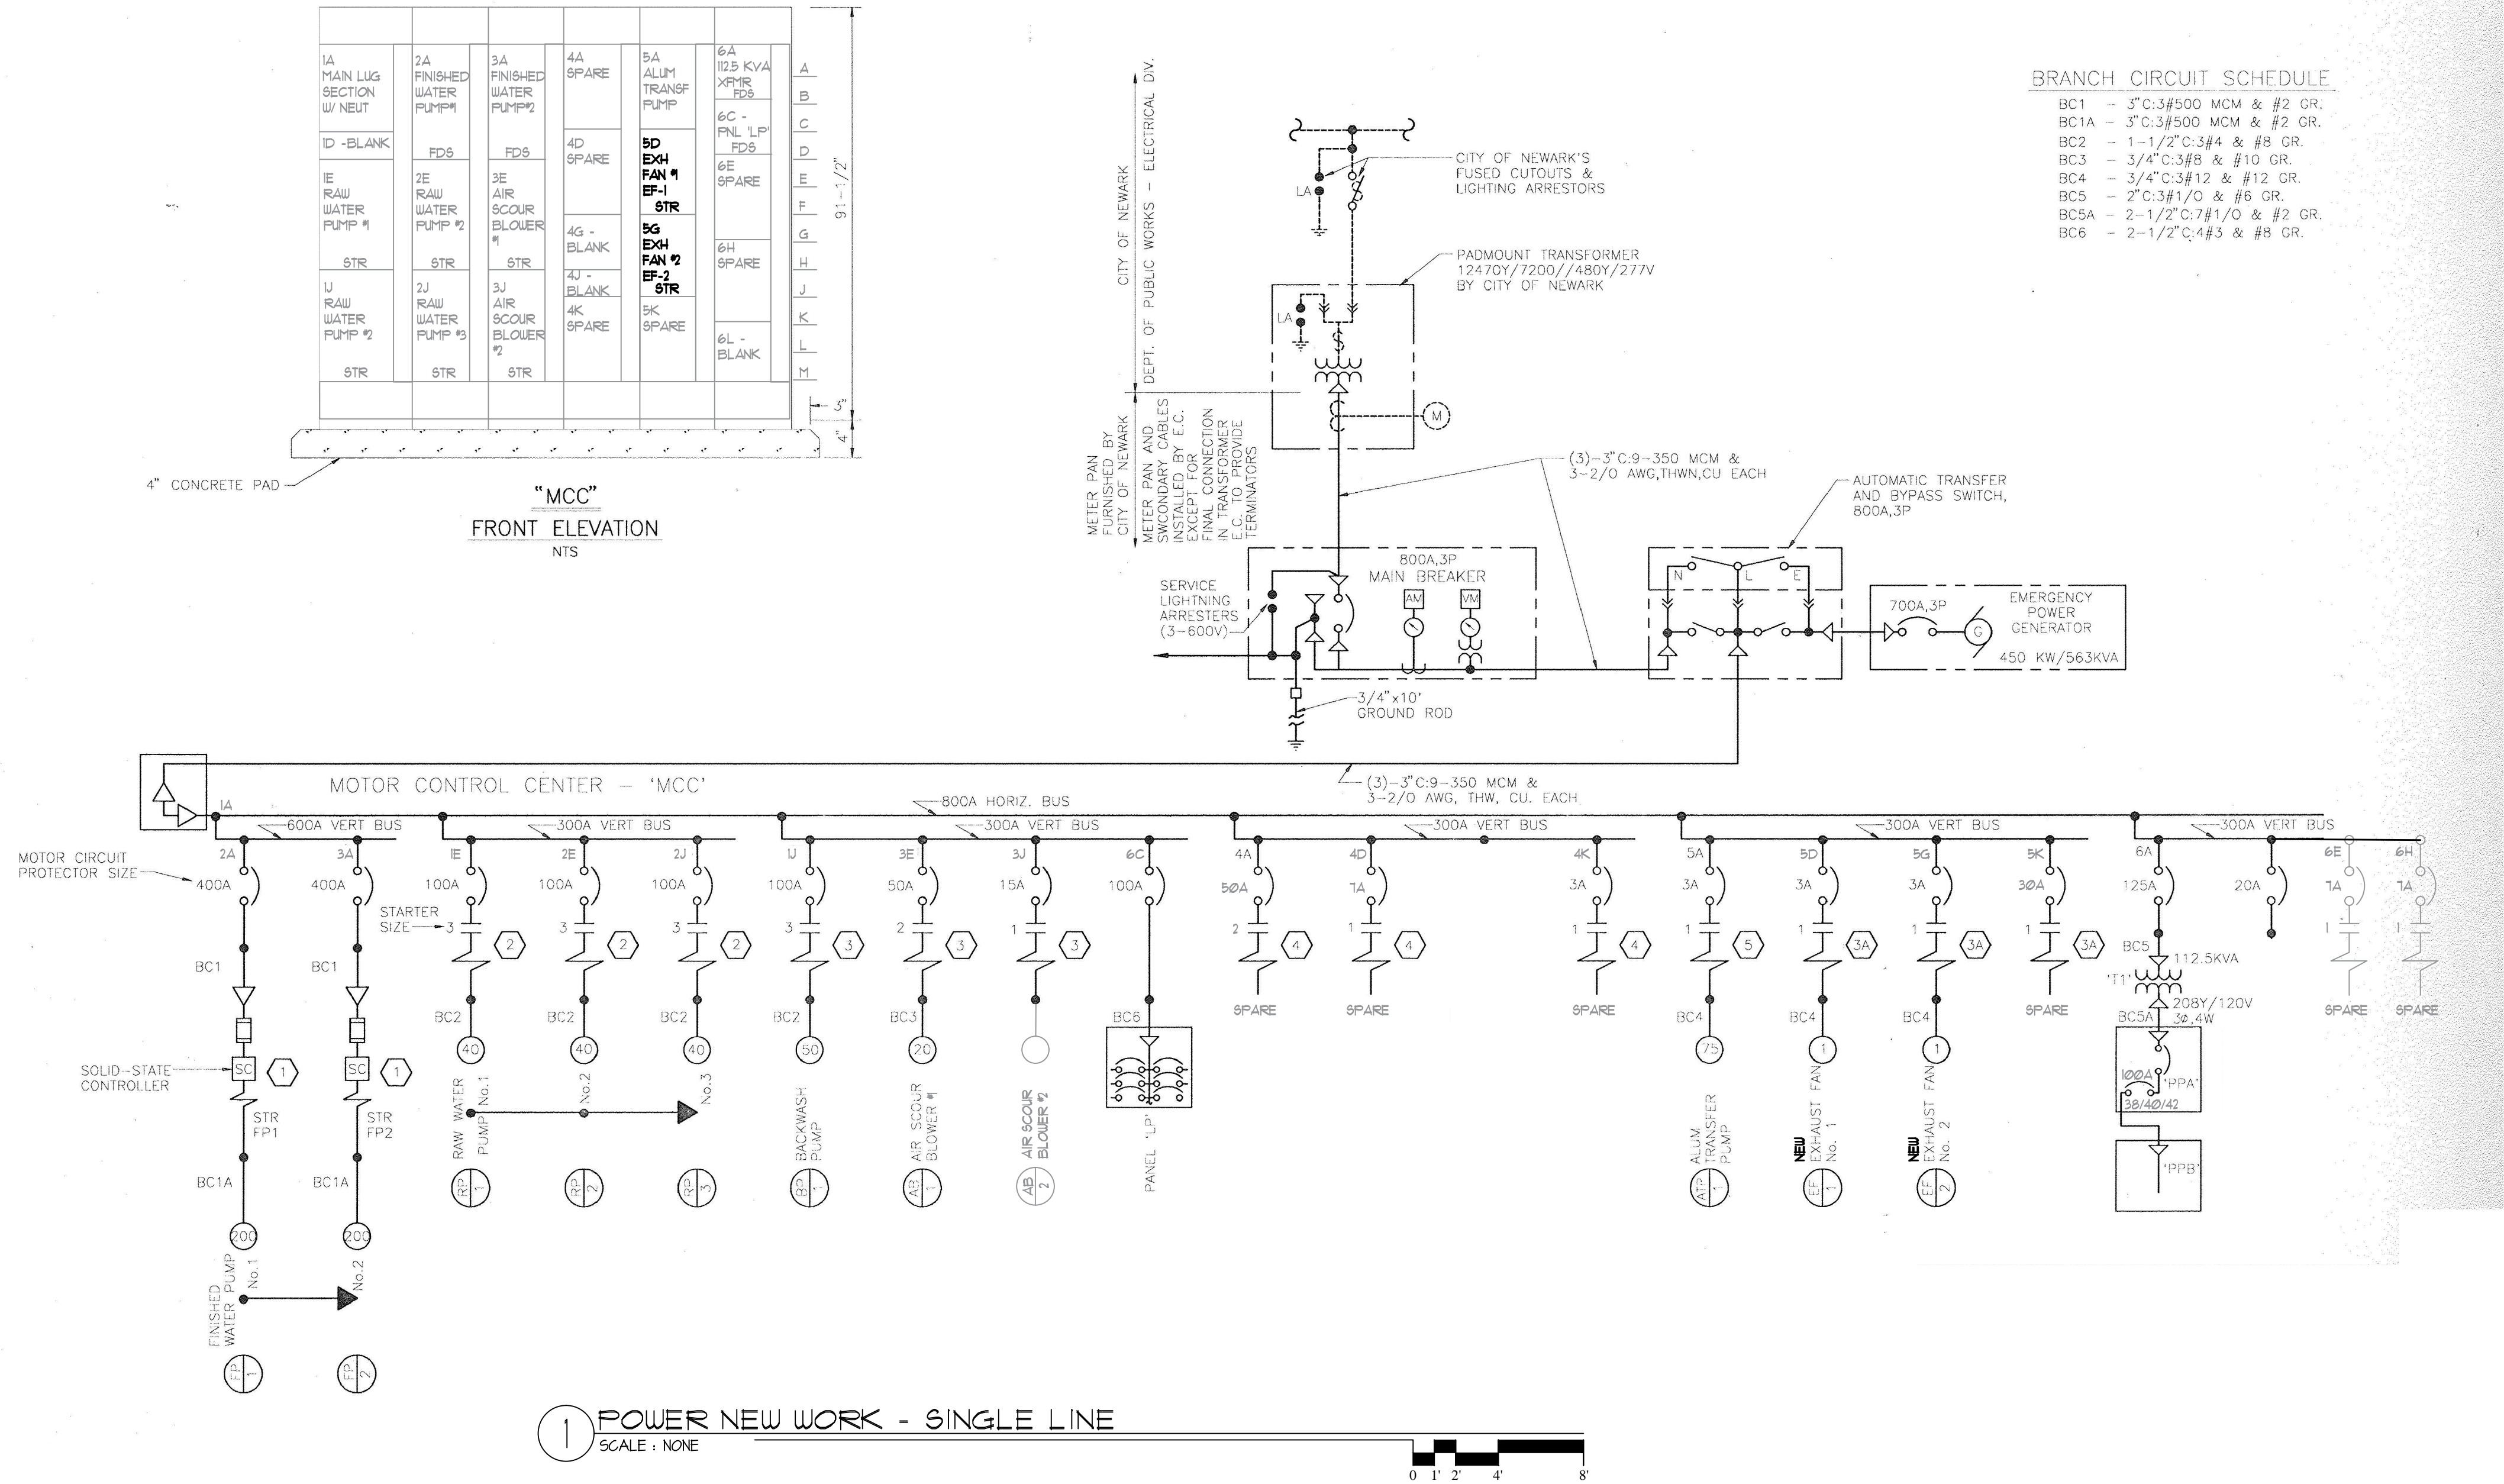
CURTIS WATER TREATMENT PLANT IMPROVEMENTS
SINGLE LINE DIAGRAM NEW WORK
215 PAPER MILL ROAD
NEWARK, DELAWARE
CITY OF NEWARK DEPT. OF PUBLIC WORKS AND WATER RESOURCES
220 SOUTH MAIN STREET
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PROJECT	CNEW1612
DATE	APRIL 2017
DRAWING SCALE	AS SHOWN
DRAWN BY	DAP
APPROVED BY	DVH

E1004
SHEET 33 OF 54

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LAST UPDATED 1/20/17

Panel PPA Curtis Water Treatment Plant

VOLTS: 208Y/120
PHASE: 3
WIRE: 4

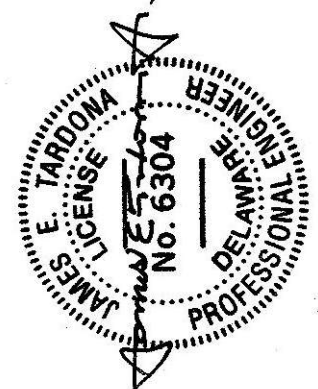New Work (CNEW-1612)
Curtis Water Plant

CKT No	DESIGNATION	BRANCH WIRING	C.B. AMPS	LOAD VA	PH	LOAD VA	C.B. AMPS	BRANCH WIRING	DESIGNATION	CKT No
1	Recept: Office 201 TV & ERV in wall	2#12 & 12g	20		A	20		2#12 & 12g	Recept: South East Quad	2
3	Recept: East Quad	2#12 & 12g	20		B	20		2#12 & 12g	Recept: Northeast Quad, Pump Skid	4
5	Recept: Quad, LMI Pumps	2#12 & 12g	20		C	20		2#12 & 12g	Recept: Quad, LMI Pumps	6
7	Recept: Northwest Quad	2#12 & 12g	20		A	20		2#12 & 12g	Recept: North Quad	8
9	Recept: Northeast Quad	2#12 & 12g	20		B	20		2#12 & 12g	Recepts: Lab 202 Fridge & Convenience	10
11	Recepts: Lab 202 Wiremold	2#12 & 12g	20		C	20		2#12 & 12g	Recept: Storage & Mezz, Telephone	12
13	Recepts: Office 201 Convenience	2#12 & 12g	20		A	20		2#12 & 12g	J-Box: North Pump Equipment	14
15	Recept: Treatment Rm		20		B	20		2#12 & 12g	Recept: Toilet 203, Exhaust Fan, Lights 201,202,203	16
17	Recept: Elec Control Rm		20		C	20			Recept: Generator Rm	18
19	Heat Trace Alum Tank		20		A			2#8 & 10g	Disconnect Switch: Condensing Unit #2 (CU-2)	20
21	SPARE		15		B					22
23	SPARE		20		C				Day Tank	24
25	SPARE		20		A			2#12 & 12g	J-Box: North Process Equipment	26
27	SPARE		15		B				SPARE	28
29	SPARE		15		C					30
31	Ceiling Cassette Units: 201,202,203, & ECR	2#12 & 12g	15		A				Lights, recept, wet well	32
33					B			2#6 & 10g	Hot Water Heater DWHE-1; Platform Storage Area	34
35	Heat Trace Alum Tank		20		C					36
37	Disconnect Switch: Condensing Unit #1 (CU-1)	2#8 & 10g	40		A					38
39					B				Panel PPB	40
41	Heat Trace Alum Tank		15		C					42

Replace existing 30A/2P CB with 35A/2P CB

ITALICS DENOTES ESTIMATED.

Shaded Areas Indicates - New Work

Total

Date read

FAX Changes to Panel Directory to Pennoni : (302) 234 - 4610

Pennoni

PENNONI ASSOCIATES INC.
CONSULTING ENGINEERS

CNEW1612 - PPA.xlsx

Page 1 of 1

LAST UPDATED 1/20/17

Panel PPB Curtis Water Treatment Plant

VOLTS: 208Y/120
PHASE: 3
WIRE: 4

New Work (CNEW-1612)
Curtis Water Plant

CKT No	DESIGNATION	BRANCH WIRING	C.B. AMPS	LOAD VA	PH	LOAD VA	C.B. AMPS	BRANCH WIRING	DESIGNATION	CKT No
1	Mixer Alum & Polymer		20		A	20			Mixer Polymer & Potassium Permanganate	2
3	Mixer Activated Carbon		20		B	20			SPARE	4
5	CFP-AC 1&2		20		C	20			SPARE	6
7	BLANK		20		A	20			PWC (Turn off to Adj Float)	8
9	CFP-F 1&2		20		B	20			MCP	10
11	Motorized Valves Unit #1		20		C	20			Motorized Valves Unit #2	12
13	Motorized Valves Unit #3		20		A	20			Motorized Valves Unit #4	14
15	Motorized Valves Unit #5		20		B	20			Cp Panel	16
17	Telemetry System		20		C	20			Aquanitrol & FWEP (Hand Held Contr.)	18
19	SPARE		20		A	30			SPARE	20
21	Motor Operated Door		20		B	20			Battery Charger	22
23	Motor Operated Door, South Door	2#12 & 12g	20		C				Jacket Heater	24
25	SPARE		20		A					26
27	SPARE		20		B				SPARE	28
29	RCP-1		20		C	20			Chlorine Pump Treatment Rm	30
31	RCP-2		20		A					32
33	RCP-3		20		B				BLANK	34
35	RCP-4		20		C					36
37	RCP-5		20		A	20			Honeywell Panel	38
39	Sewer Lift Pump		20		B	30			Block Heater	40
41	Sewer Alarm		15		C					42

ITALICS DENOTES ESTIMATED.

Shaded Areas Indicates - New Work

Total

Date read

FAX Changes to Panel Directory to Pennoni : (302) 234 - 4610

Pennoni

PENNONI ASSOCIATES INC.
CONSULTING ENGINEERS

CNEW1612 - PPB.xlsx

Page 1 of 1

LAST UPDATED 1/20/17

Panel LP Curtis Water Treatment Plant

VOLTS: 480Y/277
PHASE: 3
WIRE: 4

New Work (CNEW-1612)
Curtis Water Plant

CKT No	DESIGNATION	BRANCH WIRING	C.B. AMPS	LOAD VA	PH	LOAD VA	C.B. AMPS	BRANCH WIRING	DESIGNATION	CKT No
1	Lights: Treatment Rm. W. Side		20		A	20			Lights: Treatment Rm Center	2
3	Lights: Chem Stor, Chem treatment, ECR		20		B	20			SPARE	4
5	Lights: Exterior VIA Time Clock in ECR		20		C	20			Lights: Mezz, Storage	6
7	Lab Lights		20		A	20			BLANK	8
9	BLANK		20		B	20			SPARE	10
11	UH-2		20		C	20			Unit Heater UH-4	12
13	UH-3		30		A	30			Unit Heater UH-5	14
15	UH-6		30		B				BLANK	16
17	BLANK				C	30			Water Heater	18
19					A	20				20
21			20		B				BLANK	22
23					C				BLANK	24
25					A					26
27	Duct Heater Chem		20		B	15			Duct Chem	28
29					C					30
31					A					32
33	Hoist		15		B	15				34
35					C					36

ITALICS DENOTES ESTIMATED.

Shaded Areas Indicates - New Work

Total

Date read

FAX Changes to Panel Directory to Pennoni : (302) 234 - 4610


Pennoni

PENNONI ASSOCIATES INC.
CONSULTING ENGINEERS


CNEW1612 - LP.xlsx

Page 1 of 1


BUILDING GABLE WEST
EXHAUST FAN EF-1
POWER PLAN: E1002
SINGLE LINE: E1005

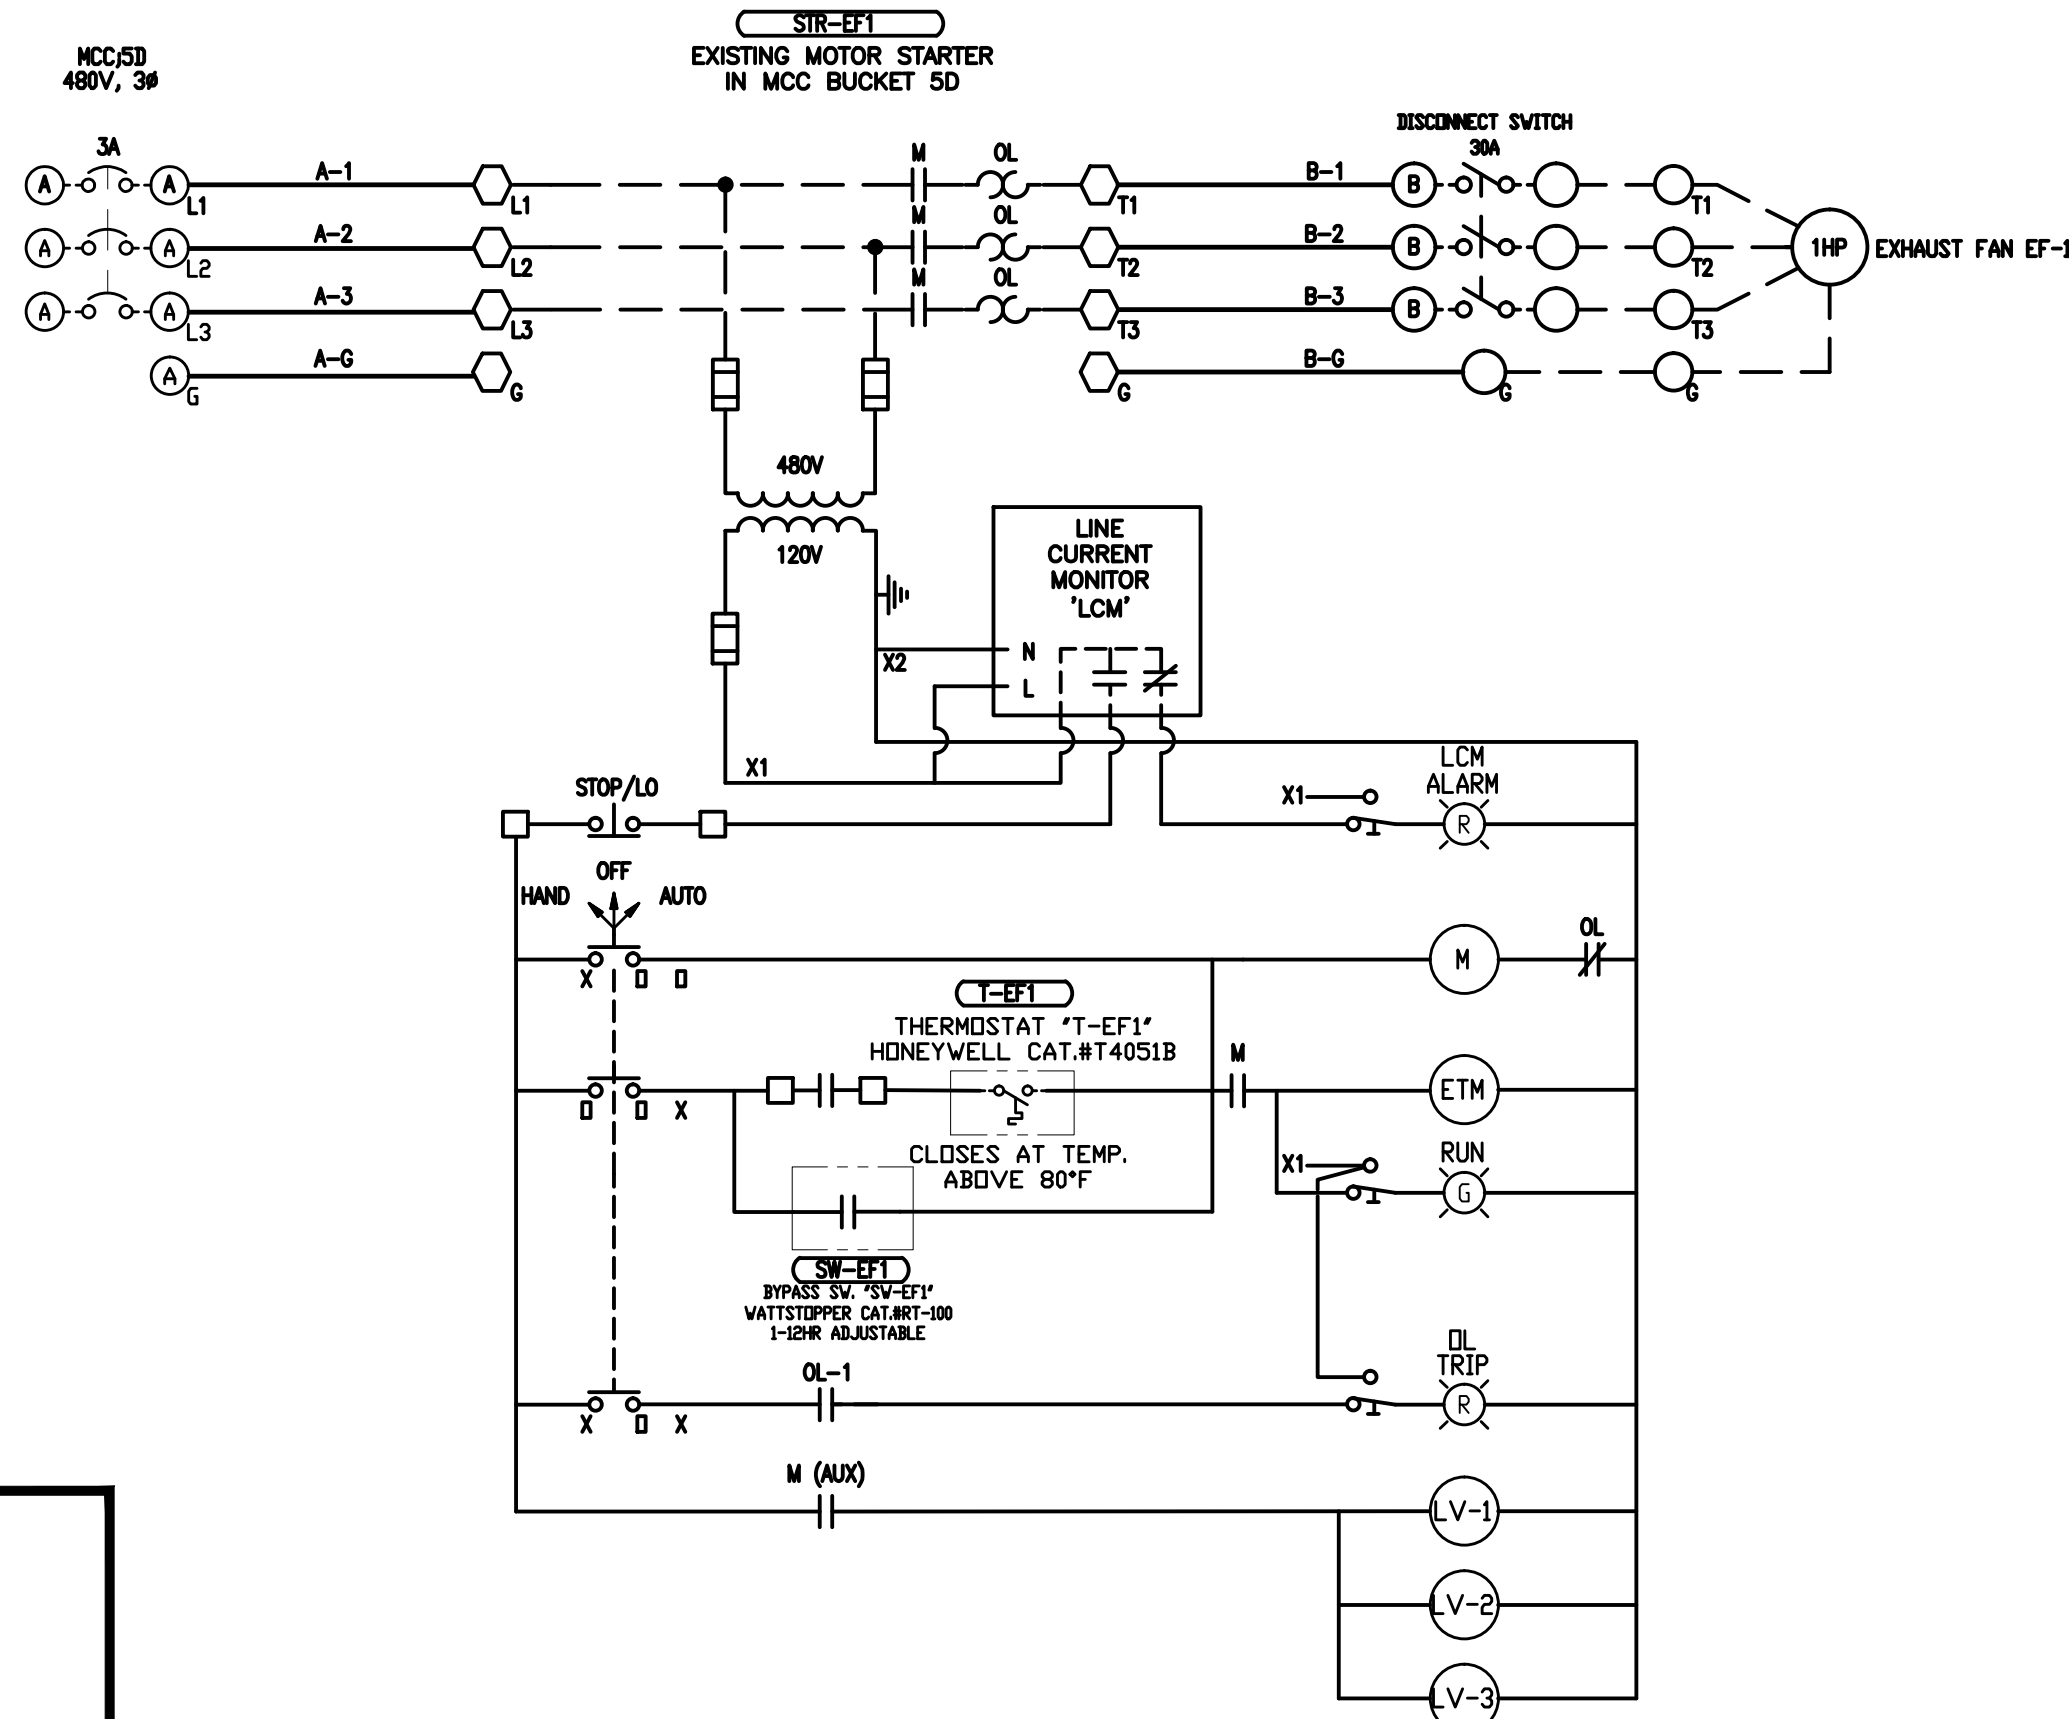

BUILDING GABLE EAST
EXHAUST FAN EF-2
POWER PLAN: E1002
SINGLE LINE: E1005

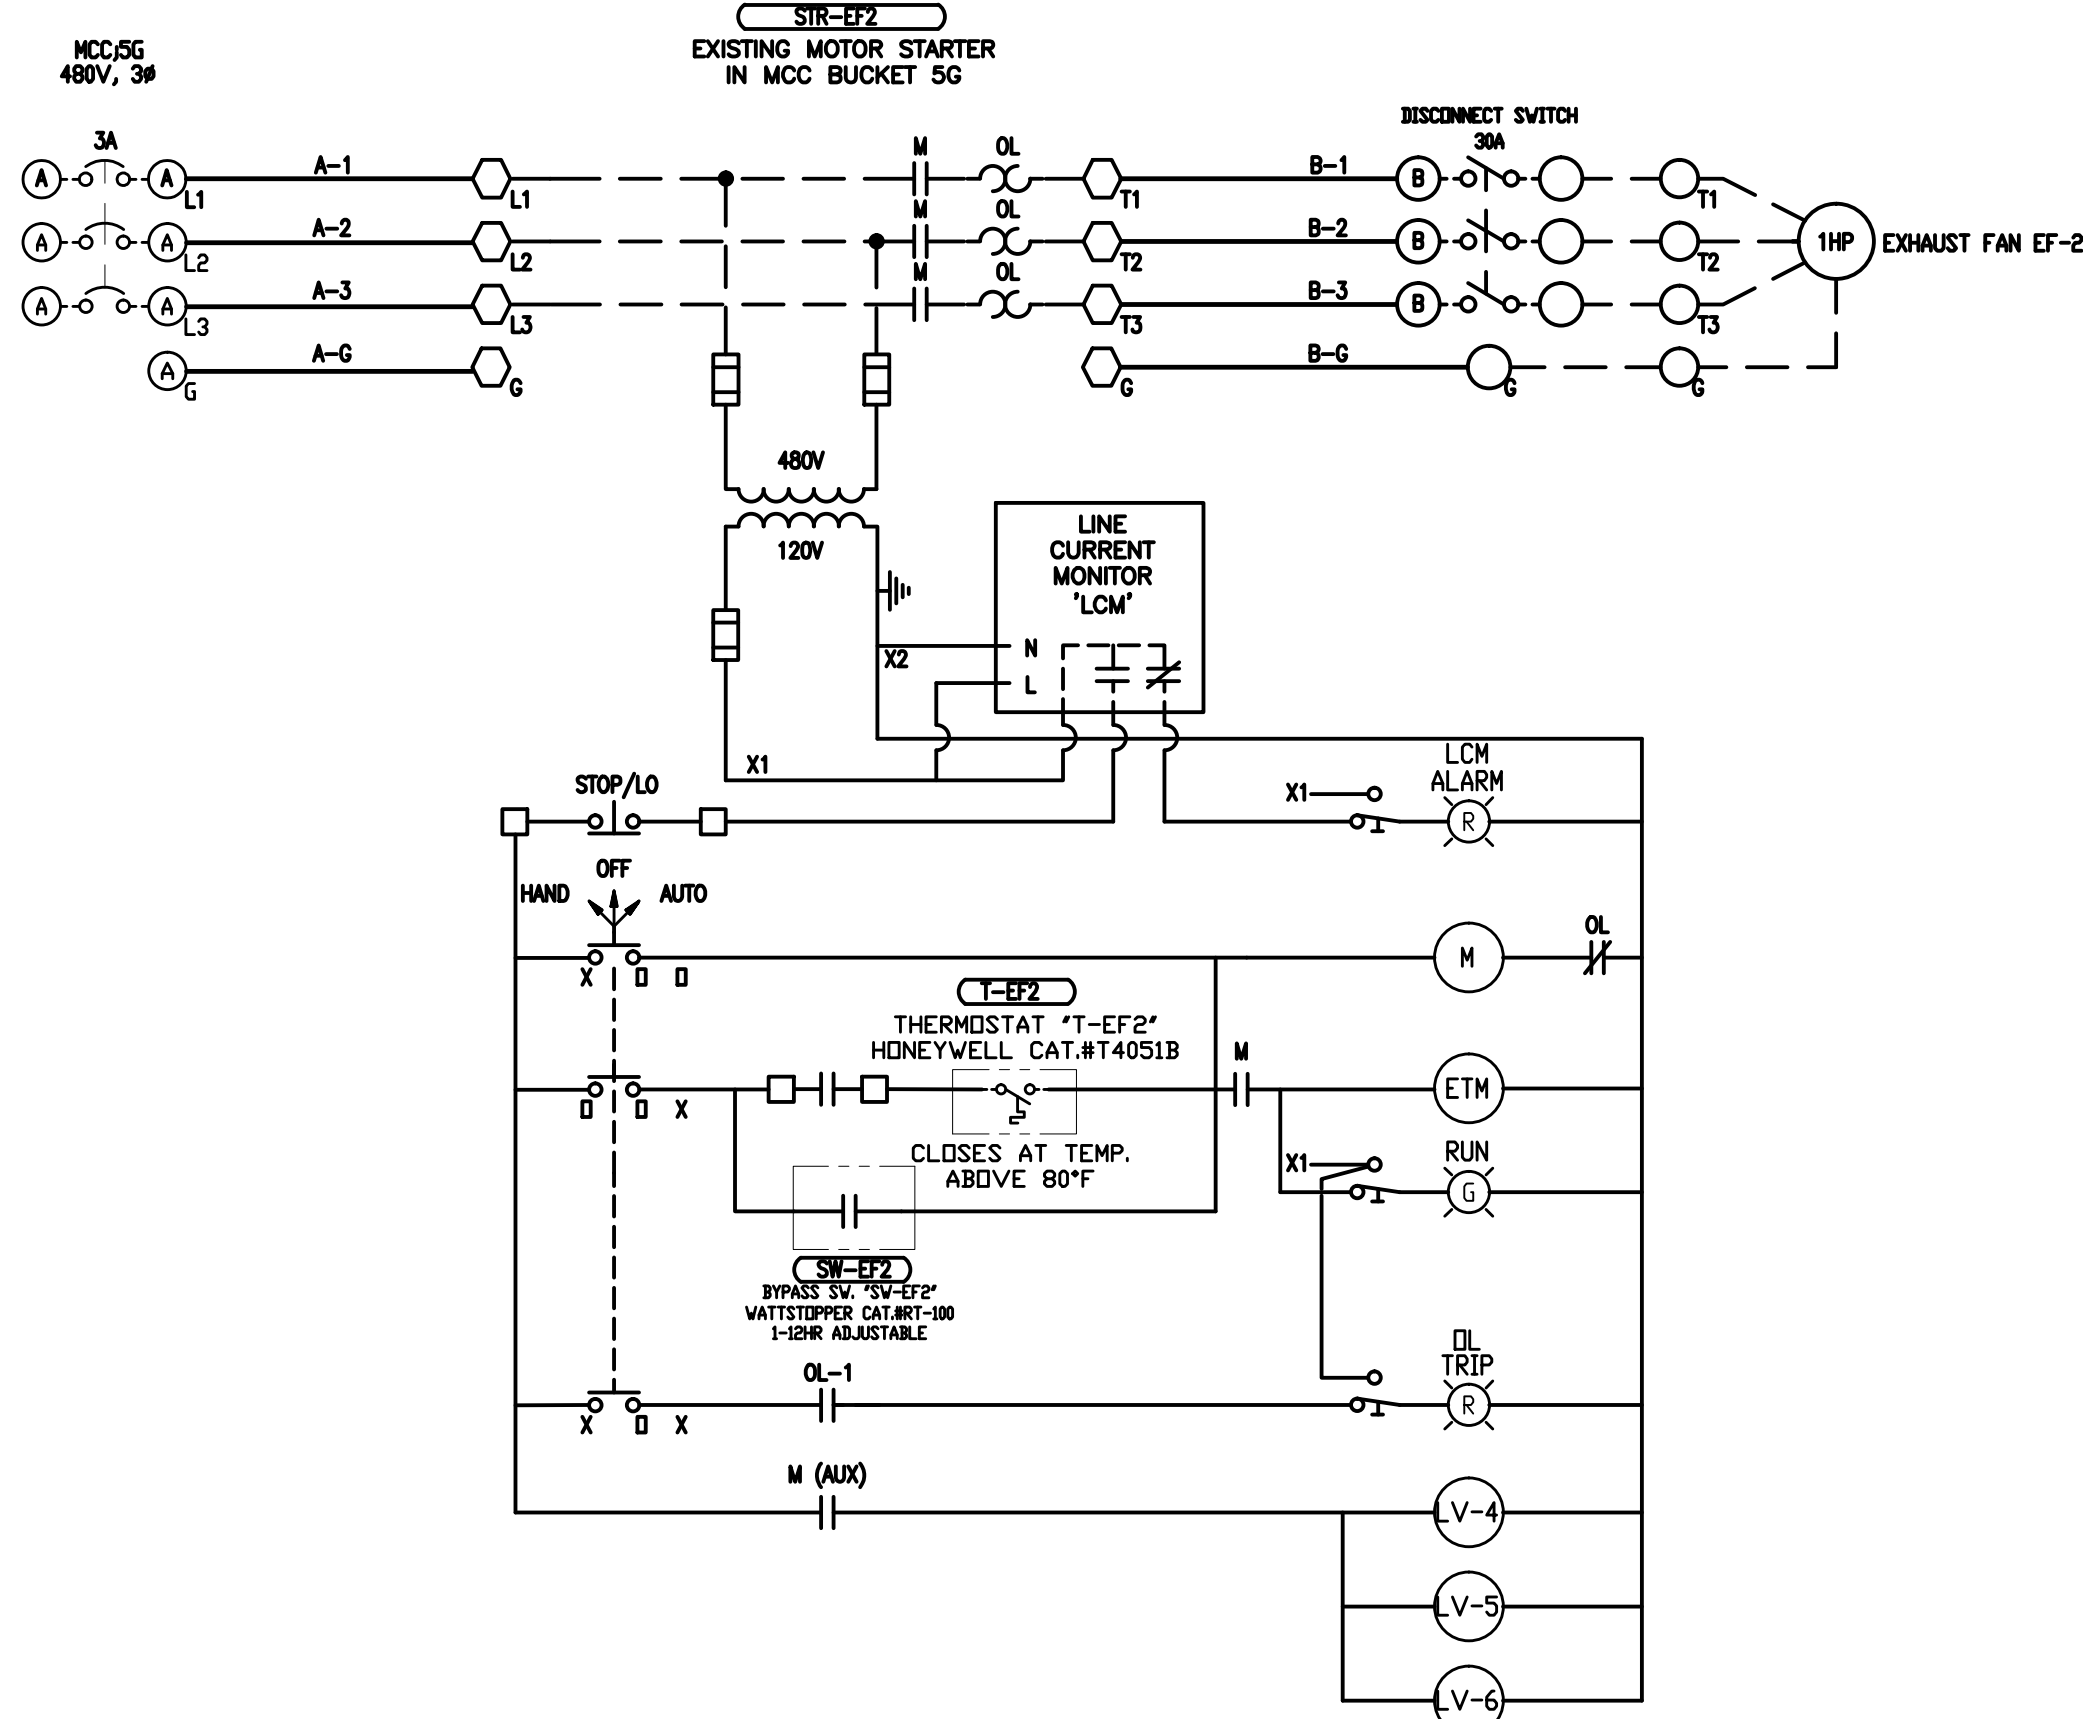

FLOOR PLAN AND SECTION INFORMATION DERIVED FROM: CITY OF NEWARK, WATER TREATMENT FACILITIES PLANT, CONTRACT W-90-11 PREPARED BY TATMAN & LEE ASSOCIATES, INC. DATED 10/1/1990

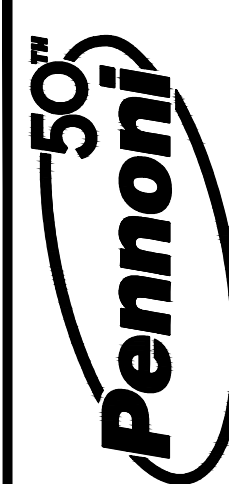

PENNONI ASSOCIATES INC.
Christiana Executive Campus
121 Continental Drive, Suite 207
Newark, DE 19713-4310
T 302.655.4451 F 302.654.2885

ALL DIMENSIONS MUST BE VERIFIED BY CONTRACTOR AND OWNER MUST BE NOTIFIED OF ANY DISCREPANCIES BEFORE PROCEEDING WITH WORK



CURTIS WATER TREATMENT PLANT
IMPROVEMENTS
NEWARK, DELAWARE
NEW WORK PANEL SCHEDULES

CITY OF NEWARK DEPT. OF PUBLIC WORKS AND WATER RESOURCES
220 SOUTH MAIN STREET
NEWARK, DELAWARE 19711

NO.	DATE	REVISIONS	BY

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PROJECT: CNEW1612
DATE: APRIL 2017
DRAWING SCALE: AS SHOWN
DRAWN BY: DAP
APPROVED BY: DVH

E1006
SHEET 35 OF 54




\\projects\new\new1612\cmts\wfp\improvements\DESIGN\ELC\NEW WORK.dwg PLOTTED: 4/22/2017 12:19 PM BY: Brian Miller PROJECT STATUS: CONSTRUCTION PLANS



GENERAL ELECTRICAL NEW WORK NOTES:


1. E.C. SHALL REUSE EXISTING CONDUIT WHERE POSSIBLE TO ROUTE NEW SIGNAL/CONTROL WIRING.
2. E.C. SHALL PULL POWER & SIGNAL/CONTROL CABLES FROM EACH DEVICE BACK TO SIEMENS PANEL IN MCC ROOM. E.C. SHALL PULL 15' FEET OF EXTRA CABLE TO ALLOW ACS TO ROUTE INTO SIEMENS PANEL.
3. E.C. SHALL INSTALL AND LABEL EACH CABLE AT DEVICE TERMINATION WITH CONTROL CABLE TAG #.

ELECTRICAL INSTRUMENT AND CONTROLS LIST																		
Tag	Name	Signal	From	Termination	DI	AI	DO	AO	#12	#14	G	TSP	E	Area	CN	Conduit	Size	
Effluent Monitoring																		
AIT 101	Finished Water Chlorine Transmitter	4-20mA	AIT 101	FCP		1						1				C-101	3/4	
AIT 102	Finished Water Fluoride Transmitter	4-20mA	AIT 102	FCP		1						1				C-101	3/4	
AIT 103	Finished Water Flow Meter Transmitter	120 VAC	AIT 103	FCP	1	1										C-102	3/4	
Hypo Feed																		
MC 101	Hypo Feeder #1 auto/run/ tube failure	120 VAC	MC 101	FCP	2		1			6						C-103	1	
MC 102	Hypo Feeder #2 auto/run/ tube failure	120 VAC	MC 102	FCP	2		1			6						C-103	1	
SC 101	Hypo Feeder #1 Speed Control	4-20 mA	MP 7 101	FCP				1				1				C-104	3/4	
SC 102	Hypo Feeder #2 Speed Control	4-20 mA	MP 8 102	FCP				1				1				C-104	3/4	
Caustic Feed																		
MC 103	Caustic Feeder #1 auto/run/ tube failure	120 VAC	MC 103	FCP	2		1			6						C-105	1	
MC 104	Caustic Feeder #2 auto/run/ tube failure	120 VAC	MC 104	FCP	2		1			6						C-105	1	
SC 103	Caustic Feeder #1 Speed Control	4-20 mA	MP 12 103	FCP				1				1				C-106	3/4	
SC 104	Caustic Feeder #2 Speed Control	4-20 mA	MP 13 104	FCP				1				1				C-106	3/4	
Hypo Tank																		
LT 101	Hypo Tank Level Transmitter	4-20 mA	LT 101	FCP		1						1				C-107	3/4	
LT 102	Hypo Tank Level Transmitter	4-20 mA	LT 102	FCP		1						1				C-108	3/4	
LD 101	Hypo Tank Leak Detector	4-20 mA	LD 101	FCP		1						1				C-108A	3/4	
LD 102	Hypo Tank Leak Detector	4-20 mA	LD 102	FCP		1						1				C-108A	3/4	
LSH 101	Hypo Level Switch High	120 VAC	LSH 101	FCP	1					2						C-109	3/4	
LSH 102	Hypo Level Switch High	120 VAC	LSH 102	FCP	1					2						C-110	3/4	
LI 101	Hypo Tank Level Indicator	4-20 mA	FCP	Hypo FP								1				C-111	3/4	
LI 102	Hypo Tank Level Indicator	4-20 mA	FCP	Hypo FP								1				C-111	3/4	
AY 101	Local Alarm Relay	120 VAC					1											
AY 102	Local Alarm Relay	120 VAC					1											
LAH 101	Local Alarm Indicator	120 VAC	FCP	Hypo FP						2						C-112	3/4	
LAH 102	Local Alarm Indicator	120 VAC	FCP	Hypo FP						2						C-112	3/4	
LA 101	Local Rotating Beacon	120 VAC	LA 101	Hypo FP						2	1					C-113	3/4	
Caustic Tank																		
LT 103	Caustic Tank Level Transmitter	4-20 mA	LT 103	FCP		1						1				C-114	3/4	
LT 104	Caustic Tank Level Transmitter	4-20 mA	LT 104	FCP		1						1				C-115	3/4	
LD 103	Caustic Tank Leak Detector	4-20 mA	LD 103	FCP		1						1				C-115A	3/4	
LD 104	Caustic Tank Leak Detector	4-20 mA	LD 104	FCP		1						1				C-115A	3/4	
LSH 103	Caustic Level Switch High	120 VAC	LSH 103	FCP	1					2						C-116	3/4	
LSH 104	Caustic Level Switch High	120 VAC	LSH 104	FCP	1					2						C-117	3/4	
LI 103	Caustic Tank Level Indicator	4-20 mA	FCP	Caustic FP								1				C-118	3/4	
LI 104	Caustic Tank Level Indicator	4-20 mA	FCP	Caustic FP								1				C-118	3/4	
AY 103	Local Alarm Relay	120 VAC					1											
AY 104	Local Alarm Relay	120 VAC					1											
LAH 103	Local Alarm Indicator	120 VAC	FCP	Caustic FP						2						C-119	3/4	
LAH 104	Local Alarm Indicator	120 VAC	FCP	Caustic FP						2						C-119	3/4	
LA 103	Local Rotating Beacon	120 VAC	LA 103	Caustic FP						2	1					C-120	3/4	
Polymer Feeders																		
MC 105	Polymer Feeder #1 auto/run/ failure	120 VAC	PSCP	FCP	2		1			6						C-121	1	
FAL 105	Dilution Water Flow Low	120 VAC	PSCP	FCP	1					2						C-121	1	
WIT 105	Polymer Drum Scale Indicator	4-20 mA	WIT	FCP		1						1				C-122		
LAH 105	Polymer Day Tank Level Alarm -High	120 VAC	PSCP	FCP	1					2						C-121	1	
LAL 105	Polymer Day Tank Level Alarm -Low	120 VAC	PSCP	FCP	1					2						C-121	1	
Polymer Feed Pumps																		
MC 106	Polymer Feeder #1 auto/run/ failure	120 VAC	MC 106	FCP	2		1			6						C-123	1.5	
SC 106	Polymer Feeder #1 Speed Control	4-20 mA	MP 46 106	FCP				1				1				C-124	1	
MC 107	Polymer Feeder #2 auto/run/ failure	120 VAC	MC 107	FCP	2		1			6						C-123	1.5	
SC 107	Polymer Feeder #2 Speed Control	4-20 mA	MP 48 107	FCP				1				1				C-124	1	
MC 108	Polymer Feeder #3 auto/run/ failure	120 VAC	MC 108	FCP	2		1			6						C-123	1.5	
SC 108	Polymer Feeder #3 Speed Control	4-20 mA	MP 50 108	FCP				1				1				C-124	1	
MC 109	Polymer Feeder #4 auto/run/ failure	120 VAC	MC 109	FCP	2		1			6						C-123	1.5	
SC 109	Polymer Feeder #4 Speed Control	4-20 mA	MP 52 109	FCP				1				1				C-124	1	
MC 1010	Polymer Feeder #5 auto/run/ failure	120 VAC	MC 1010	FCP	2		1			6						C-123	1.5	
SC 1010	Polymer Feeder #5 Speed Control	4-20 mA	MP 54 1010	FCP				1				1				C-124	1	
Fluoride Feed																		
MC 111	Fluoride Feeder auto /run / failure	120 VAC	FI CP	FCP	2		1			6						C-125	1	
SC 111	Fluoride Feeder Speed Control	4-20 mA	FI CP	FCP				1				1				C-126	3/4	
LSH 16	FI Containment Level Switch High	120 VAC	FI CP	FCP	1					2						C-125	1	
LSH 17	NaF Level Switch High	120 VAC	FI CP	FCP	1					2						C-125	1	
Raw Water Monitoring																		
AIT 104	Raw Water Turbidity	4-20mA	AIT 104	FCP		1						1		C-126	3/4	C-127	3/4	
AIT 105	Raw Water pH	4-20mA	AIT 105	FCP		1						1		C-126	3/4	C-127	3/4	

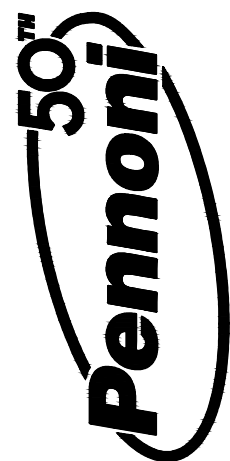

PENNONI ASSOCIATES INC.
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CURTIS WATER TREATMENT PLANT
IMPROVEMENTS

ELECTRICAL INSTRUMENT & CONTROL LIST

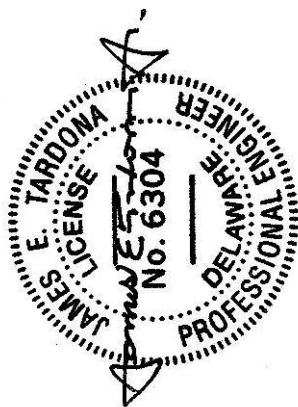215 PAPER MILL ROAD
NEWARK, DELAWARE

CITY OF NEWARK DEPT. OF PUBLIC WORKS AND WATER RESOURCES
220 SOUTH MAIN STREET
NEWARK, DELAWARE 19711


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PROJECT CNEW1612
DATE APRIL 2017
DRAWING SCALE AS SHOWN
DRAWN BY DAP
APPROVED BY DVH


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SHEET 36 OF 54

V:\PROJECTS\NEWARK\NEWARK1912\Info MTP Improvements\DESIGN\Mechanical\Demolition\Background.dwg
PLOTTER: 4/22/2017 3:31 PM BY: Brian Miller
PLOTSTYLE: NEW.dwt
PROJECT STATUS: CONSTRUCTION PLANS



1 HVAC DEMOLITION PLAN - GROUND FLOOR
SCALE: 3/16" = 1'-0"

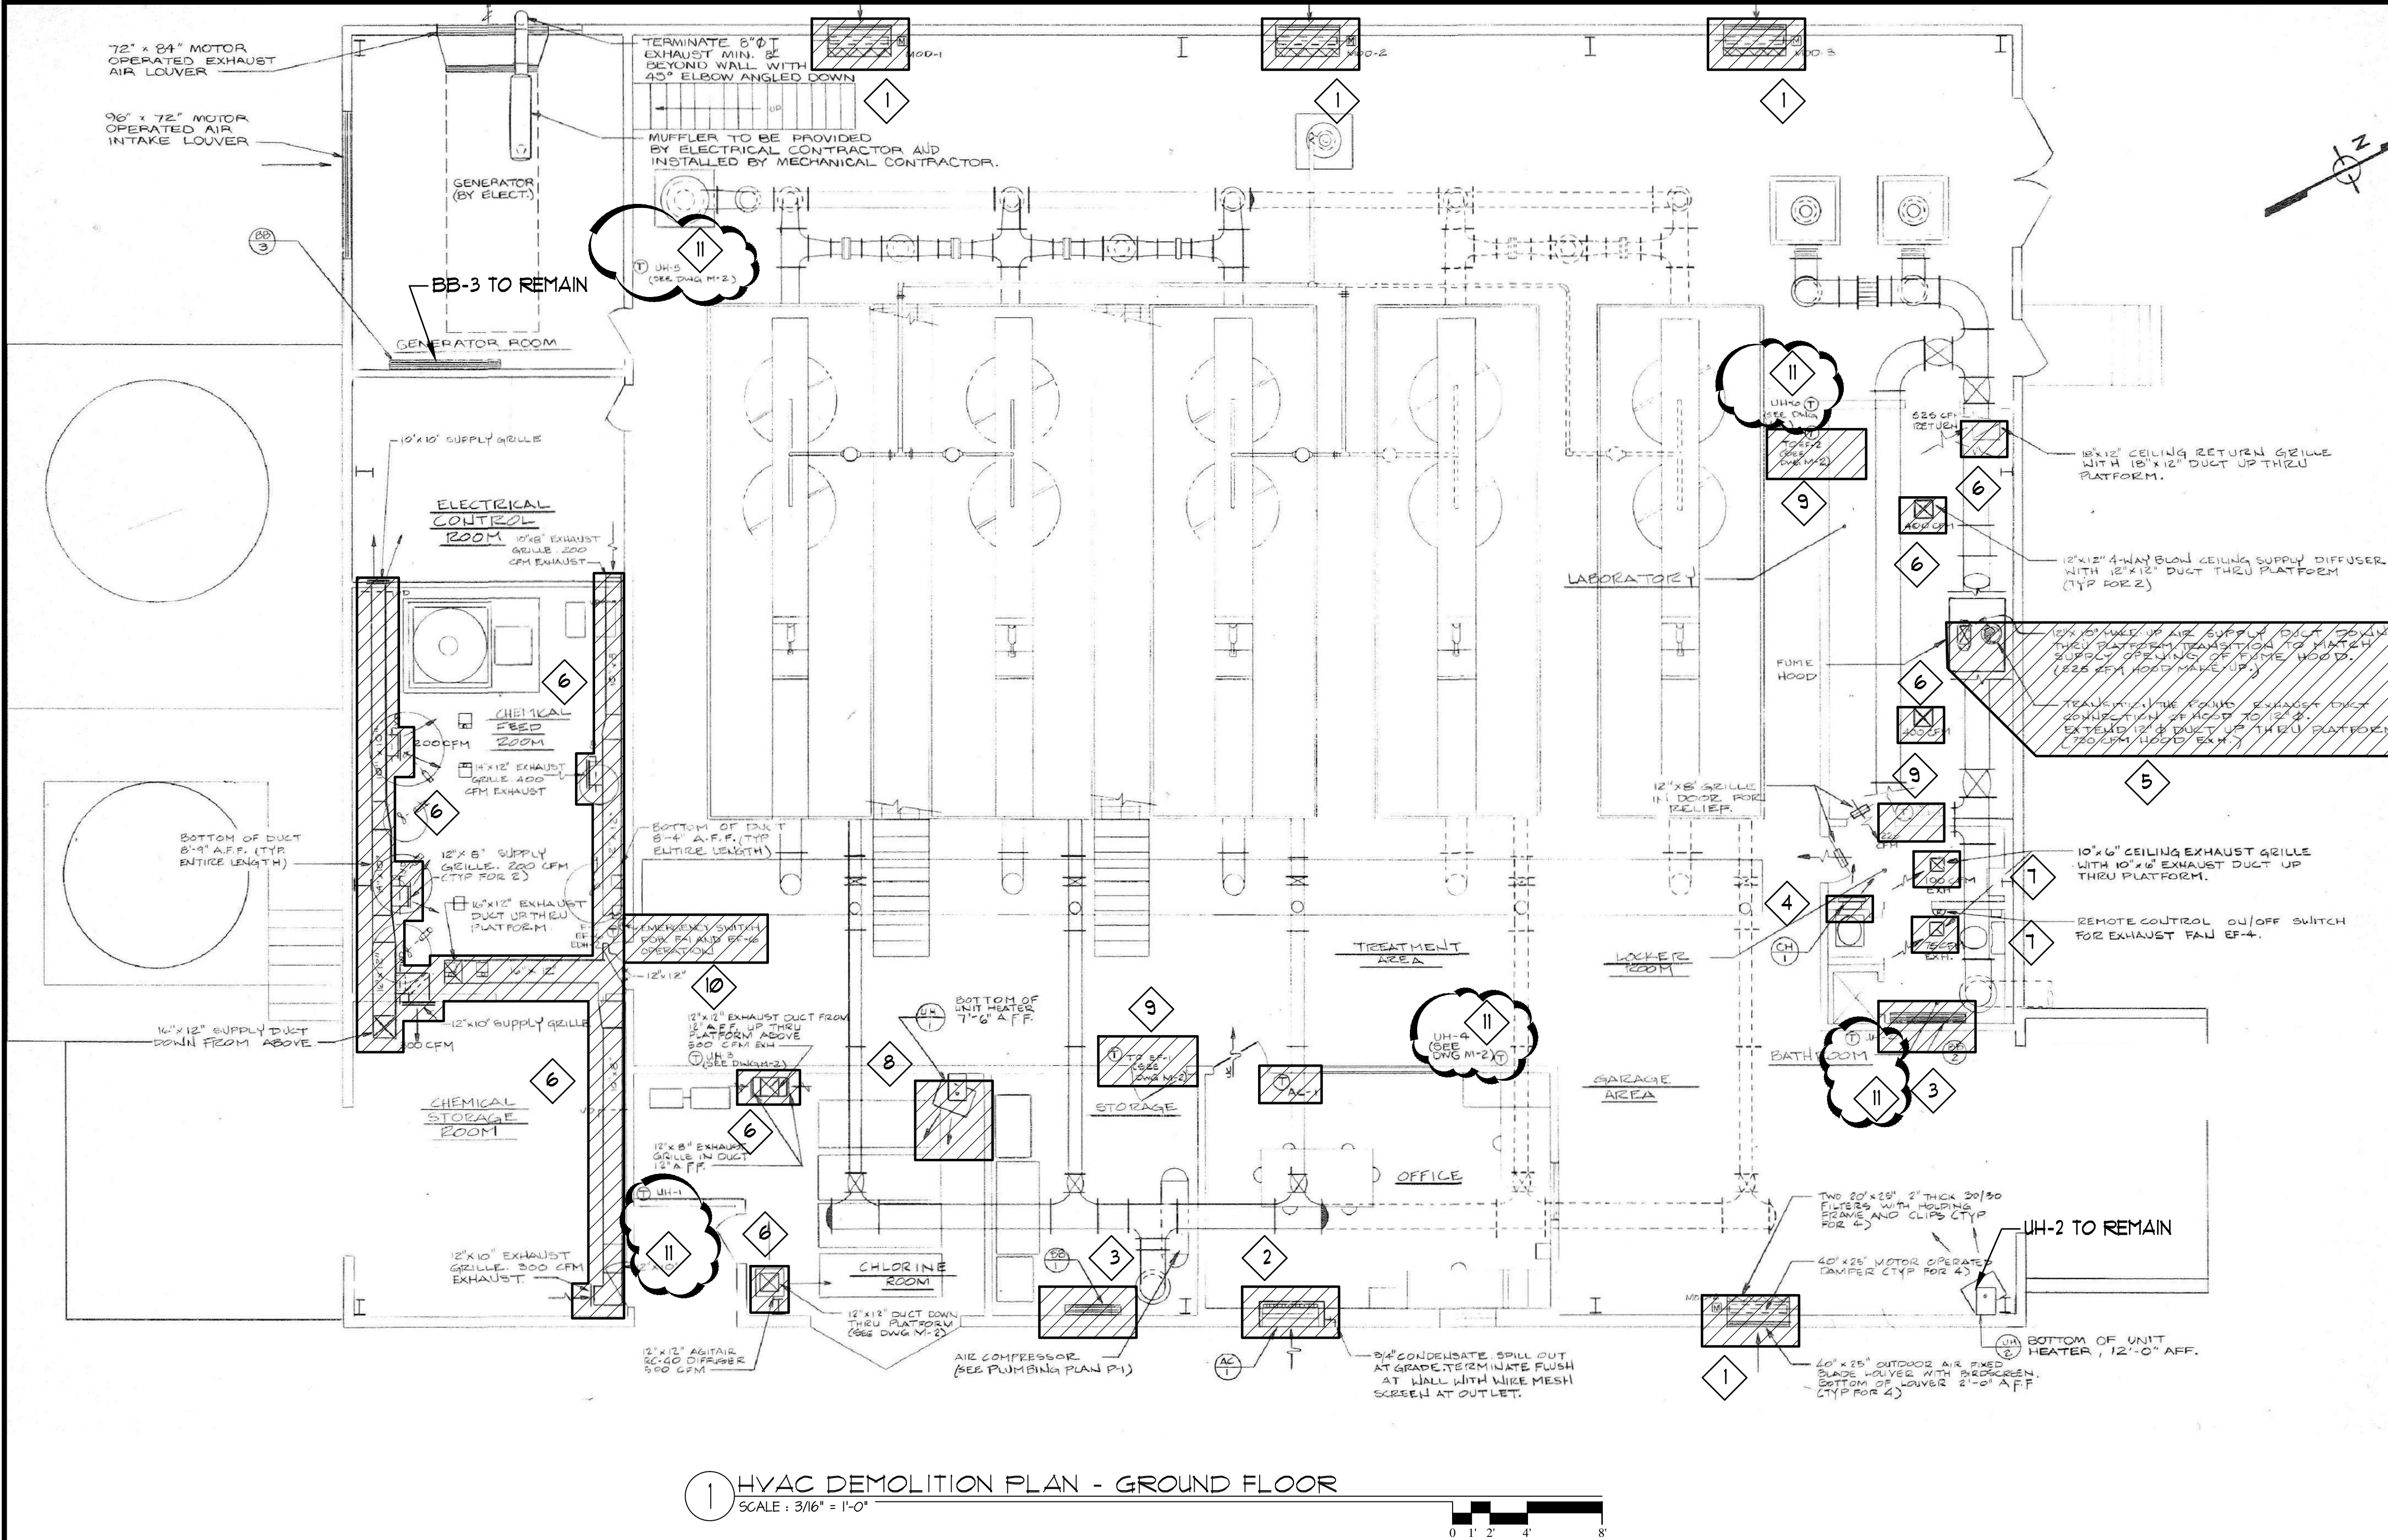

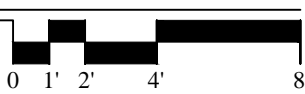SPECIFIC DEMOLITION NOTES

- 1 REMOVE EXISTING THROUGH-WALL LOUVERS INCLUDING MOTOR-OPERATED DAMPERS
- 2 REMOVE EXISTING THROUGH-WALL A/C UNIT AC-1 INCLUDING T-STAT AT OFFICE DOOR
- 3 REMOVE EXISTING ELECTRIC BASEBOARD HEATER
- 4 REMOVE EXISTING CABINET HEATER CH-1
- 5 REMOVE EXISTING FUME HOOD EXHAUST AND MAKE-UP AIR SUPPLY DUCTWORK
- 6 REMOVE EXISTING DUCTWORK INCLUDING TERMINAL UNIT (GRILLE, REGISTER, DIFFUSER)
- 7 REMOVE EXISTING EXHAUST DUCTWORK AND EF-4 ON PLATFORM INCLUDING REMOTE CONTROL
- 8 REMOVE EXISTING ELECTRIC UNIT HEATER
- 9 REMOVE EXISTING T-STAT FOR EXHAUST FAN, AH, CU, ETC.
- 10 REMOVE EXISTING CONTROLS FOR F-1, EF-6 AND EDH-2
- 11 RELOCATE EXISTING T-STAT FOR UNIT HEATER ABOVE - SEE DUG. M1001 (NEW WORK) FOR NEW T-STAT LOCATIONS
- 12 RELOCATE EXISTING T-STAT FOR UNIT HEATER UH-1 - SEE DUG. M1001 (NEW WORK) FOR NEW T-STAT LOCATIONS. RELOCATE UH-1 - SEE DUG. M1002 (NEW WORK) FOR NEW UH LOCATION

DEMOLITION LEGEND:

COMPLETELY DISMANTLE & REMOVE ALL DUCTWORK, FITTINGS, TERMINAL UNITS, ETC. WITHIN HATCHED CLOUDS.

GENERAL MECHANICAL DEMOLITION NOTES:
DUCTWORK AND COMPONENTS:

1. CONTRACTOR TO VERIFY ALL FIELD CONDITIONS, DUCT ROUTING, SIZES, SEPARATION POINTS, REMOVAL AND DISPOSAL METHODS PRIOR TO BEGINNING THE DEMOLITION WORK. COORDINATE DEMOLITION AND TIMING WITH CONSTRUCTION MANAGER AND OWNER PRIOR TO BEGINNING WORK.
2. GENERAL CONTRACTOR IS RESPONSIBLE TO REMOVE FROM BUILDING SITE DEBRIS, TRASH, AND OTHER DISCARDED MATERIALS AND/OR EQUIPMENT RESULTING FROM DEMOLITION OPERATIONS. TRANSPORT AND LEGALLY DISPOSE OFF SITE.
3. IF HAZARDOUS MATERIALS ARE ENCOUNTERED DURING DEMOLITION OPERATIONS, COMPLY WITH APPLICABLE REGULATIONS, LAWS, AND ORDINANCES CONCERNING REMOVAL, HANDLING, AND PROTECTION AGAINST EXPOSURE OR ENVIRONMENTAL POLLUTION.
4. COORDINATE ALL DEMOLITION WITH OWNER AND OTHER TRADES. CONFIRM THE EXTENT, TIMING, AND ITEMS TO BE SALVAGED WITH OWNER. CONTRACTOR SHALL SCHEDULE WORK TO LIMIT OVERALL OPERATIONAL DOWNTIME.
5. ALL REMAINING DUCTWORK SHALL BE CAPPED AND SEALED LEAK TIGHT USING THE SAME MATERIALS AS THE EXISTING DUCT SYSTEM.
6. DURING DEMOLITION ALL UNUSED HANGERS, STRAPS, ANCHORS AND SUPPORTS SHALL BE REMOVED.
7. IF CONTRACTOR DAMAGES OR REMOVES EXISTING DUCT INSULATION TO PROVIDE ACCESS TO REMOVE, MODIFY OR CONNECT TO EXISTING DUCTS, THE CONTRACTOR SHALL REPAIR AND/OR REPLACE THE DAMAGED OR REMOVED SECTION TO MATCH EXISTING.
8. ALL REMOVED EQUIPMENT (I.E. FANS, CONDENSING UNITS, COILS, ETC.) SHALL BE DISPOSED OF PROPERLY ACCORDING TO THE REQUIREMENTS OF THE AUTHORITY HAVING JURISDICTION.
9. NO UNUSED DUCTWORK SHALL BE CONSIDERED "ABANDONED IN PLACE" UNLESS DEFINED IN THE CONSTRUCTION DOCUMENTS. REMOVE AND DISPOSE OF ALL DUCTS SHOWN TO BE REMOVED ON DEMOLITION DRAWINGS.
10. ALL EXISTING UNUSED DUCT PENETRATIONS THROUGH WALLS, FLOORS, PLATFORMS OR ROOFS SHALL BE PATCHED TO MATCH EXISTING FINISHES.
11. COMPLETELY REMOVE EXISTING ROOF TOP EXHAUST FAN CURBS CONCORDING WITH REMOVAL OF ROOFING SYSTEM.
12. FIRE MAINS, SPRINKLER TAKEOFFS, SPRINKLER HEADS AND ALL PIPING OR COMPONENTS ASSOCIATED WITH FIRE PROTECTION SYSTEM ARE NOT PART OF THIS DEMOLITION CONTRACT AND ARE NOT TO BE DISTURBED UNDER ANY CIRCUMSTANCES.
13. CARE MUST BE TAKEN TO PROTECT EXISTING TREATMENT EQUIPMENT IN THE AREA WHICH WILL REMAIN IN SERVICE.

FLOOR PLAN AND SECTION INFORMATION DERIVED FROM: CITY OF NEWARK, WATER TREATMENT FACILITIES PLANT, CONTRACT W-90-1" PREPARED BY TATMAN & LEE ASSOCIATES, INC. DATED 10/1/1990

CURTIS WATER TREATMENT PLANT
IMPROVEMENTS
MECHANICAL DEMOLITION GROUND FLOOR
PLAN


NO.	DATE	BY	REVISIONS

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PROJECT	CNEW1612
DATE	APRIL 2017
DRAWING SCALE	3/16" = 1'-0"
DRAWN BY	HMM
APPROVED BY	SJV

DM1001
SHEET 37 OF 54

50' Pennoni
PENNONI ASSOCIATES INC.
Christiana Executive Campus
121 Continental Drive, Suite 207
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T 302.655.4451 F 302.654.2895

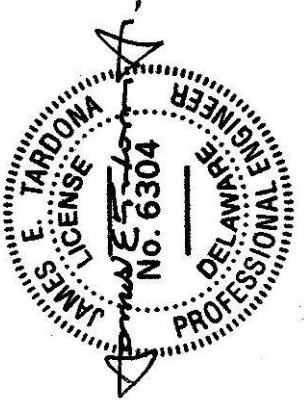

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RIDGE

2 ROOF DEMOLITION PLAN
SCALE: 3/16" = 1'-0"



REMOVE EXISTING THROUGH-ROOF EXHAUST FAN INCLUDING INLET DUCT & T-STAT BELOW. COMPLETELY REMOVE ALL ROOF CURBS WITH ROOF SYSTEM.


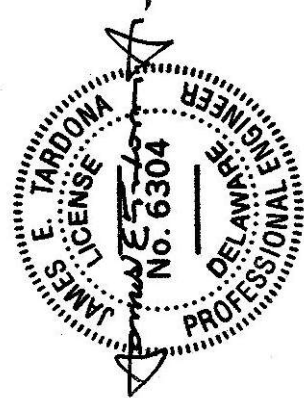
FLOOR PLAN AND SECTION INFORMATION DERIVED FROM "CITY OF NEWARK, WATER TREATMENT FACILITIES PLANT, CONTRACT W-90-1" PREPARED BY TATMAN & LEE ASSOCIATES, INC. DATED 10/1/1990

**CURTIS WATER TREATMENT PLANT
IMPROVEMENTS**
215 PAPER MILL ROAD
NEWARK, DELAWARE

MECHANICAL DEMOLITION ROOF PLAN

CITY OF NEWARK DEPT. OF PUBLIC WORKS AND WATER RESOURCES
220 SOUTH MAIN STREET
NEWARK, DELAWARE 19711

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PROJECT CNEW1612

DATE APRIL 2017

DRAWING SCALE 3/16" = 1'-0"


DRAWN BY BWM

APPROVED BY SJV

DM1003

SHEET 39 OF 54

V:\PROJECTS\NEWARK\NEWARK12\DWG\WTP Improvements\DESIGN\Mechanical\Demolition\Background.dwg
PLOTTER: 4/22/2017 3:31 PM BY: Brian Miller
PROJECT STATUS: CONSTRUCTION PLANS
PLOT STYLE: NEW.dwg

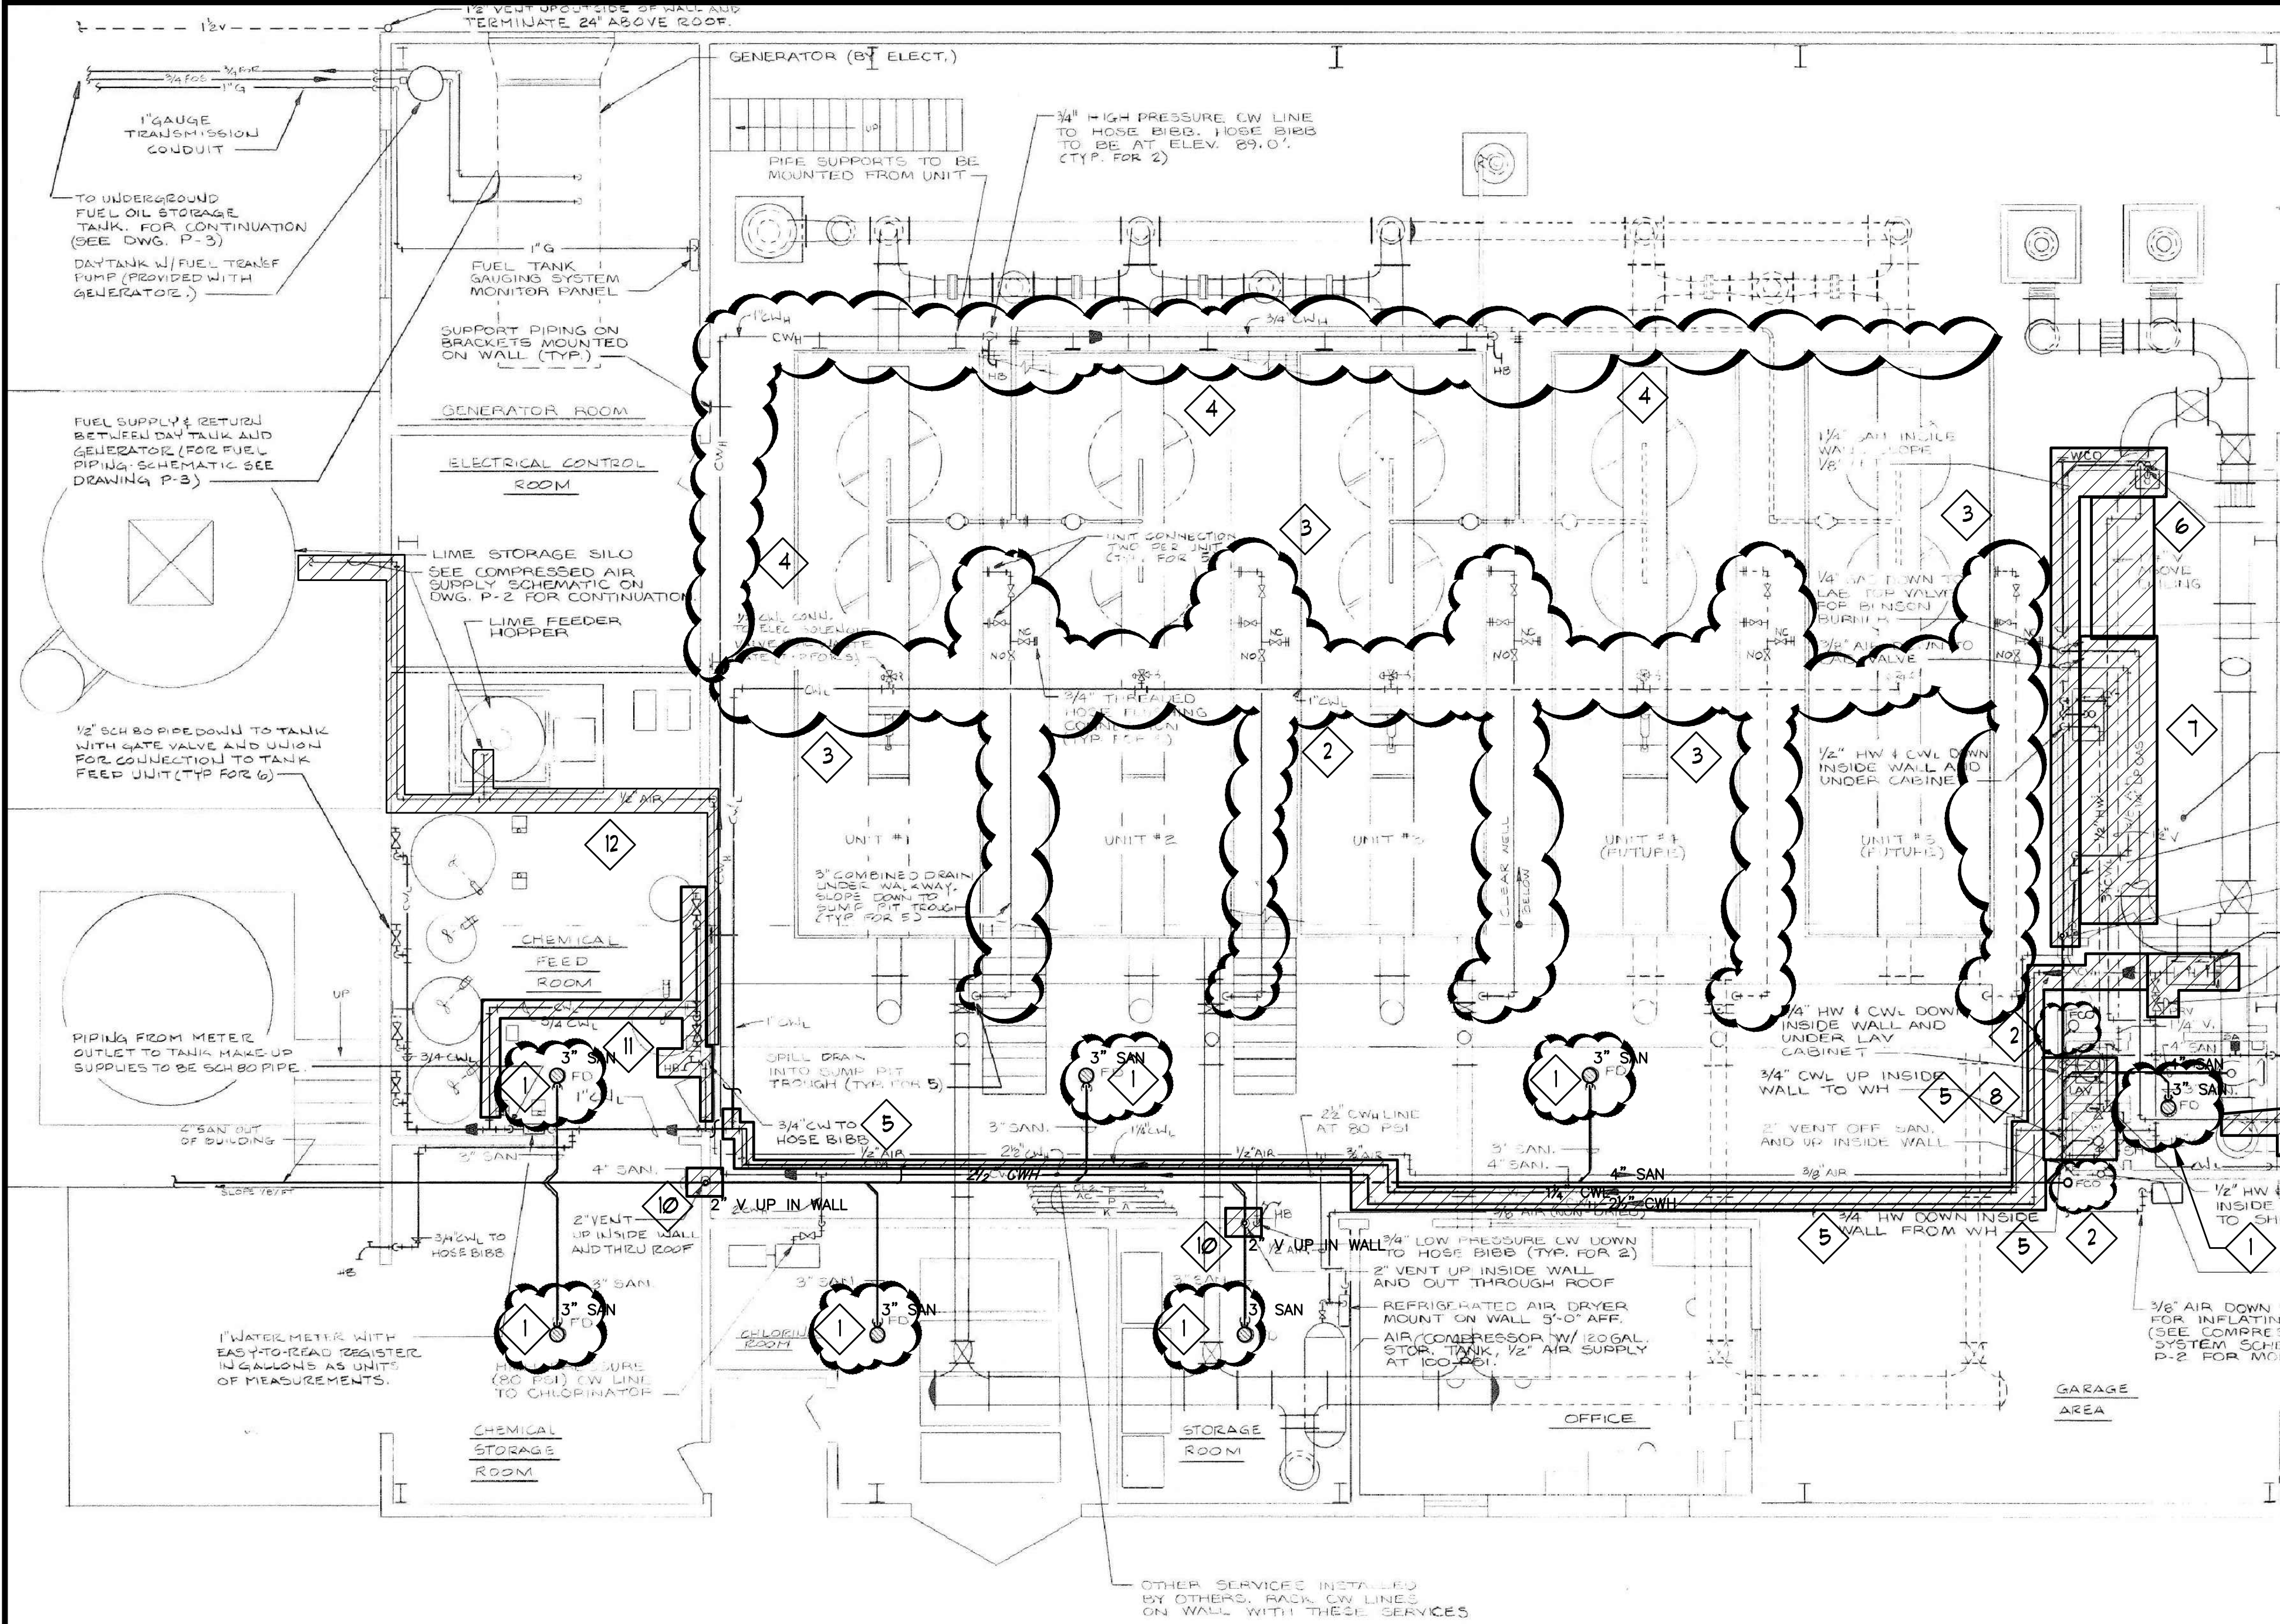

1 PIPING DEMOLITION PLAN - GROUND FLOOR
SCALE: 3/16" = 1'-0"




FOR GENERAL DEMOLITION NOTES SEE DRAWING DM1001

IN ADDITION TO GENERAL DEMOLITION NOTES ON DRAWING DM1001, CARE MUST BE TAKEN TO PROTECT EXISTING TREATMENT EQUIPMENT IN THE AREA WHICH WILL REMAIN IN SERVICE.

SPECIFIC DEMOLITION NOTES

- 1 EXISTING FLOOR DRAIN TO REMAIN IN SERVICE
- 2 TAKE CARE TO INSURE THAT EXISTING FLOOR CLEAN-OUTS WHICH ARE TO REMAIN IN SERVICE ARE NOT DAMAGED OR DISTURBED
- 3 EXISTING SMALL BORE WATER PIPING TO/FROM UNITS 1 THRU 5 TO REMAIN
- 4 EXISTING SMALL BORE (2-1/2" & BELOW) CUL (80 PSI) & CUL (35 PSI) TO REMAIN
- 5 EXISTING BACKFLOW PREVENTER AND CUL REGULATOR TO BE REPLACED TO TIE-IN POINT SHOWN. CUL AND CUL PIPING OUT TO BUILDING TO BE REPLACED AS SHOWN AND BE RE-CONNECTED. SUPPORT ALL PIPING WHERE REQUIRED DUE TO STRUCTURAL MODIFICATIONS.
- 6 REMOVE EXISTING EYE WASH STATION FROM WALL INCLUDING CUL FEED & 1-1/4" WASTE IN WALL. REMOVE VENT LINE
- 7 REMOVE EXISTING SINK INCLUDING SUPPLY AND WASTE PIPING AND LAB PIPING AT BENCH
- 8 REMOVE EXISTING LAV & SHOWER PIPING AND WASTE
- 9 REMOVE EXISTING PROPANE TANK AND PIPING TO LAB BENCH
- 10 REMOVE EXISTING 2" VENT UP IN WALL & CAP AT FLOOR
- 11 REMOVE PORTIONS OF EXISTING CUL SYSTEM AS SHOWN & CAP INCLUDING HOSE BIBB
- 12 REMOVE PORTIONS OF EXISTING COMPRESSED AIR SYSTEM AS SHOWN & CAP AT HEADER

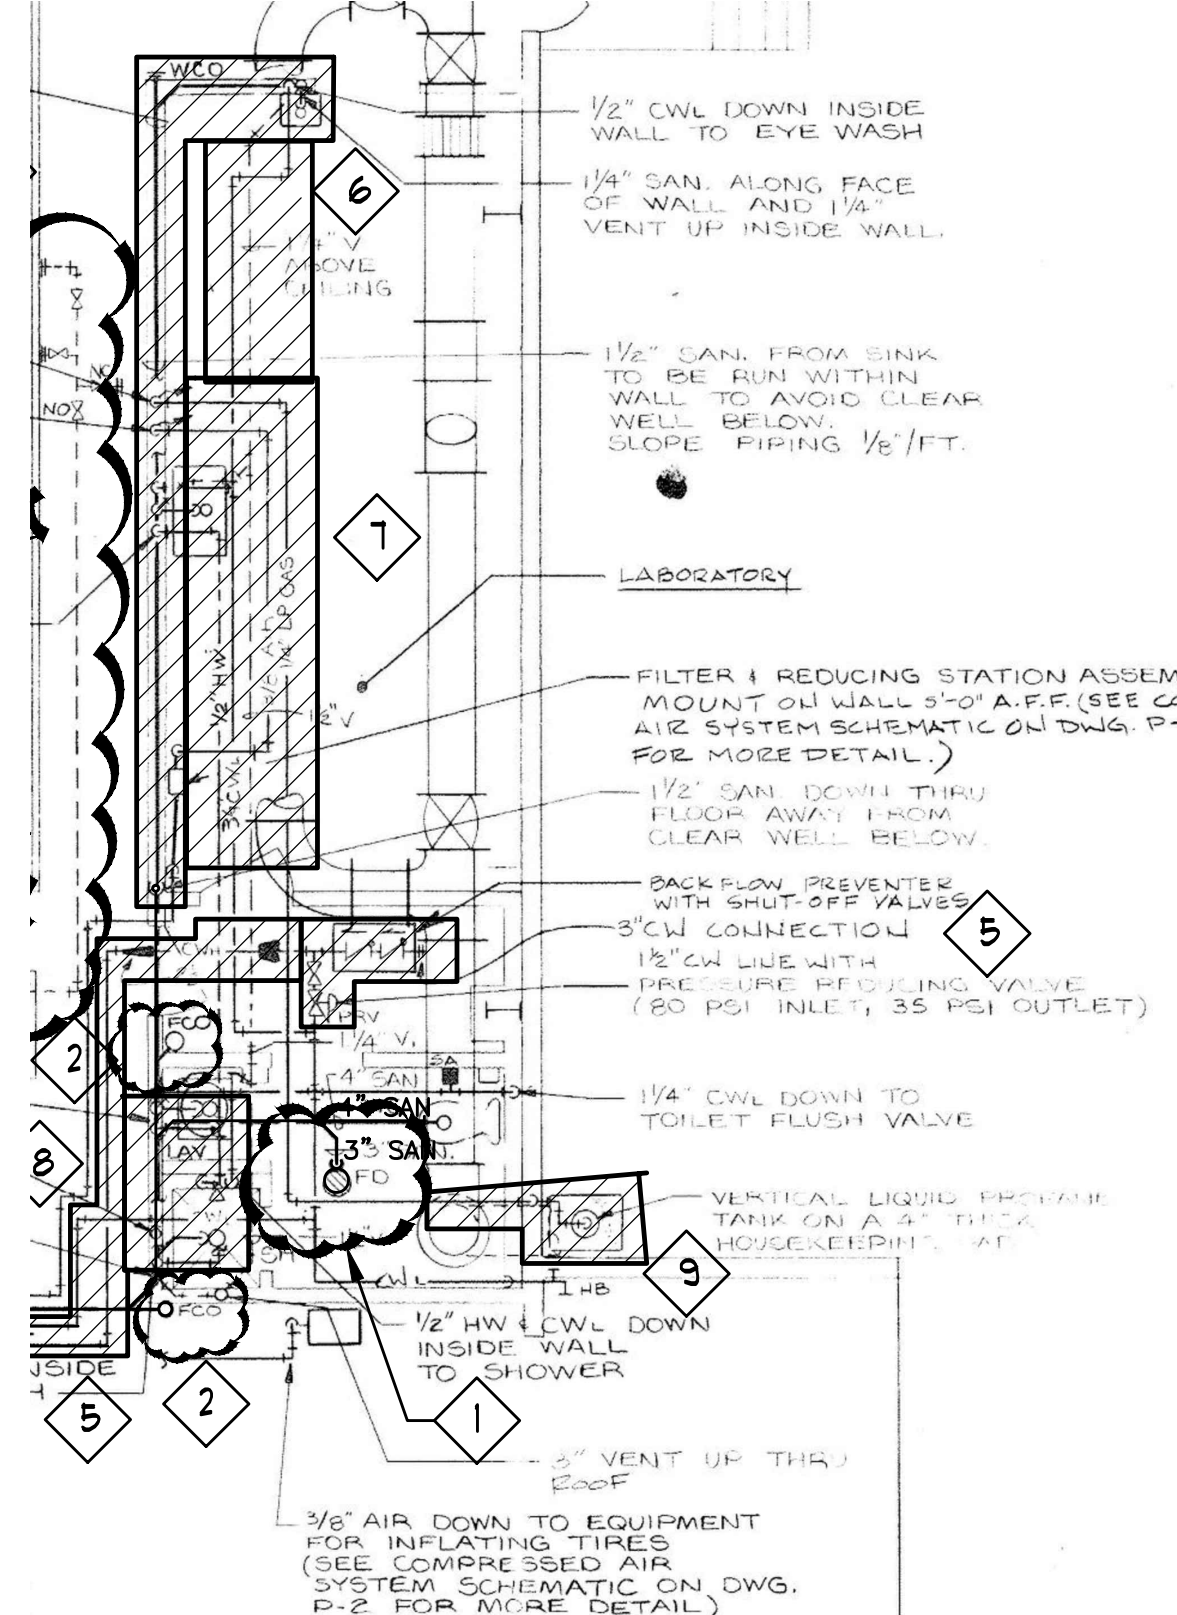


2 PIPING DEMOLITION PLAN - LABORATORY
SCALE: 3/16" = 1'-0"

CURTIS WATER TREATMENT PLANT
IMPROVEMENTS

PLUMBING DEMOLITION GROUND FLOOR PLAN

215 PAPER MILL ROAD
NEWARK, DELAWARE
CITY OF NEWARK DEPT. OF PUBLIC WORKS AND WATER RESOURCES
220 SOUTH MAIN STREET
NEWARK, DELAWARE 19711

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NO.	DATE	REVISIONS	BY


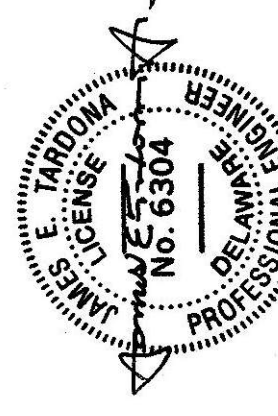
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PROJECT	CNEW1612
DATE	APRIL 2017
DRAWING SCALE	3/16" = 1'-0"
DRAWN BY	HMM
APPROVED BY	SJV

DP1001
SHEET 40 OF 54

FLOOR PLAN AND SECTION INFORMATION DERIVED FROM: CITY OF NEWARK, WATER TREATMENT FACILITIES PLANT, CONTRACT W-90-11 PREPARED BY TATMAN & LEE ASSOCIATES, INC. DATED 10/1/1990

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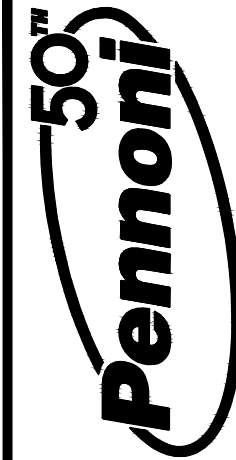
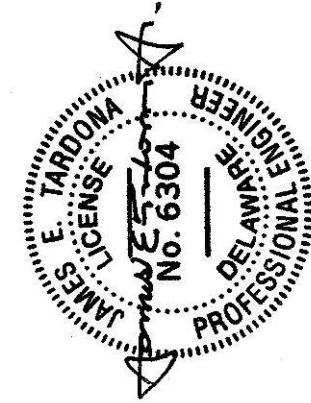
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PROJECT CNEW1612
DATE APRIL 2017
DRAWING SCALE 3/16" = 1'-0"
DRAWN BY HMM
APPROVED BY SJV

M1001
SHEET 41 OF 54

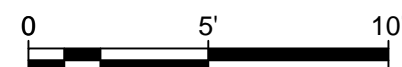
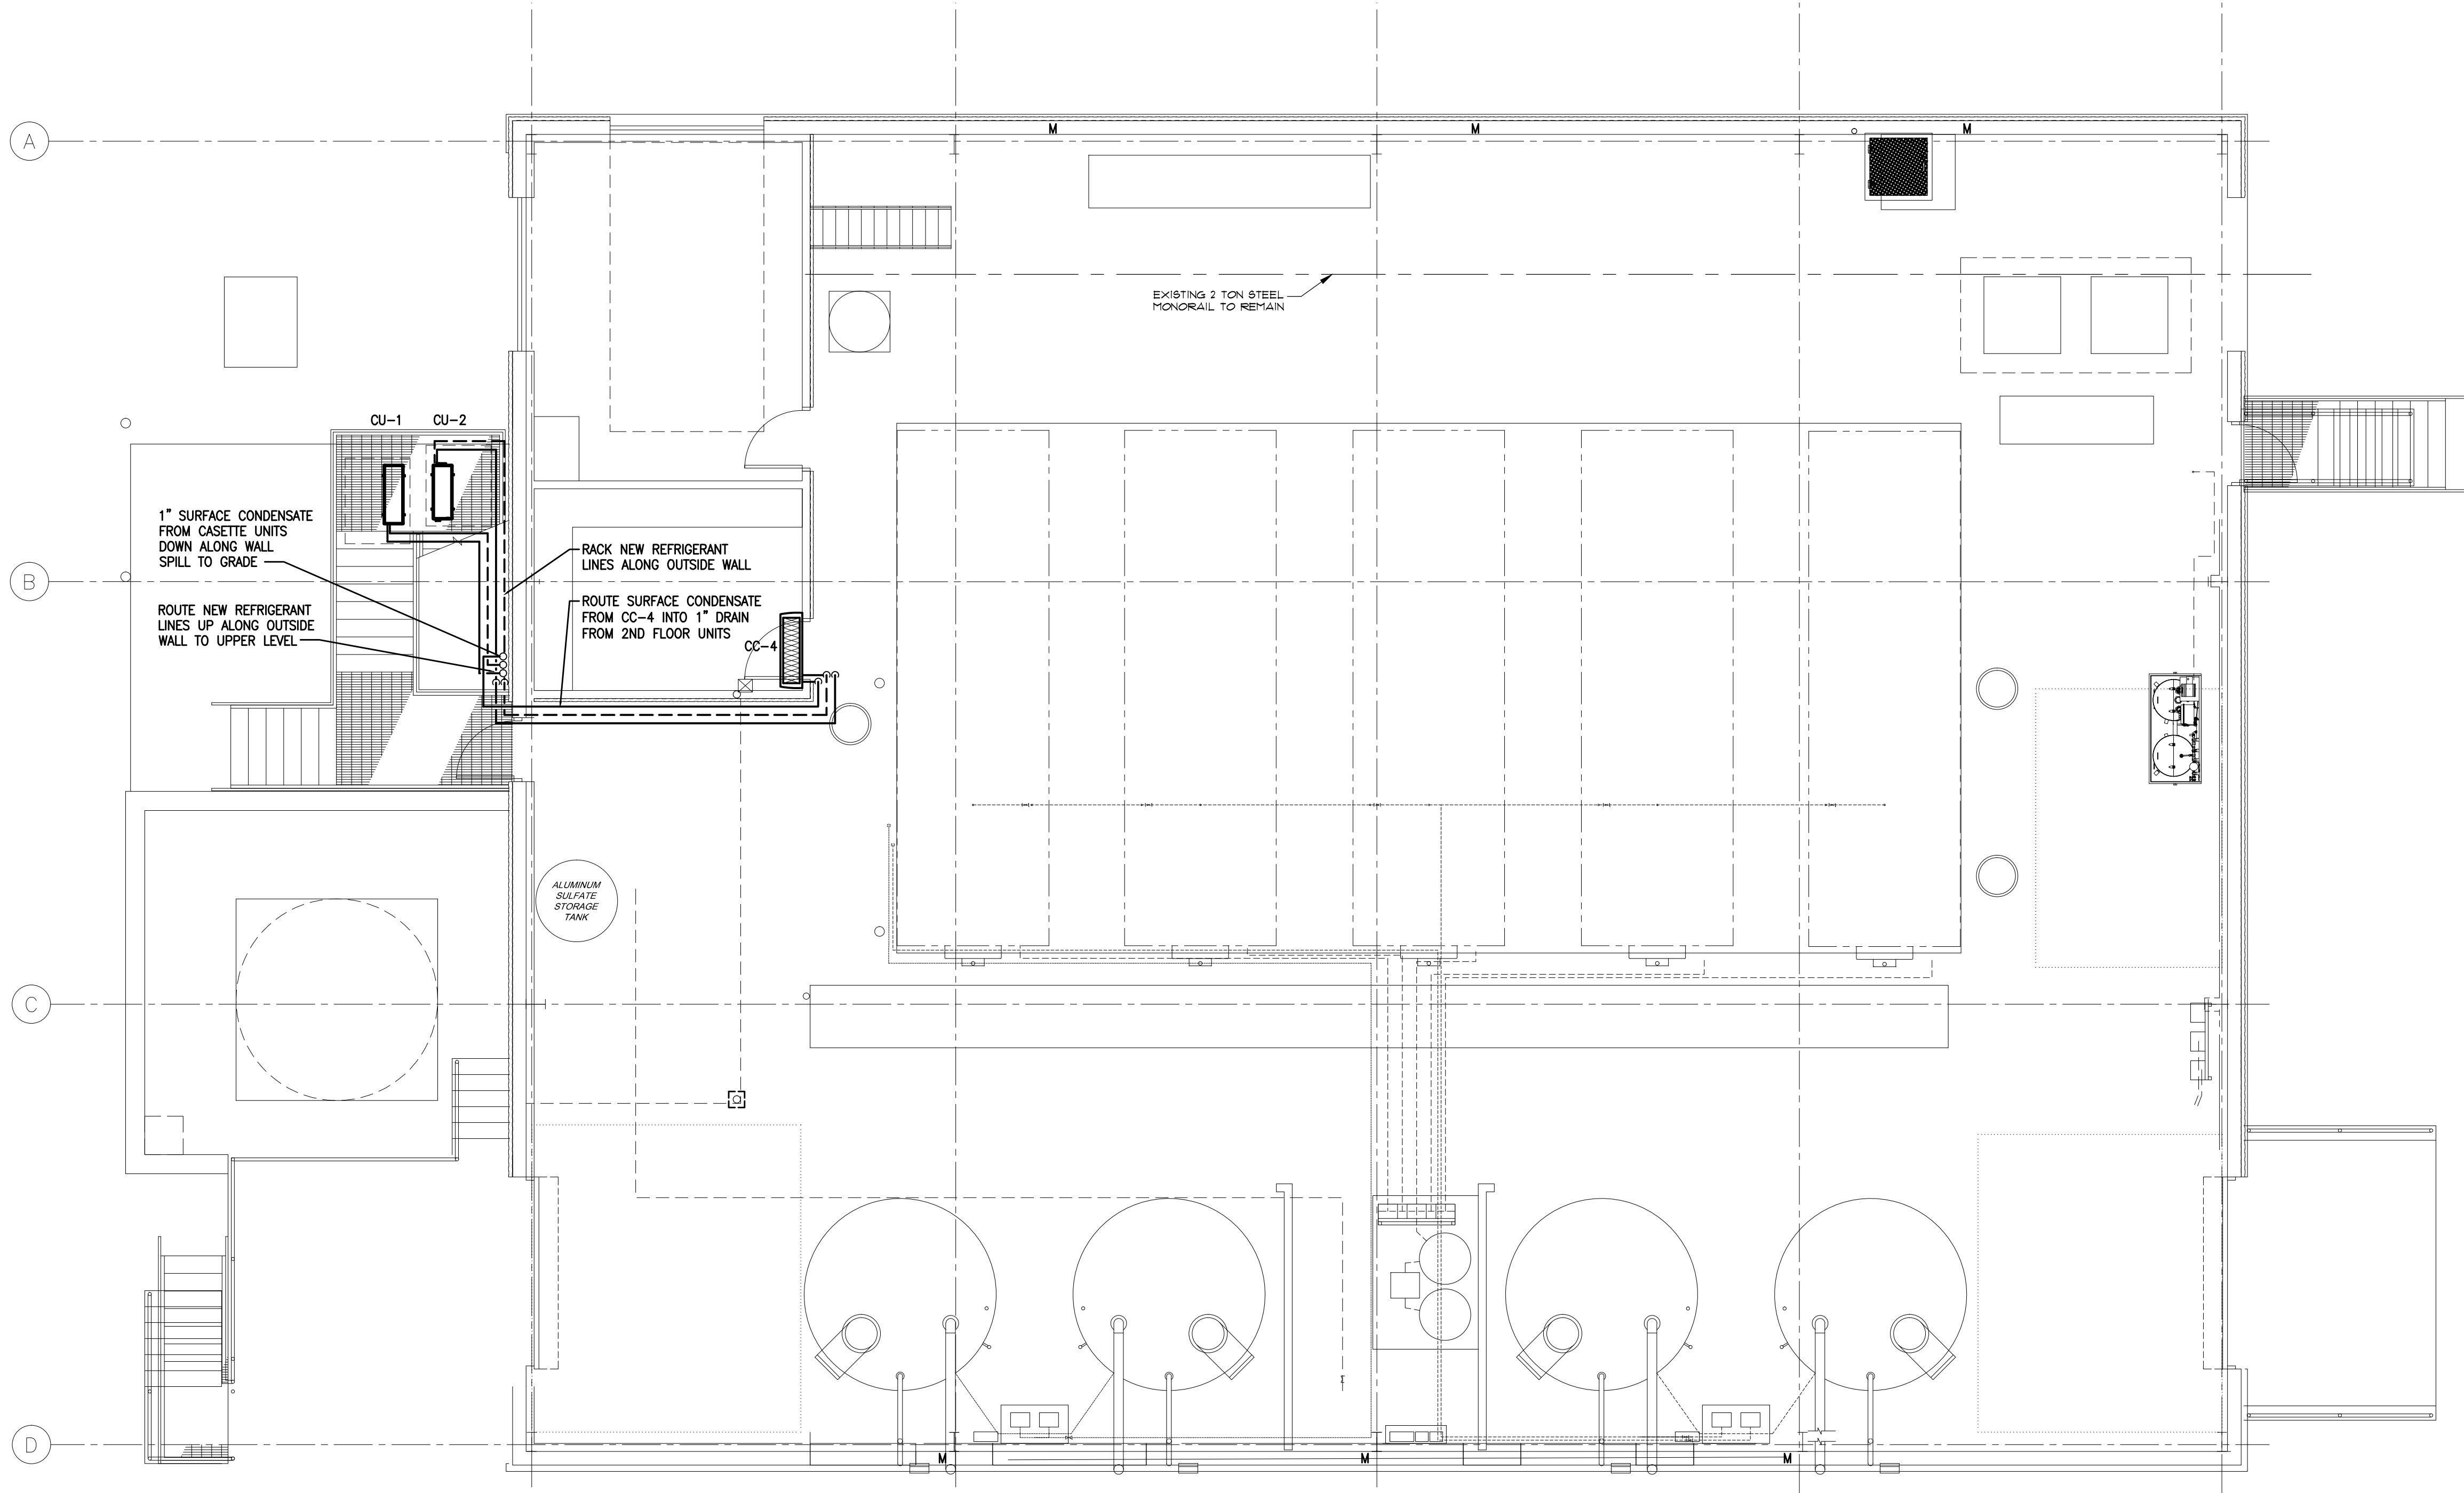
CURTIS WATER TREATMENT PLANT
IMPROVEMENTS
215 PAPER MILL ROAD
NEWARK, DELAWARE
GROUND FLOOR PLAN NEW WORK
CITY OF NEWARK DEPT. OF PUBLIC WORKS AND WATER RESOURCES
220 SOUTH MAIN STREET
NEWARK, DELAWARE 19711

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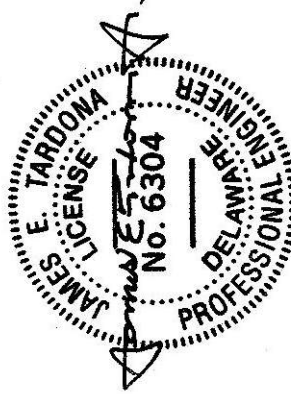
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PROJECT	CNEW1612
DATE	APRIL 2017
DRAWING SCALE	AS SHOWN
DRAWN BY	HMM
APPROVED BY	SJV

M1002
SHEET 42 OF 54


CURTIS WATER TREATMENT PLANT
IMPROVEMENTS
215 PAPER MILL ROAD
NEWARK, DELAWARE
MEZZANINE NEW WORK PLAN
CITY OF NEWARK DEPT. OF PUBLIC WORKS AND WATER RESOURCES
220 SOUTH MAIN STREET
NEWARK, DELAWARE 19711

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CURTIS WATER TREATMENT PLANT
IMPROVEMENTS
215 PAPER MILL ROAD
NEWARK, DELAWARE
ELEVATIONS

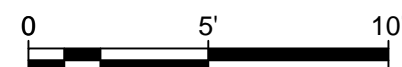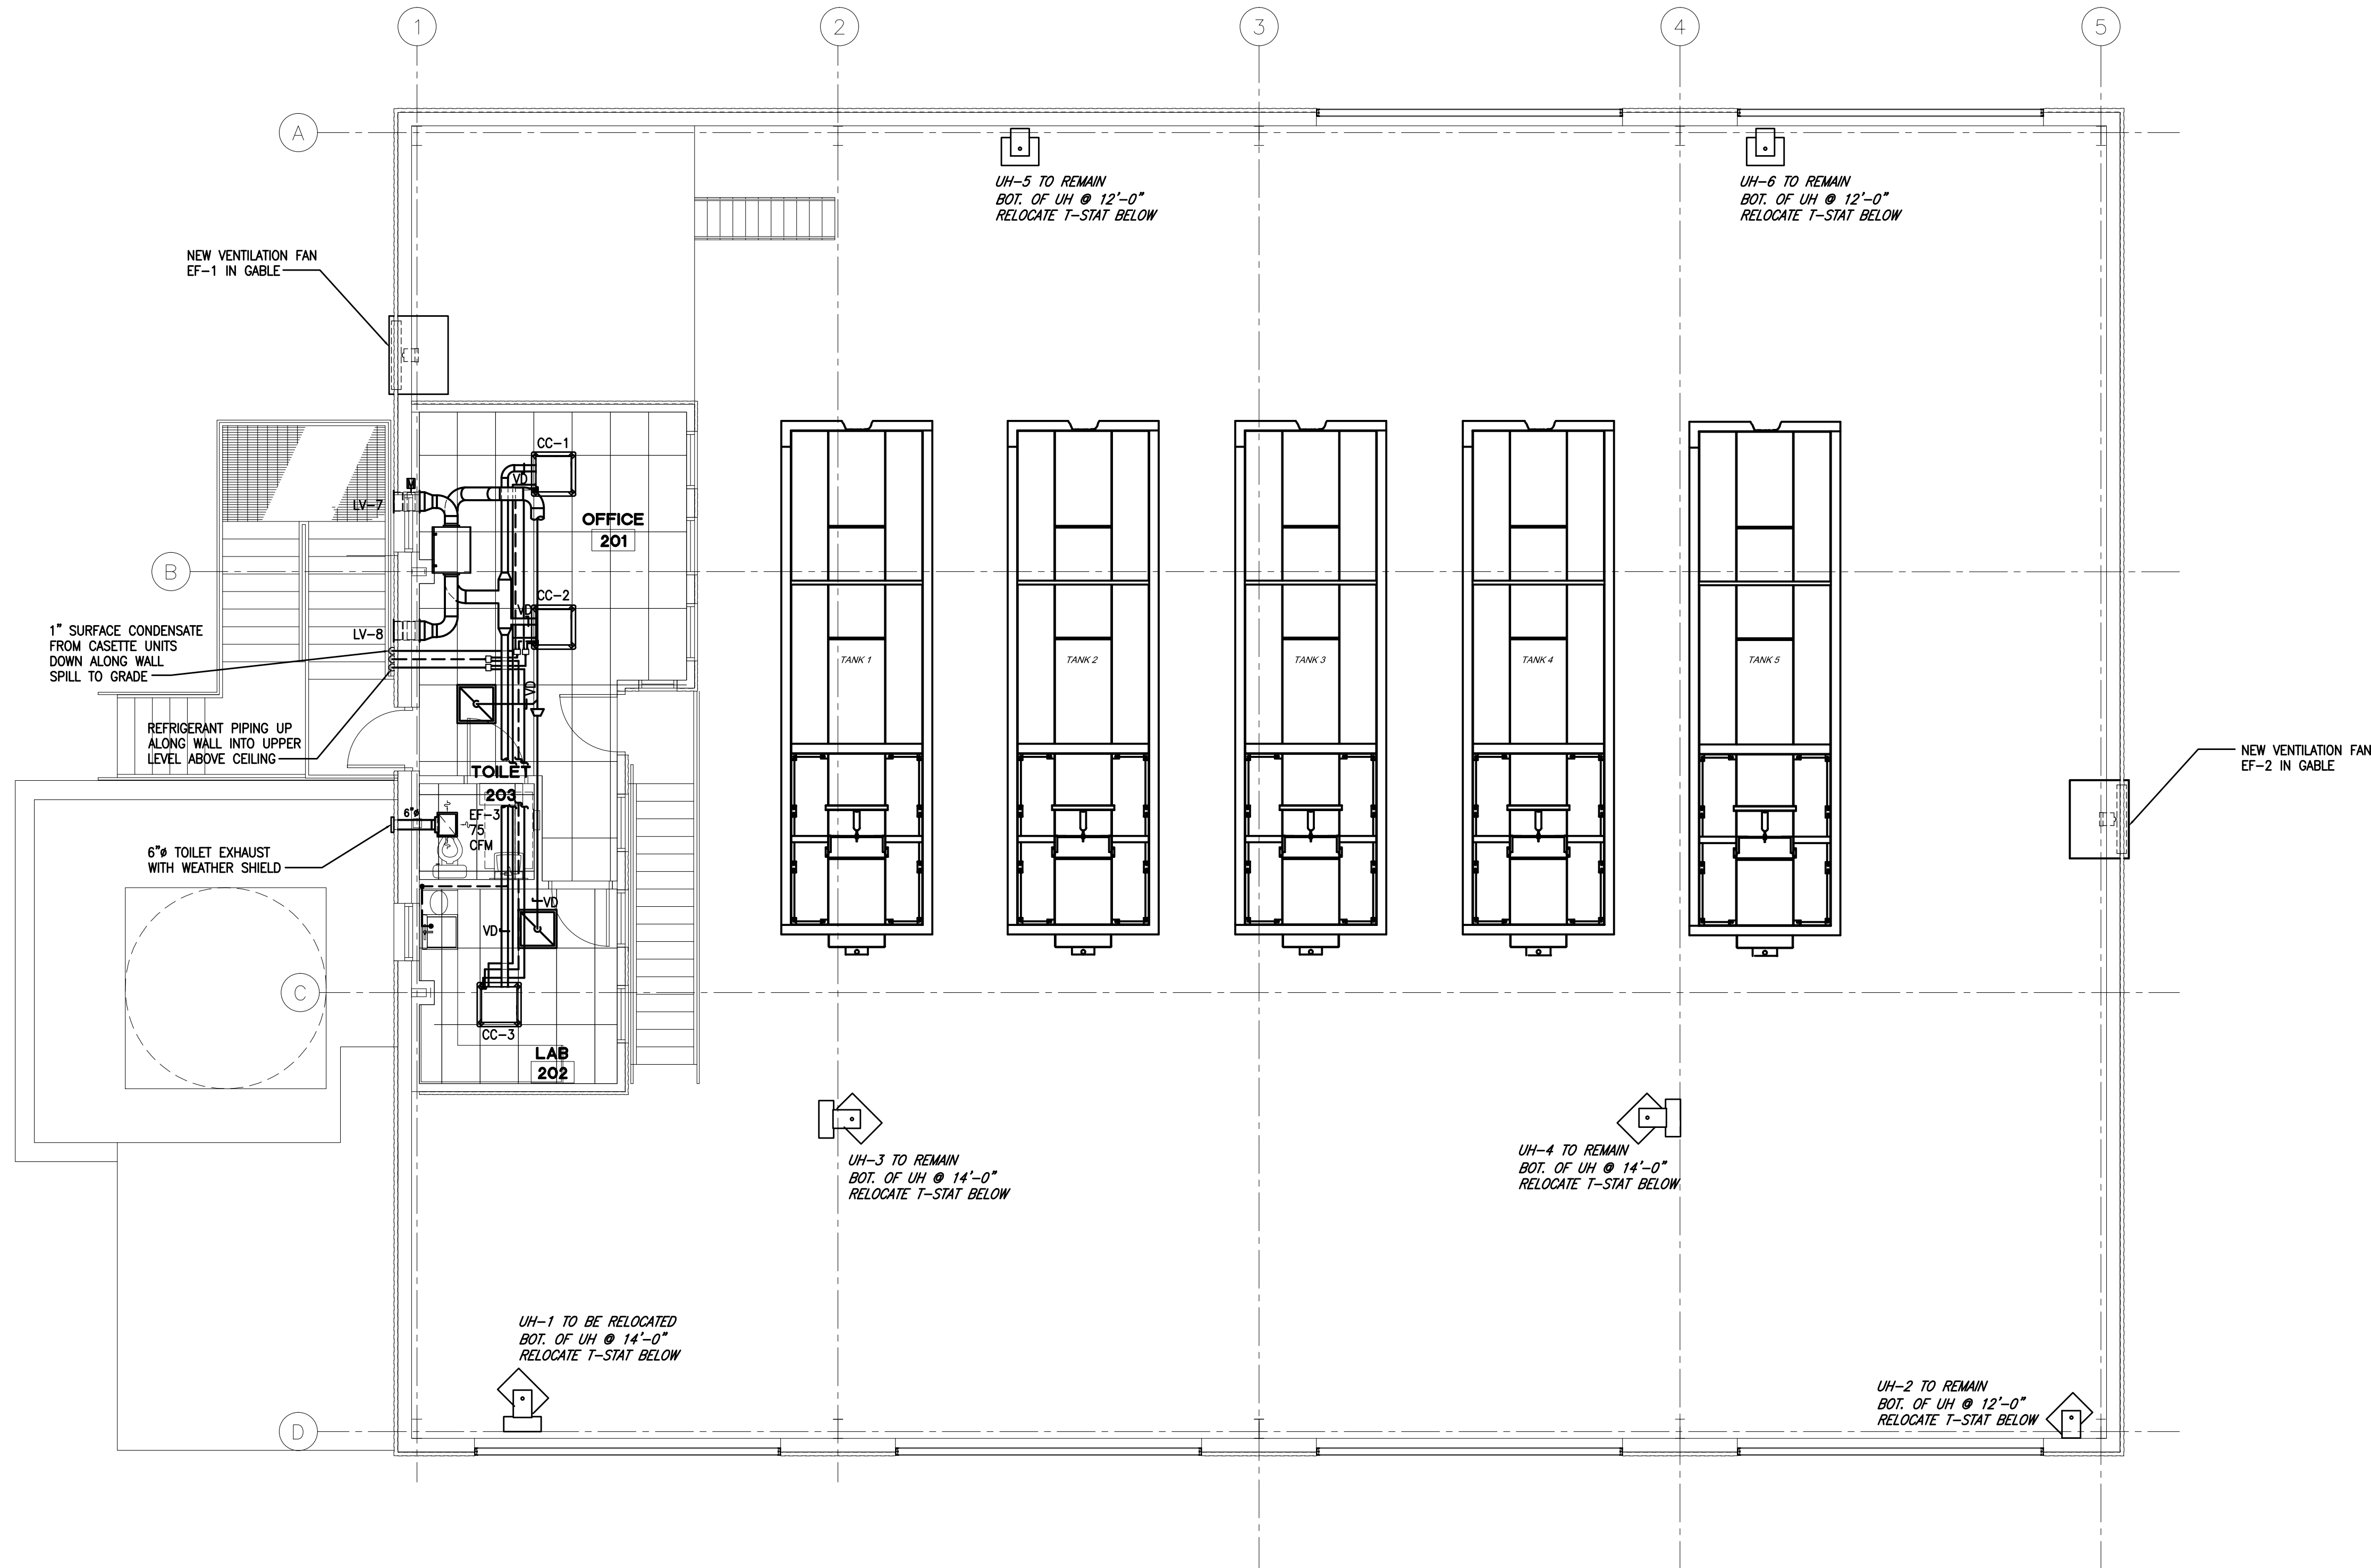CITY OF NEWARK DEPT. OF PUBLIC WORKS AND WATER RESOURCES
220 SOUTH MAIN STREET
NEWARK, DELAWARE 19711


NO.	DATE	REVISIONS	BY

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PROJECT	CNEW1612
DATE	APRIL 2017
DRAWING SCALE	3/16" = 1'-0"
DRAWN BY	HMM
APPROVED BY	SJV
M1003	
SHEET	43 OF 54
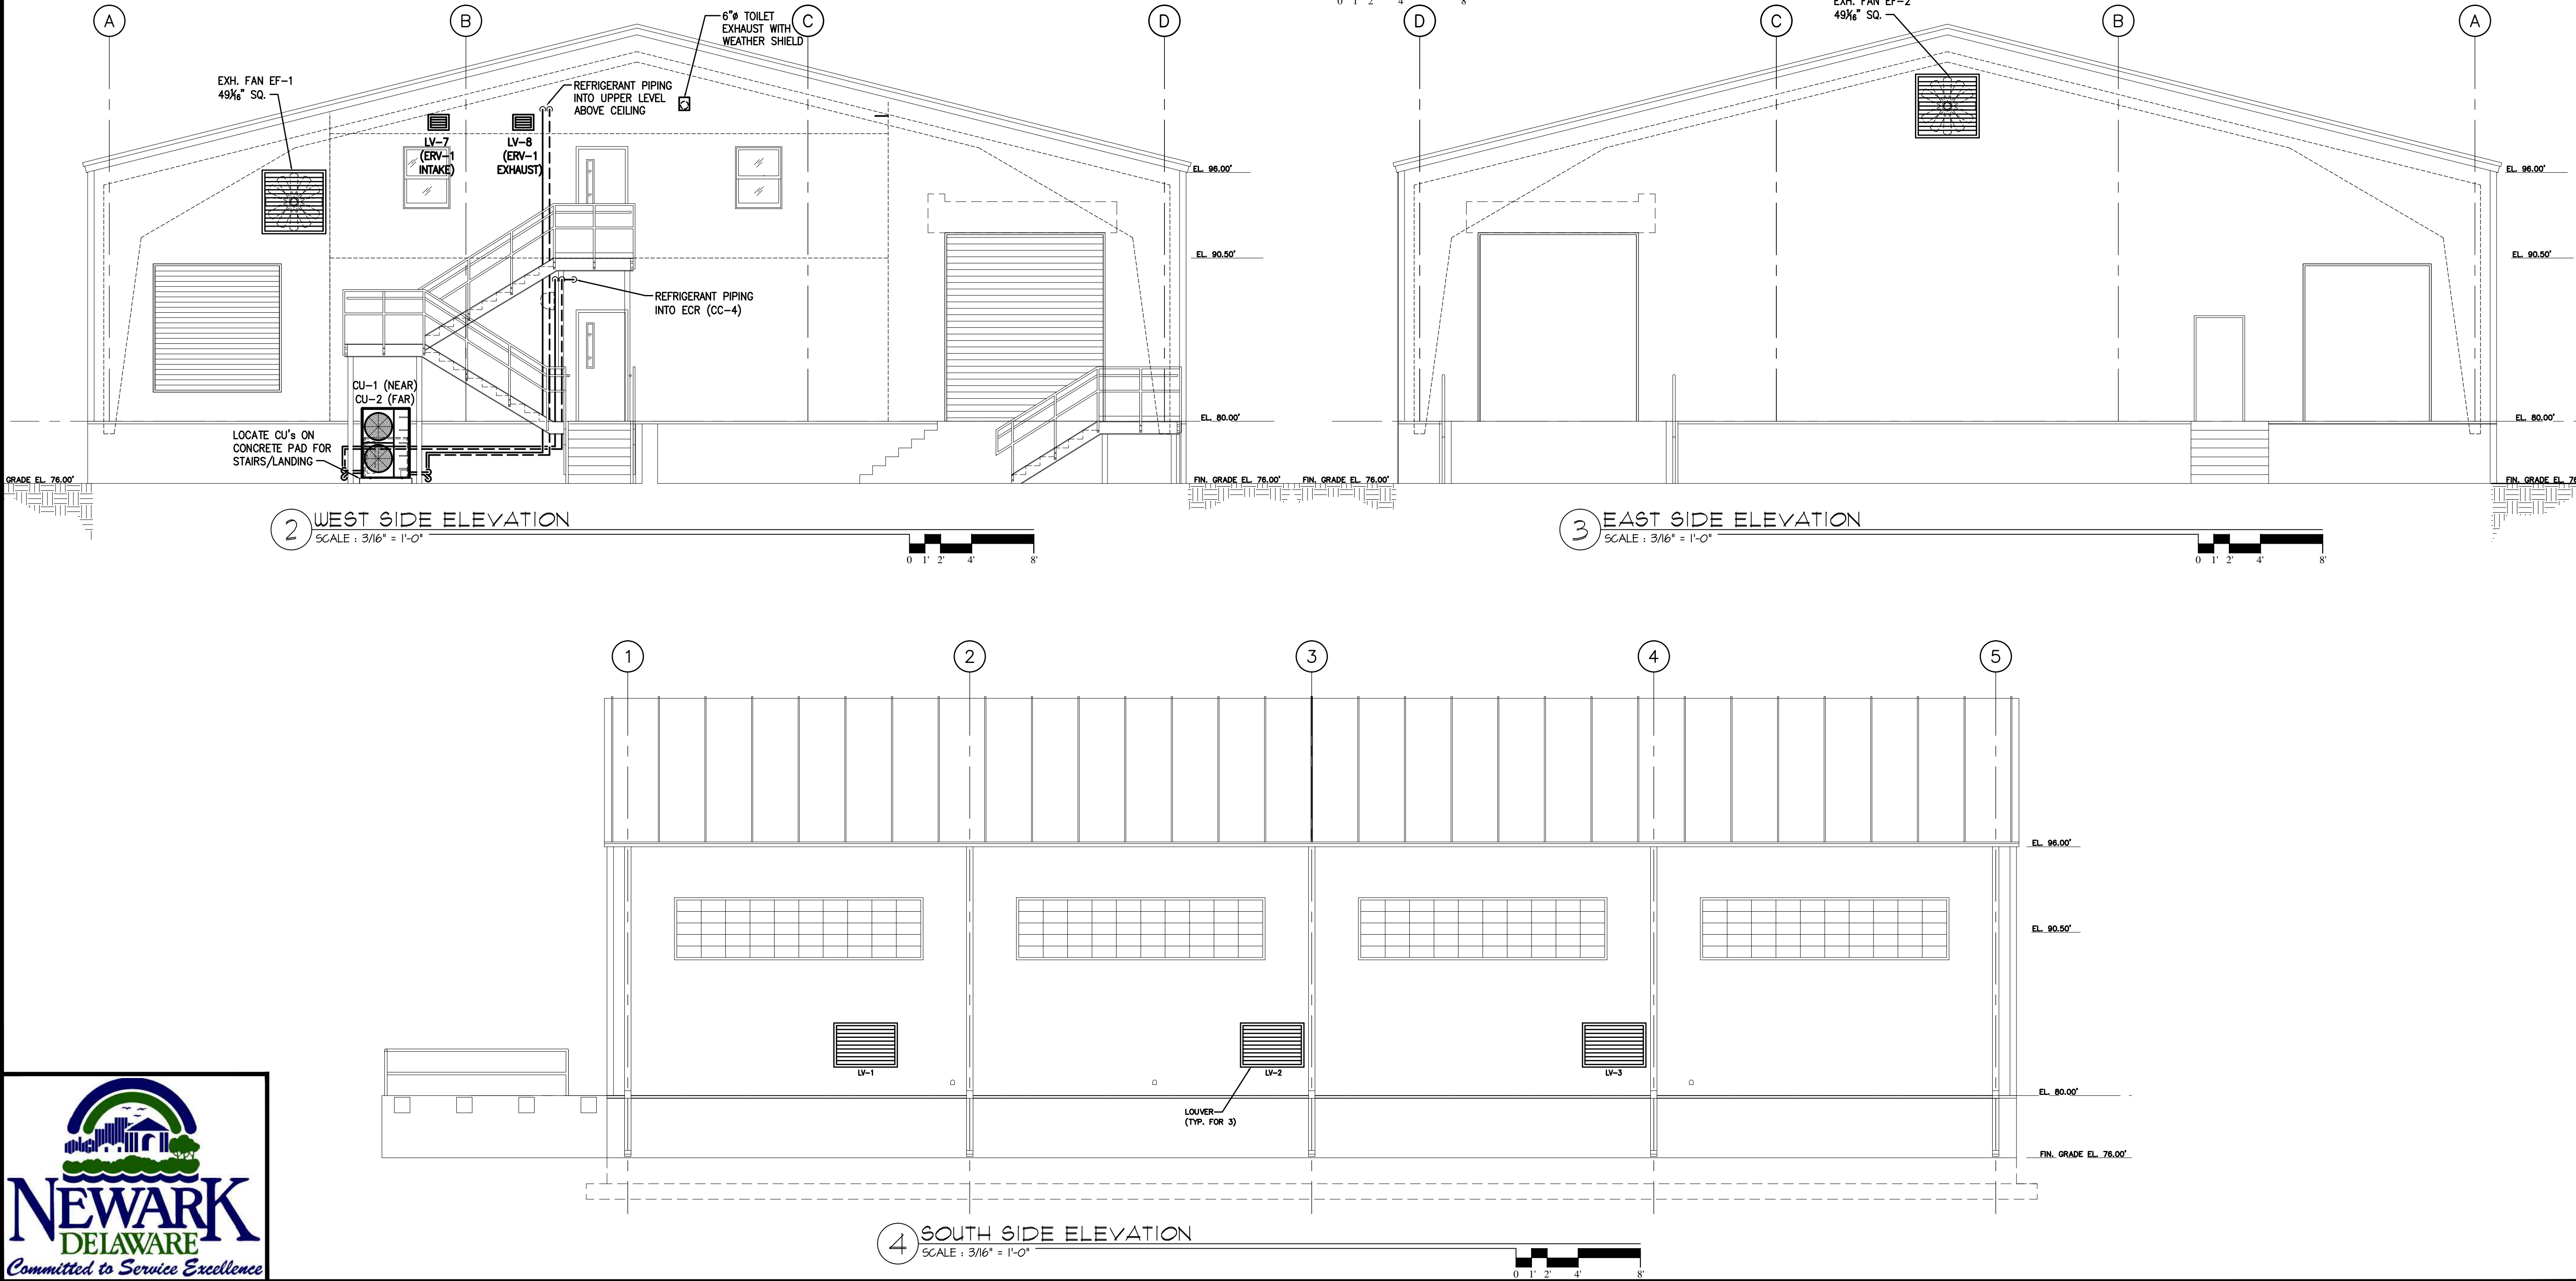
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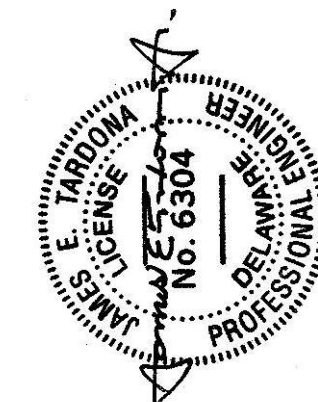
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NOTE:
IN AREAS WHERE EXISTING STRUCTURES HAVE BEEN MODIFIED OR REMOVED DUE TO BUILDING IMPROVEMENTS, ALL NEW AND EXISTING CWH, CWL AND HW AFFECTED BY THE MODIFICATIONS MUST BE RE-SUPPORTED FROM NEW STRUCTURES ACCORDING TO THE APPROPRIATE SECTION OF THE MECHANICAL SPECIFICATIONS.

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**CURTIS WATER TREATMENT PLANT
IMPROVEMENTS**
215 PAPER MILL ROAD
NEWARK, DELAWARE

CITY OF NEWARK DEPT. OF PUBLIC WORKS AND WATER RESOURCES
220 SOUTH MAIN STREET
NEWARK, DELAWARE 19711

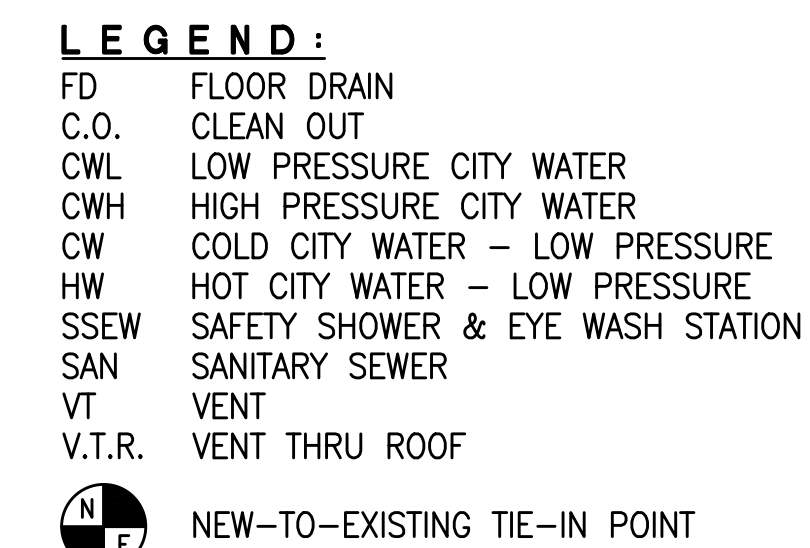
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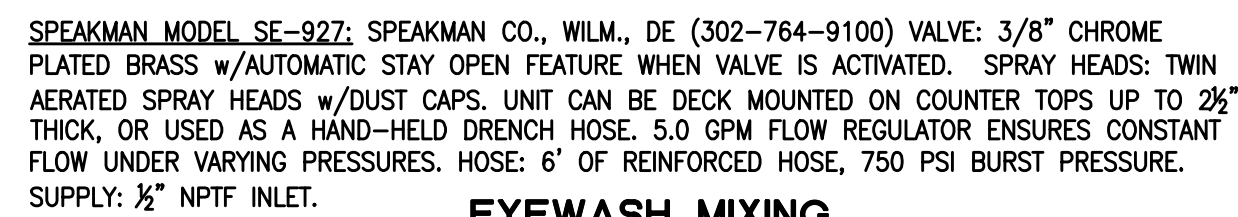
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PROJECT	CNEW1612
DATE	APRIL 2017
DRAWING SCALE	3/16" = 1'-0"
DRAWN BY	HMM
APPROVED BY	SJV

P1001

SHEET 44 OF 54



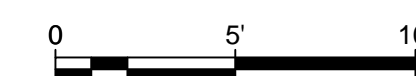



MIXING VALVE
LEONARD VALVE COMPANY - MODEL TM-850-LF



DWHE # DOMESTIC WATER HEATER - ELECTRIC - SCHEDULE

EXPANSION TANK SCHEDULE

SO# WATER SOFTENER SCHEDULE

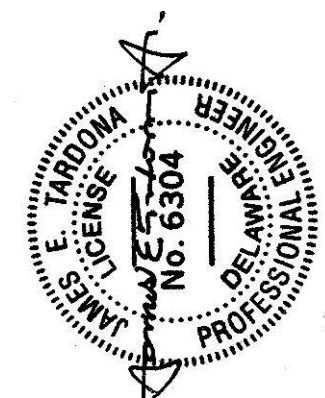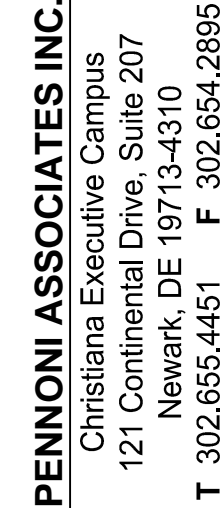

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**CURTIS WATER TREATMENT PLANT
IMPROVEMENTS**
2115 PAPER MILL ROAD
NEWARK, OH 43055
**PLUMBING NEW WORK SCHEMATICS AND
SCHEDULES**

CITY OF NEWARK DEPT. OF PUBLIC WORKS AND WATER RESOURCES
220 SOUTH MAIN STREET
NEWARK, DELAWARE 19711

[illegible]

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PROJECT	CNEW1612
DATE	APRIL 2017
DRAWING SCALE	AS SHOWN
DRAWN BY	HMM
APPROVED BY	SJV

P 1002

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EXHAUST FAN SCHEDULE															
REV #	EQUIPMENT PIECE NO.	NEW/ EXIST'G	LOCATION	AREA SERVED	MODEL	MFGR.	CFM	TOTAL S.P.	RPM	MAX. BHP	HP	VOLTS/ PHASE/HZ	ARRANGEMENT	ROTATION	REMARKS
-	EF-1	NEW	WALL GABLE	TREATMENT	36EP420D08	LOREN COOK	9706	0.25"	860	1.14	1	460/3/60	DIRECT DRIVE	-	460 LBS. SHIPPING WEIGHT; PACKAGED FAN - SEE NOTES 1, 2 & 3
-	EF-2	NEW	WALL GABLE	TREATMENT	36EP420D08	LOREN COOK	9706	0.25"	860	1.14	1	460/3/60	DIRECT DRIVE	-	460 LBS. SHIPPING WEIGHT; PACKAGED FAN - SEE NOTES 1, 2 & 3
-	EF-3	NEW	TOILET CLG	TOILET	SP-A110	GREENHECK	75	0.25	950	058 AMPS	49 WATTS	120/1/60	-	-	WIRED TO LIGHT SWITCH; W/ ROUND DUCT CONNECTOR AND OUTSIDE WALL DISCHARGE - SEE NOTE 2

NOTE 1: PACKAGED FAN SHALL INCLUDE STANDARD EXTRUDED ALUMINUM AIRFOIL PROP FAN IN A GALVANIZED STEEL ENCLOSURE WITH INTEGRAL MOUNTING FLANGE AND WEATHER RESISTANT SHUTTER.
NOTE 2: WEATHER RESISTANT SHUTTER SHALL BE PAINTED TO MATCH COLOR OF BUILDING SIDING. SEE ARCHITECTURAL DRAWINGS FOR COLOR.
NOTE 3: FAN SHALL BE PROVIDED WITH LINE VOLTAGE THERMOSTAT.

LOUVER SCHEDULE																		
REV ▲	EQUIPMENT	NEW/ EXIST'G	LOCATION	MODEL	MFGR.	MATERIAL	NO. OF LOUVER SETS PER ASSEMBLY	SIZE			ACTUAL	% OF	FIXED BLADE TYPE	AIR FLOW CFM	VELOCITY	S.P.	SCREEN	REMARKS
	PIECE NO.							HEIGHT	LENGTH	DEPTH	SQ. FT.	FACE AREA			FPM	DROP	TYPE	
-	LV-1	NEW	WALL	ELC6375DAX	RUSKIN	ALUMINUM	1	30	45	6	9.375	42	DRAINABLE	3333	841	0.10	INSECT SCR.	SEE NOTES 1 & 2
-	LV-2	NEW	WALL	ELC6375DAX	RUSKIN	ALUMINUM	1	30	45	6	9.375	42	DRAINABLE	3333	841	0.10	INSECT SCR.	SEE NOTES 1 & 2
-	LV-3	NEW	WALL	ELC6375DAX	RUSKIN	ALUMINUM	1	30	45	6	9.375	42	DRAINABLE	3333	841	0.10	INSECT SCR.	SEE NOTES 1 & 2
-	LV-4	NEW	WALL	ELC6375DAX	RUSKIN	ALUMINUM	1	30	45	6	9.375	42	DRAINABLE	3333	841	0.10	INSECT SCR.	SEE NOTES 1 & 2
-	LV-5	NEW	WALL	ELC6375DAX	RUSKIN	ALUMINUM	1	30	45	6	9.375	42	DRAINABLE	3333	841	0.10	INSECT SCR.	SEE NOTES 1 & 2
-	LV-6	NEW	WALL	ELC6375DAX	RUSKIN	ALUMINUM	1	30	45	6	9.375	42	DRAINABLE	3333	841	0.10	INSECT SCR.	SEE NOTES 1 & 2
-	LV-7	NEW	WALL	ELF375DX	RUSKIN	ALUMINUM	1	12	12	4	-	-	DRAINABLE	150	-	-	INSECT SCR.	INTAKE LOUVER FOR ERV-1 - SEE NOTE 2
-	LV-8	NEW	WALL	ELF375DX	RUSKIN	ALUMINUM	1	12	12	4	-	-	DRAINABLE	150	-	-	INSECT SCR.	EXHAUST LOUVER FOR ERV-1 - SEE NOTE 2

NOTE 1: LOUVER SHALL BE PROVIDED COMPLETE WITH EXTERNAL INSECT SCREEN AND 120vac TWO-POSITION SPRING-RETURN ACTUATOR.
NOTE 2: LOUVER SHALL BE PAINTED TO MATCH COLOR OF BUILDING SIDING. SEE ARCHITECTURAL DRAWINGS FOR COLOR.


DAMPER SCHEDULE																		
REV ▲ △	EQUIPMENT PIECE NO.	MODEL	MFGR.	SIZE	TYPE	NO. OF DAMPERS PER ASSEMBLY	MANUAL OR AUTO	ACTUATOR MODEL	ACTUATOR MFGR.	PNEUMATIC OR ELECTRIC	ACTUATOR VOLTAGE	MOTOR OPERATION	OPERATOR FAIL POS	MATERIAL			TYPE OF OPERATING BLADE SEAL	REMARKS
														BLADE	SHAFT	LINKAGE		
—	DAMP-1	NEW	—	12x12	INTAKE	1	AUTO	—	—	ELECT	120/1/60	—	OPEN	—	—	—	—	—

CONDENSER - AIR COOLED SCHEDULE																
REV ▲	EQUIPMENT	NEW/ EXIST'G	LOCATION	MODEL	MFGR.	NOMINAL	OUTDOOR AIR		COND	FAN	COMPR.	VOLTS/	REFRIGERANT	WEIGHT		REMARKS
	PIECE NO.					TONS	HEAT,WB	COOL, DB	FIN MATERIAL	# @ HP	MOTOR KW	PHASE/HZ	TYPE AND CHARGE	SHIPPING	OPERAT'G	
-	CU-1	NEW	OUTSIDE	ARUN038GSS	LGE	3	-4 - 61°F	23 - 122°F	-	2 @ 5	3.52	208-230/1/60	R410A-6.6 LBS.	218	207	SERVING UPPER LEVEL OFFICE AND LAB
-	CU-2	NEW	OUTSIDE	LS240HLV	LGE	2	-4 - 65°F	14 - 118°F	-	1	2.38	208-230/1/60	R410A-4.85 LBS.	133	125	SERVING ECR

ENERGY RECOVERY VENTILATOR																								
REV ▲	EQUIPMENT PIECE NO.	NEW/ EXIST'G	LOCATION	MODEL	MFGR.	CFM	SUPPLY AIR FAN						ESP (INCHES WG)	FILTERS			NOMINAL ARI NET EFFECTIVENESS (%)		SHIPPING WEIGHT	OPER. WEIGHT	REMARKS			
							RPM	BHP	HP	VOLTS/ PHASE/HZ	FLA	BHP		HP	INPUT WATTS	CFM	TYPE	No.				SIZE	COOLING	HEATING
-	ERV-1	NEW	UPPER LEVEL	EV200	RENEWAIRE	150	-	-	0.1	120/1/60	1.5	NA	NA	157@181	0.6	MERV8	2	10.5x21.4x1	61	75	110	68	WITH FRESH AIR AND EXHAUST AIR OUTSIDE LOUVERS	

CEILING CASSETTE SCHEDULE																																							
REV ▲	EQUIPMENT		NEW/ EXIST'G	LOCATION	MODEL	MFGR.	TOTAL CFM	CFM O/A	# OF FANS	SIZE	EXT. S.P.	COND PUMP	HP	V/PH/HZ	INPUT CURRENT (AMPS)	COOLING SECTION								HEATING SECTION						FILTERS		WEIGHT	REMARKS						
	PIECE NO.															AIR TEMPERATURE				REFRIGERANT				SENS. MBH		TOTAL MBH	LIQ. CONN.	AIR TEMPERATURE						TOTAL MBH	VAPOR CONN.	P	S	SIZE	SHIPPING
																	EDB	EWB	LDB	LWB	TYPE	CONT.	CHG.					FDB	FWB	LDB	LWB								
-	CC-1	NEW	OFF. 201	-	LGE	283	-	1	24x24	-	1	-	1	-	208-230/1/60	-	80.6°F	67.1°F	-	-	R410A	EEV	-	-	9.6	9.6	1/4"	68°F	56.8°F	-	-	-	10.9	1/2"	1*	1*	-	36	MODEL ARNU093TRC4
-	CC-2	NEW	OFF. 201	-	LGE	283	-	1	24x24	-	1	-	1	-	208-230/1/60	-	80.6°F	67.1°F	-	-	R410A	EEV	-	-	9.6	9.6	1/4"	68°F	56.8°F	-	-	-	10.9	1/2"	1*	1*	-	36	MODEL ARNU093TRC4
-	CC-3	NEW	LAB 202	-	LGE	396	-	1	24x24	-	1	-	1	-	208-230/1/60	-	80.6°F	67.1°F	-	-	R410A	EEV	-	-	19.1	19.1	1/4"	68°F	56.8°F	-	-	-	21.5	1/2"	1*	1*	-	40	MODEL ARNU183TQC4
-	CC-4	NEW	ECR	-	LGE	396	-	1	13x47	-	1	-	1	-	208-230/1/60	-	80°F	67°F	-	53°F	R410A	EEV	-	-	22	3/8"	70°F	60°F	86°F	-	-	-	27	5/8"	1*	1*	-	40	MODEL LSN240HLV; WALL MOUNTED

* FILTERS: P (PRIMARY) = WASHABLE; S (SECONDARY) = PLASMA

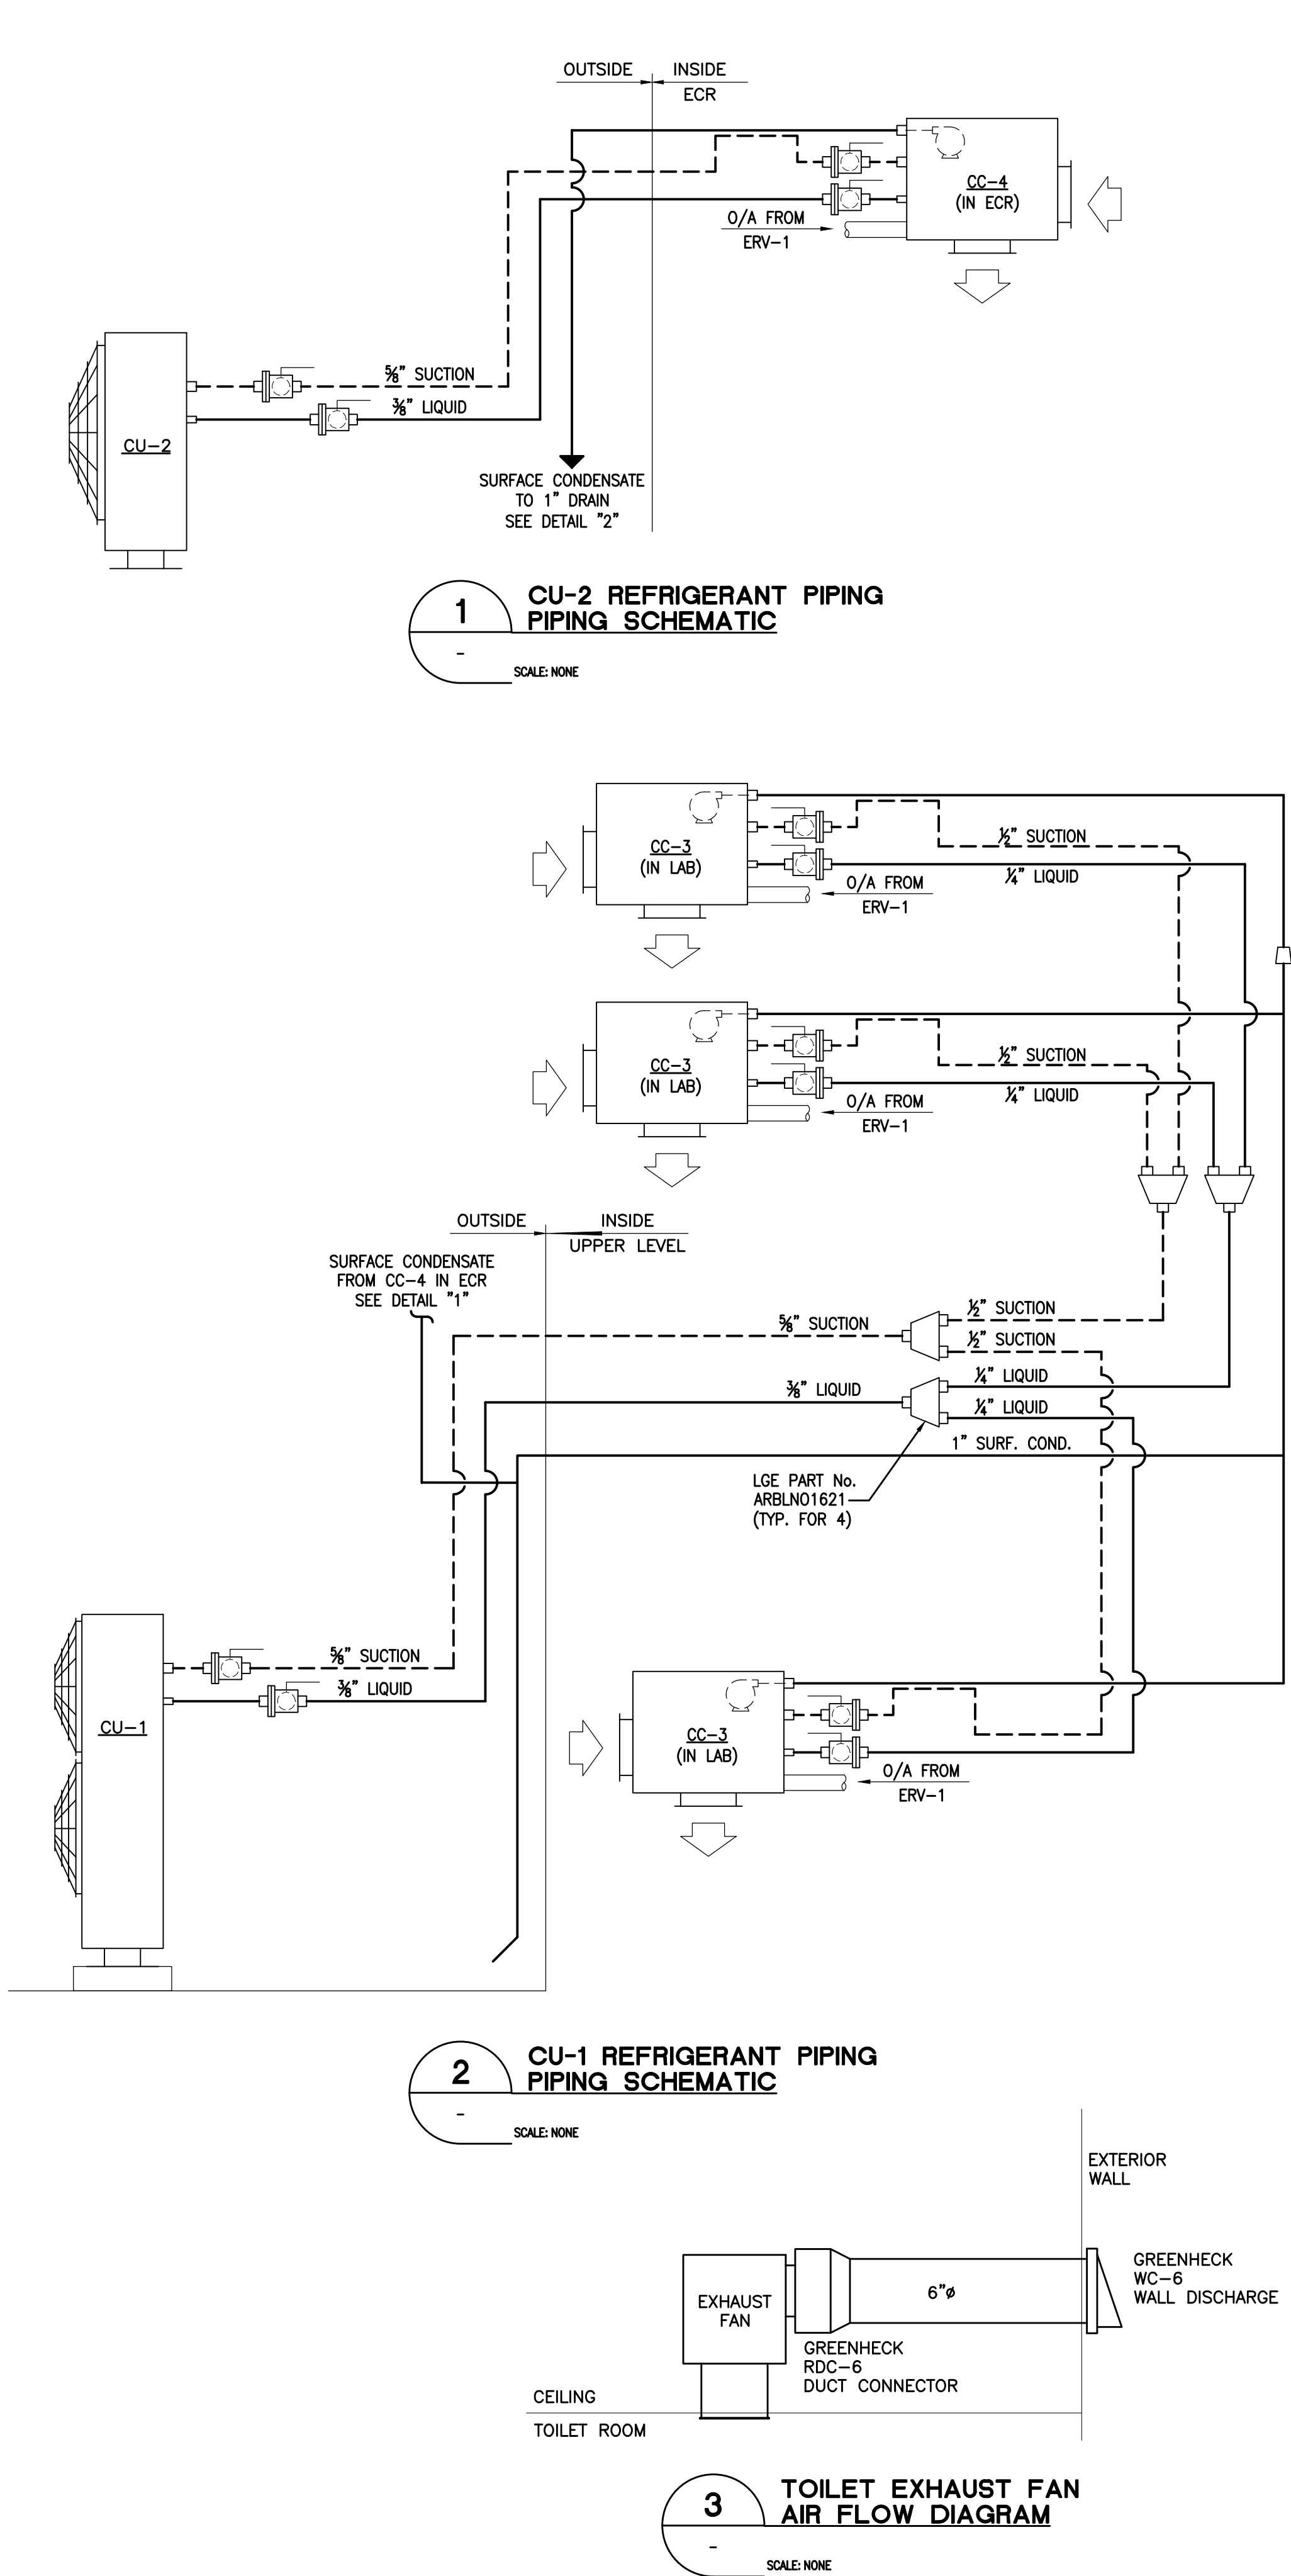

PENNONI ASSOCIATES INC.
Christiana Executive Campus
121 Continental Drive, Suite 207
Newark, DE 19713-4310
T 302.655.4451 F 302.654.2885

ALL DIMENSIONS MUST BE VERIFIED BY CONTRACTOR AND OWNER MUST BE NOTIFIED OF ANY DISCREPANCIES BEFORE PROCEEDING WITH WORK

CURTIS WATER TREATMENT PLANT IMPROVEMENTS
215 PAPER MILL ROAD
NEWARK, DELAWARE

EQUIPMENT SCHEDULES AND DETAILS

CITY OF NEWARK DEPT. OF PUBLIC WORKS AND WATER RESOURCES
220 SOUTH MAIN STREET
NEWARK, DELAWARE 19711

NO.	DATE	REVISIONS	BY

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PROJECT	CNEW1612
DATE	APRIL 2017
DRAWING SCALE	AS SHOWN
DRAWN BY	HMM
APPROVED BY	SJV

M1004

SHEET 47 OF 54

CONSTRUCTION NOTES

1. THE CONTRACTOR SHALL COORDINATE WORK ACTIVITIES WITH THE CITY AND SHALL NOT INTERFERE WITH WATER TREATMENT PLANT OPERATION UNLESS SUITABLE ARRANGEMENTS HAVE BEEN MADE NOT LESS THAN FIVE (5) DAYS IN ADVANCE.
2. AT NO TIME SHALL THE CONTRACTOR PERFORM TREATMENT PLANT OPERATION WITHOUT DIRECT SUPERVISION OF THE LICENSED CITY OPERATORS. THE CONTRACTOR SHALL BE RESPONSIBLE TO COORDINATE HIS WORK WITH THE CITY OPERATION STAFF.
3. SHOULD ANY OF THE CONTRACTOR'S OPERATIONS RESULT IN A REGULATORY AGENCY CITATION AGAINST THE OWNER, THE CONTRACTOR SHALL BEAR THE FULL RESPONSIBILITY OF THIS CITATION.
4. SHOULD THE CONTRACTORS ACTIVITIES RESULT IN THE DEGRADATION OF FILTER SYSTEM PERFORMANCE, THE CONTRACTOR SHALL BE RESPONSIBLE FOR THE PAYMENT OF ANY FINES OR ADDITIONAL COSTS RESULTING FROM SUCH DEGRADATION OF FILTER SYSYEM PERFORMANCE.
5. CONTRACTOR SHALL BE RESPONSIBLE FOR VERIFYING ALL DIMENSIONS IN THE FIELD. ANY DISCREPANCIES BETWEEN THE CONTRACT DRAWINGS AND THE CONTRACTOR'S FIELD MEASUREMENTS SHALL BE BROUGHT TO THE ATTENTION OF THE ENGINEER IMMEDIATELY.
6. CONTRACTOR SHALL PROVIDE SHOP DRAWINGS IDENTIFYING ACTUAL FIELD MEASUREMENTS AND THE LAYOUT FOR THE PROPOSED EQUIPMENT AND MATERIALS FOR REVIEW BY THE ENGINEER.
7. CHEMICAL STORAGE TANKS SHALL BE FURNISHED IN A SIZE TO BE BROUGHT THROUGH THE GARAGE DOOR OPENINGS AND SHALL BE ERRECTED IN PLACE WITH THE PROPER ORIENTATION TO ALLOW FULL ACCESS TO THE MANWAY OPENING AND PIPE EXTENSIONS THROUGH THE EXTERIOR WALL FOR THE FILL AND VENT LINES.
8. CHEMICAL STORAGE TANKS SHALL BE FURNISHED AND INSTALLED WITH STABILIZATION ANCHORING SYSTEM TO PREVENT MOVEMENT OR TIPPING.
9. ALL METALS IN CONTACT WITH CONCRETE SHALL BE COATED WITH BITUMASTIC PAINT TO PREVENT CORROSION.
10. VENT PIPING SHALL BE INDEPENDENT FOR EACH CHEMICAL STORAGE TANK AND SHALL BE INSTALLED FROM TOP OF TANK THROUGH EXTERIOR WALL WITH SCREENED OPENING.
11. BULK CHEMICAL FILL PIPES SHALL BE INSTALLED FROM TOP OF TANK TO EXTERIOR WALL THEN DOWN TO 8" ABOVE FLOOR LEVEL BEFORE PENETRATION THROUGH THE EXTERIOR WALL. FITTINGS SHALL MATCH HOSES AND CONNECTIONS USED BY BULK DELIVERY SUPPLIER.

PIPING NOTES

1. CONTRACTOR SHALL REVIEW PIPING LAYOUT WITH THE OWNER PRIOR TO INSTALLATION TO VERIFY CLEARANCE AND WORKSPACE AREAS.
2. PROCESS AND CHEMICAL PIPING SHALL BE INSTALLED WITH PIPE SUPPORTS AND MOUNTING BRACKETS TO KEEP PIPES IN PLACE AND PREVENT JOINT SEPARATION.

TANK NOTES

1. THE SODIUM HYPOCHLORITE AND SODIUM HYDROXIDE TANKS SHALL BE PROVIDED WITH EXTERNAL FLOAT LEVEL INDICATOR AND AN INTERNAL ULTRASONIC LEVEL SENSOR.

SEQUENCE OF CONSTRUCTION


THE SEQUENCE PROVIDED BELOW IS A GENERAL GUIDE. THE SELECTED CONTRACTOR SHALL SUBMIT A DETAILED SEQUENCE OF CONSTRUCTION TO THE CITY PRIOR TO THE PRE-CONSTRUCTION MEETING.

1. MOBILIZE AND SETUP
2. INSTALL TEMPORARY CONTAINMENT ENCLOSURE FOR THE 5 FILTER UNITS
3. INSTALL TEMPORARY BYPASS CARRY WATER LINE FOR LIQUID ALUMINUM SULFATE AND SODIUM HYPOCHLORITE
4. INSTALL SODIUM HYPOCHLORITE TANK AND TEMPORARY CHEMICAL FEED SYSTEM
5. DEMOLISH UNUSED EQUIPMENT AND CONDUIT
6. DEMOLISH AND INSTALL NEW ROOFING SYSTEM AND ROOF HATCH
7. DEMOLISH LABORATORY WALLS, FURNISHINGS, ETC.

8. DEMOLISH OFFICE AND STORAGE ROOM
9. DEMOLISH CHLORINE ROOM, CHEMICAL ROOM, AND AREAS NEAR MEZZANINE WITH TEMPORARY MEZZANINE SUPPORTS
10. INSTALL FOUNDATION AND SUPPORTS FOR MEZZANINE STRUCTURAL SUPPORTS
11. INSTALL INTERIOR STAIR SYSTEM TO MEZZANINE
12. DEMOLISH AND INSTALL NEW WALL SIDING SYSTEM, STAIR SYSTEMS, AND EXTERIOR DOORS
13. INSTALL FANS AND LOUVERS
14. INSTALL SODIUM HYDROXIDE TANK
15. INSTALL SODIUM HYPOCHLORITE, SODIUM HYDROXIDE, LIQUID POLYMER, AND FLUORIDE PUMP SKID SYSTEMS
16. INSTALL CHEMICAL PIPING SYSTEM AND CARRY WATER PIPING


17. INSTALL LIQUID POLYMER BLENDING AND FEED SYSTEM
18. INSTALL CONDUIT AND WIRING FOR POWER AND CONTROLS FOR CHEMICAL FEED
19. DRAIN CLEAR WELL
20. INSTALL CHEMICAL FEED PIPING TO CLEAR WELL.
21. REPLACE ACCESS HATCH AND LADDER
22. DISINFECT CLEAR WELL
23. REFILL CLEAR WELL AND RETURN TO OPERATION.
24. CONSTRUCT OFFICE AND LABORATORY SPACE WALLS, DOORS, AND WINDOW IMPROVEMENTS
25. INSTALL ELECTRICAL CONDUITS AND WIRING FOR OFFICE AND LAB
26. INSTALL PLUMBING AND HVAC FOR OFFICE AND LAB.
27. INSTALL FURNISHINGS AND FINISHES IN OFFICE AND LAB

28. PAINT AND LABEL PIPING AND CONDUIT
29. PREPARE AS-BUILT CONDITION DRAWINGS

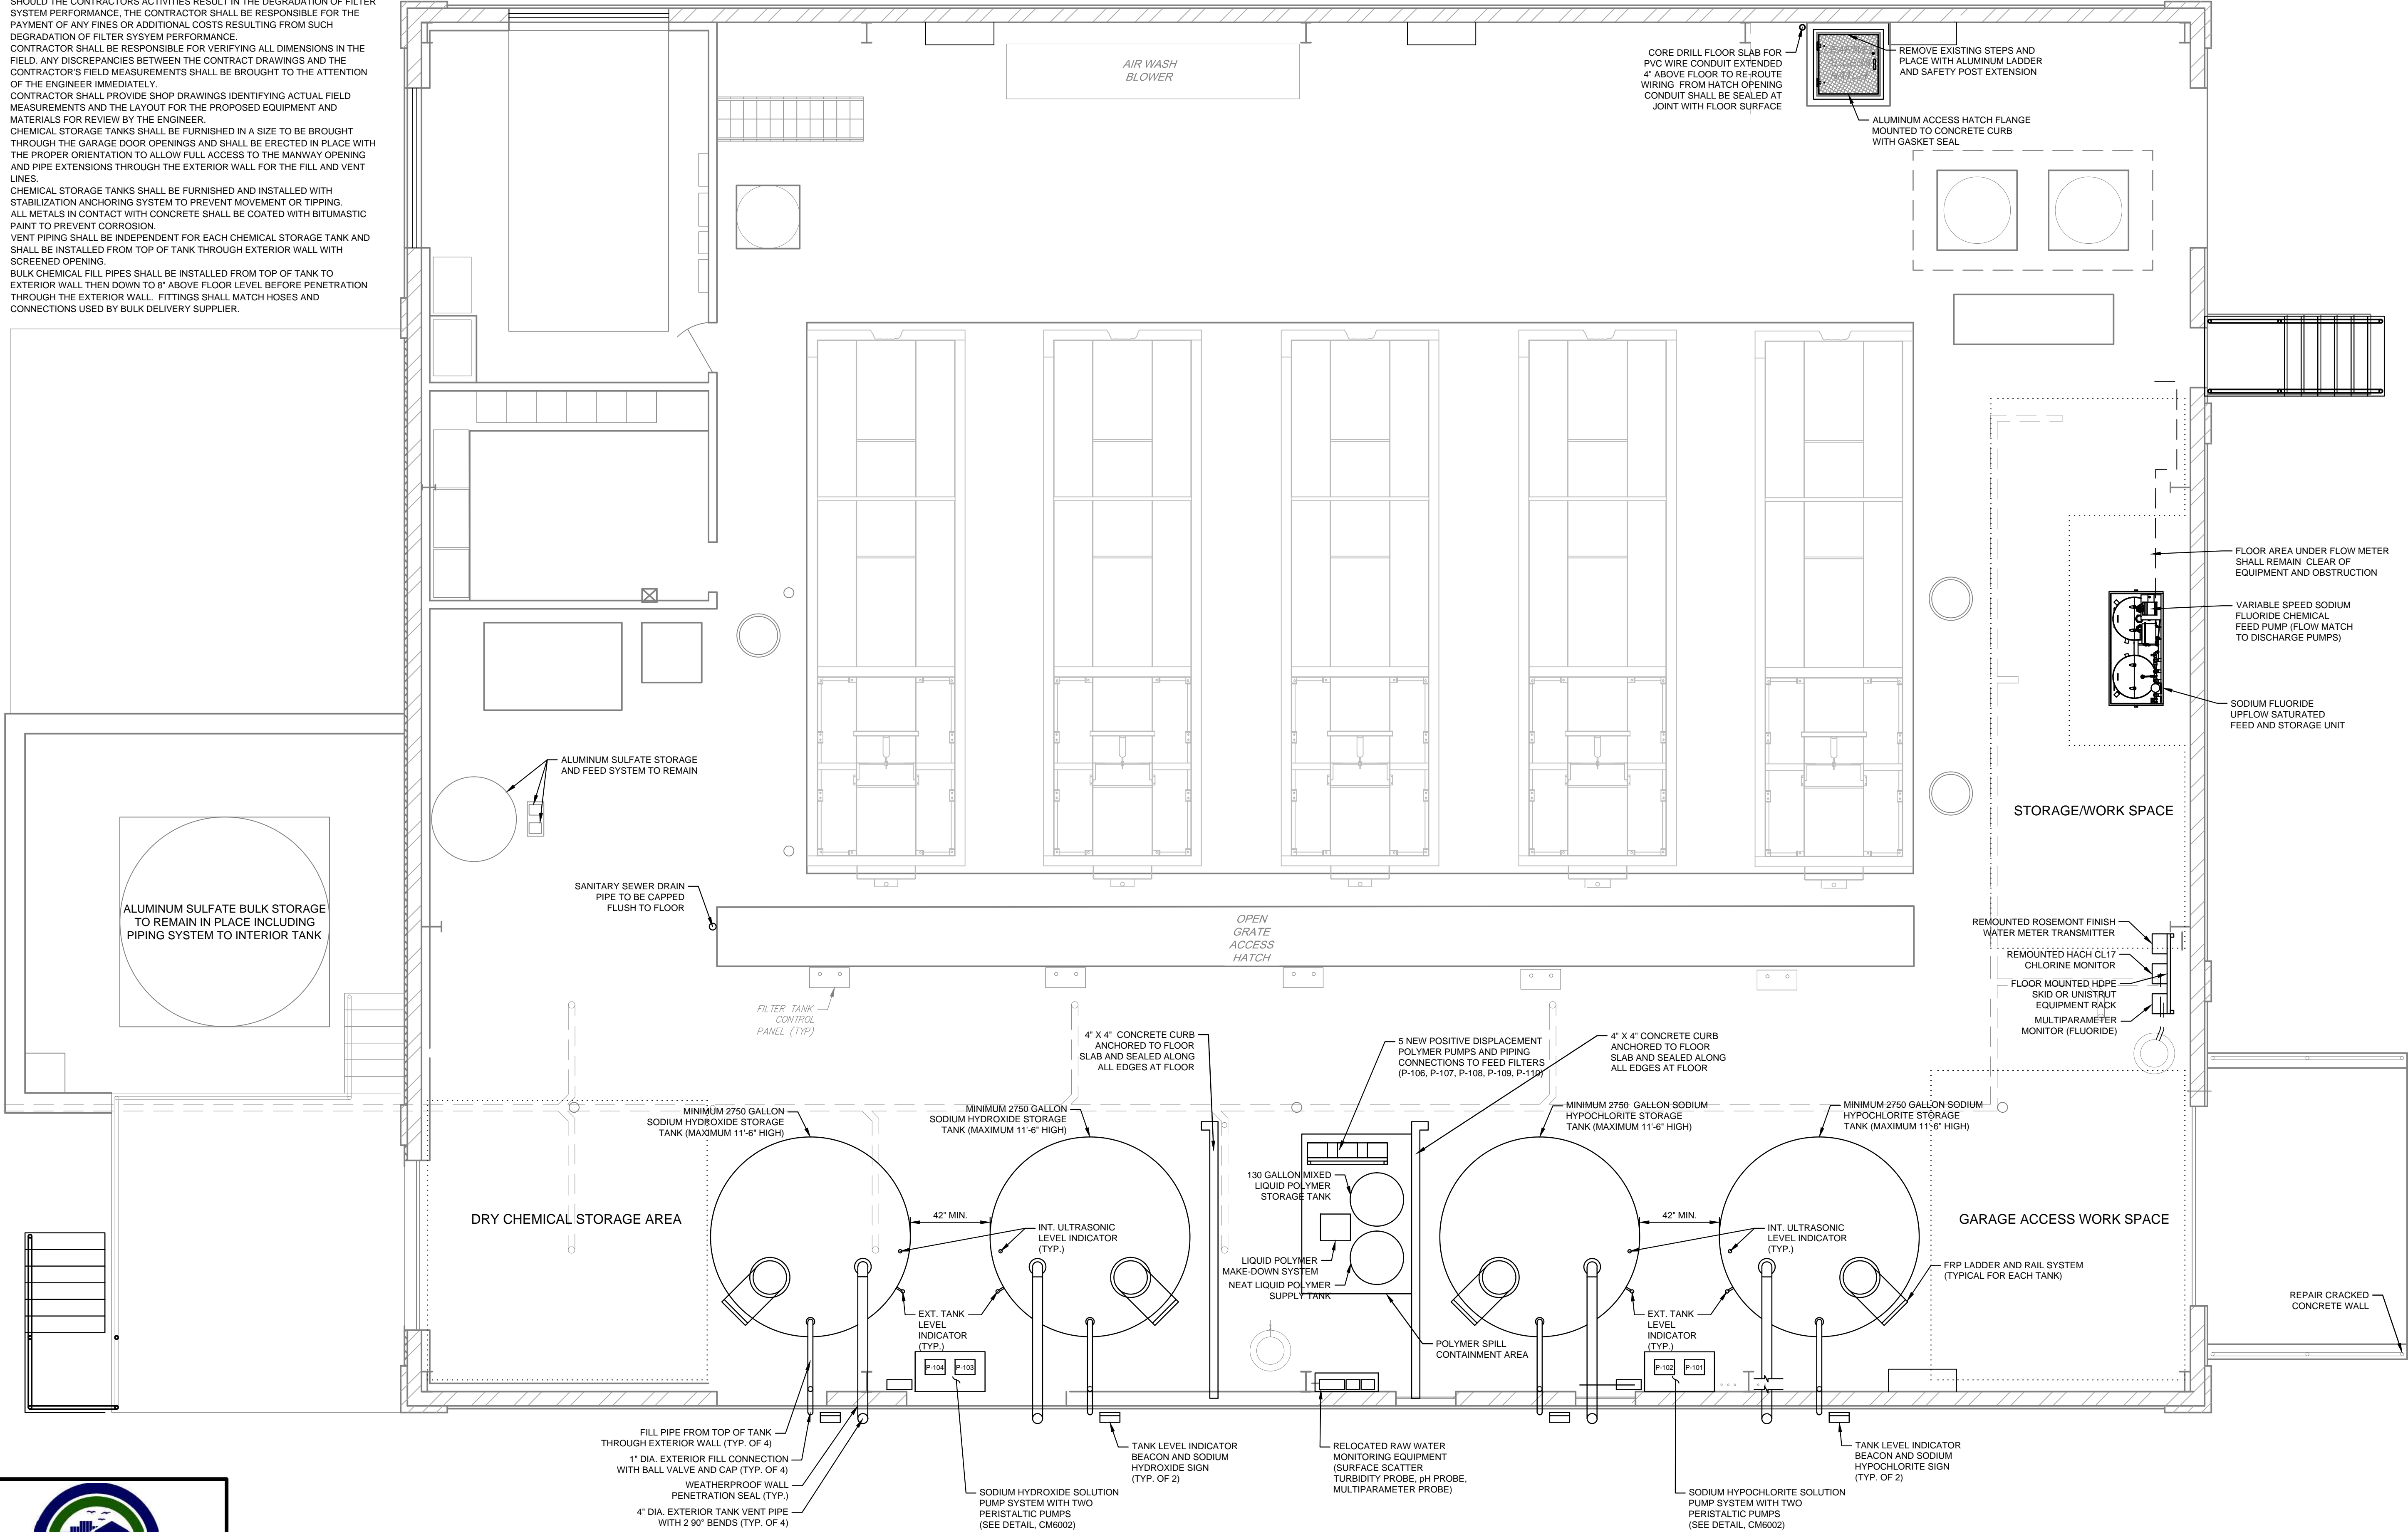

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CURTIS WATER TREATMENT PLANT
IMPROVEMENTS
PROCESS EQUIPMENT PLAN

215 PAPER MILL ROAD
NEWARK, DELAWARE

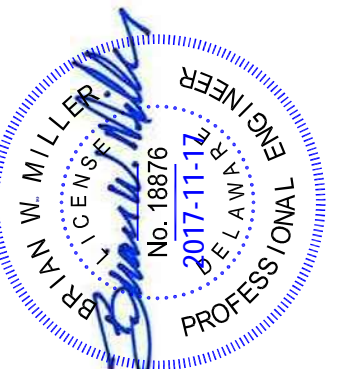CITY OF NEWARK DEPT. OF PUBLIC WORKS AND WATER RESOURCES
220 SOUTH MAIN STREET
NEWARK, DELAWARE 19711

NO.	DATE	REVISIONS	BY


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PROJECT	CNEW1612
DATE	APRIL 2017
DRAWING SCALE	1/4" = 1'-0"
DRAWN BY	MWF/BWM
APPROVED BY	DPB



1. THE CONTRACTOR SHALL COORDINATE WORK ACTIVITIES WITH THE CITY AND SHALL NOT INTERFERE WITH WATER TREATMENT PLANT OPERATION UNLESS SUCH ARRANGEMENTS HAVE BEEN MADE NOT LESS THAN FIVE (5) DAYS IN ADVANCE.
2. AT NO TIME SHALL THE CONTRACTOR PERFORM TREATMENT PLANT OPERATION WITHOUT DIRECT SUPERVISION OF THE LICENSED CITY OPERATORS. THE CONTRACTOR SHALL BE RESPONSIBLE TO COORDINATE HIS WORK WITH THE CITY OPERATING STAFF.
3. SHOULD ANY OF THE CONTRACTOR'S OPERATIONS RESULT IN A REGULATORY AGENCY CITATION AGAINST THE OWNER, THE CONTRACTOR SHALL BEAR THE FULL RESPONSIBILITY OF THIS CITATION.
4. SHOULD THE CONTRACTOR'S ACTIONS RESULT IN THE DEGRADATION OF FILTER SYSTEM PERFORMANCE, THE CONTRACTOR SHALL BE RESPONSIBLE FOR THE PAYMENT OF ANY FINES OR ADDITIONAL COSTS RESULTING FROM SUCH DEGRADATION OF FILTER SYSTEM PERFORMANCE.
5. CONTRACTOR SHALL BE RESPONSIBLE FOR VERIFYING ALL DIMENSIONS IN THE FIELD. ANY DISCREPANCIES BETWEEN THE CONTRACT DRAWINGS AND THE CONTRACTOR'S FIELD MEASUREMENTS SHALL BE BROUGHT TO THE ATTENTION OF THE ENGINEER IMMEDIATELY.
6. CONTRACTOR SHALL PROVIDE SHOP DRAWINGS IDENTIFYING ACTUAL FIELD MEASUREMENTS AND THE LAYOUT FOR THE PROPOSED EQUIPMENT AND MATERIALS FOR REVIEW BY THE ENGINEER.
7. CHEMICAL STORAGE TANKS SHALL BE FURNISHED IN A SIZE TO BE BROUGHT THROUGH THE GARAGE DOOR OPENINGS AND SHALL BE ERECTED IN PLACE WITH THE PROPER ORIENTATION TO ALLOW FULL ACCESS TO THE MANWAY OPENING AND PIPE EXTENSIONS THROUGH THE EXTERIOR WALL FOR THE FILL AND VENT LINES.
8. CHEMICAL STORAGE TANKS SHALL BE FURNISHED AND INSTALLED WITH STABILIZATION ANCHORING SYSTEM TO PREVENT MOVEMENT OR TIPPING. ALL METALS IN CONTACT WITH CONCRETE SHALL BE COATED WITH BITUMASTIC TO PREVENT CORROSION.
9. VENT PIPING SHALL BE INDEPENDENT FOR EACH CHEMICAL STORAGE TANK AND SHALL BE INSTALLED FROM TOP OF TANK THROUGH EXTERIOR WALL WITH SCREENED OPENING.
10. EACH CHEMICAL PIPING SHALL BE INSTALLED FROM TOP OF TANK TO EXTERIOR WALL THRU DOWN TO 8' ABOVE FLOOR LEVEL BEFORE PENETRATION THROUGH THE EXTERIOR WALL. FITTINGS SHALL MATCH HOSES AND CONNECTIONS USED BY BULK DELIVERY SUPPLIER.

1. CONTRACTOR SHALL REVIEW PIPING LAYOUT WITH THE OWNER PRIOR TO INSTALLATION TO VERIFY CLEARANCE AND WORKSPACE AREAS.
2. CHEMICAL FEED PIPING SHALL BE CONSTRUCTED OF DOUBLE WALL PVC/CPVC WITH A CLEAR OUTER PIPE FOR ALL OVERHEAD PIPING.
3. PROCESS AND CHEMICAL PIPING SHALL BE INSTALLED WITH PIPE SUPPORTS AND MOUNTING BRACKETS TO KEEP PIPES IN PLACE AND PREVENT JOINT SEPARATION.
4. POLYMER FEED PIPING SHALL BE REPLACED TO THE EXTENT NECESSARY TO CONNECT THE NEW POLYMER FEED SYSTEM IN PLACE.

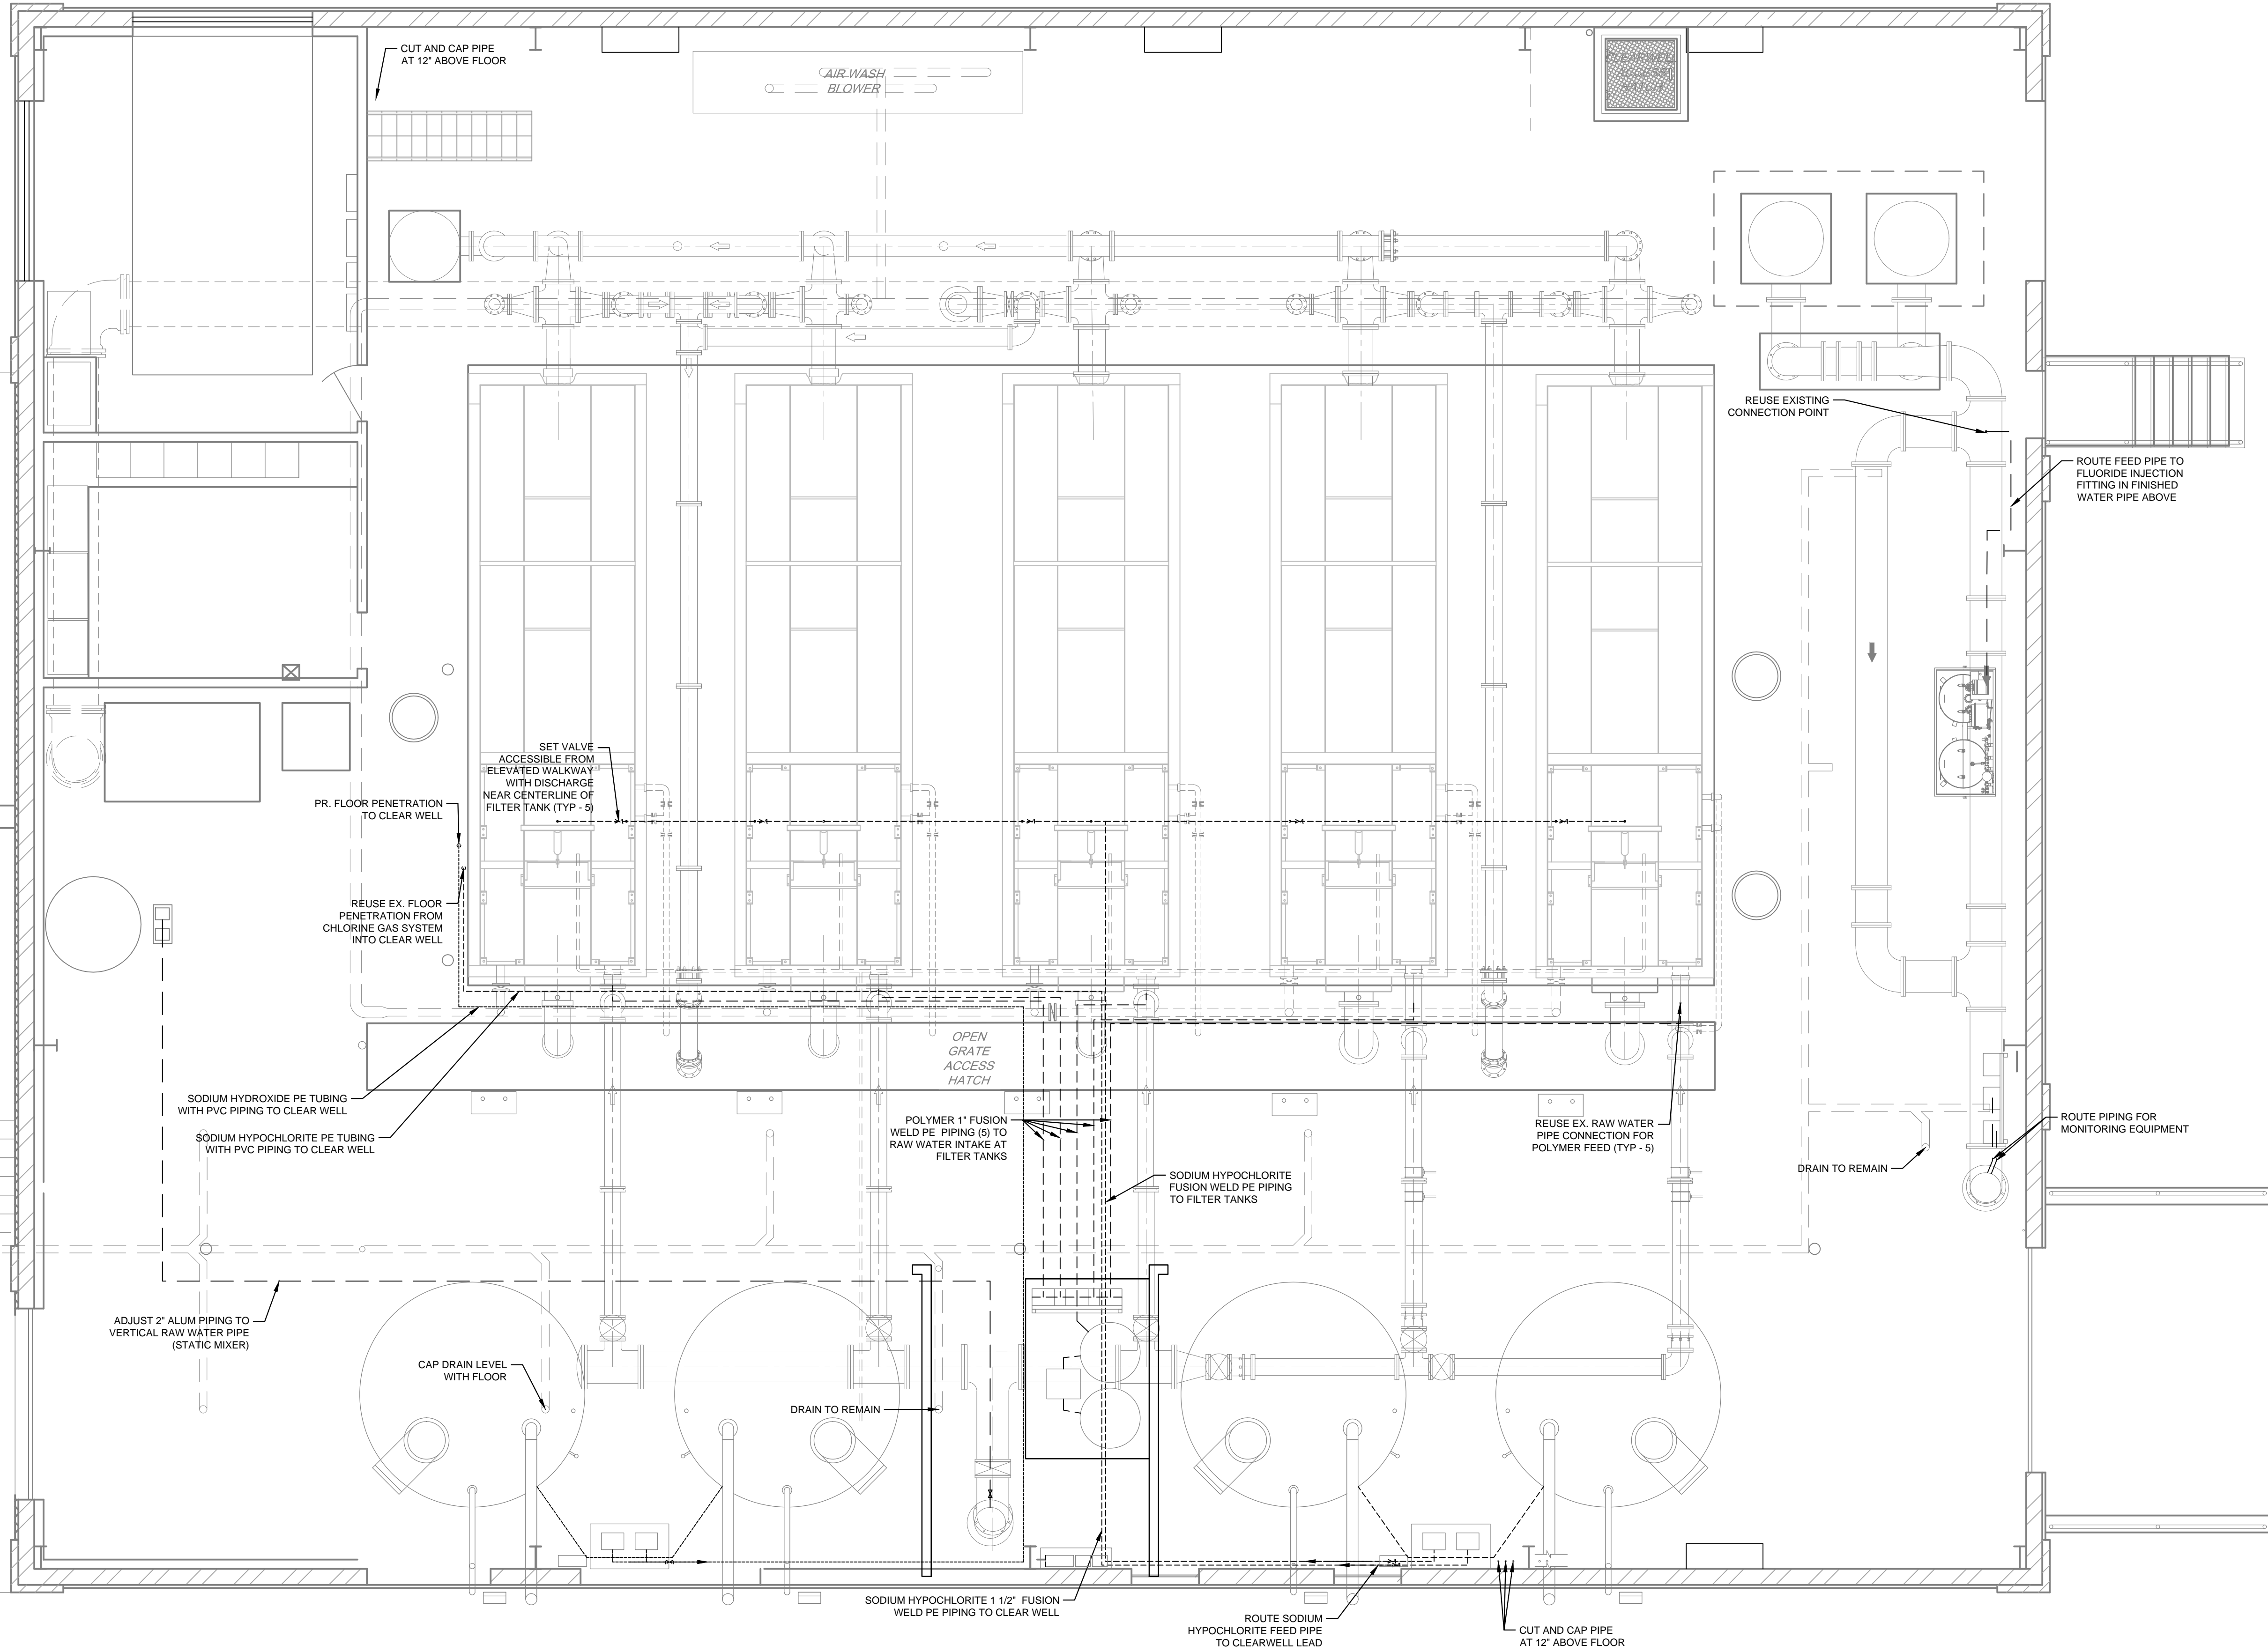


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CM1702
SHEET 49 OF 54

\\projects\cne\cnew1612\cnew1612.dwg: 2/16/2017 11:23 AM, BY: Brian Miller, PLOTTED: 4/20/2017 11:23 AM, PROJECT STATUS: CONSTRUCTION PLANS



CURTIS WATER TREATMENT PLANT
IMPROVEMENTS
215 PAPER MILL ROAD
NEWARK, DELAWARE

PIPE PAINTING AND LABELING PLAN

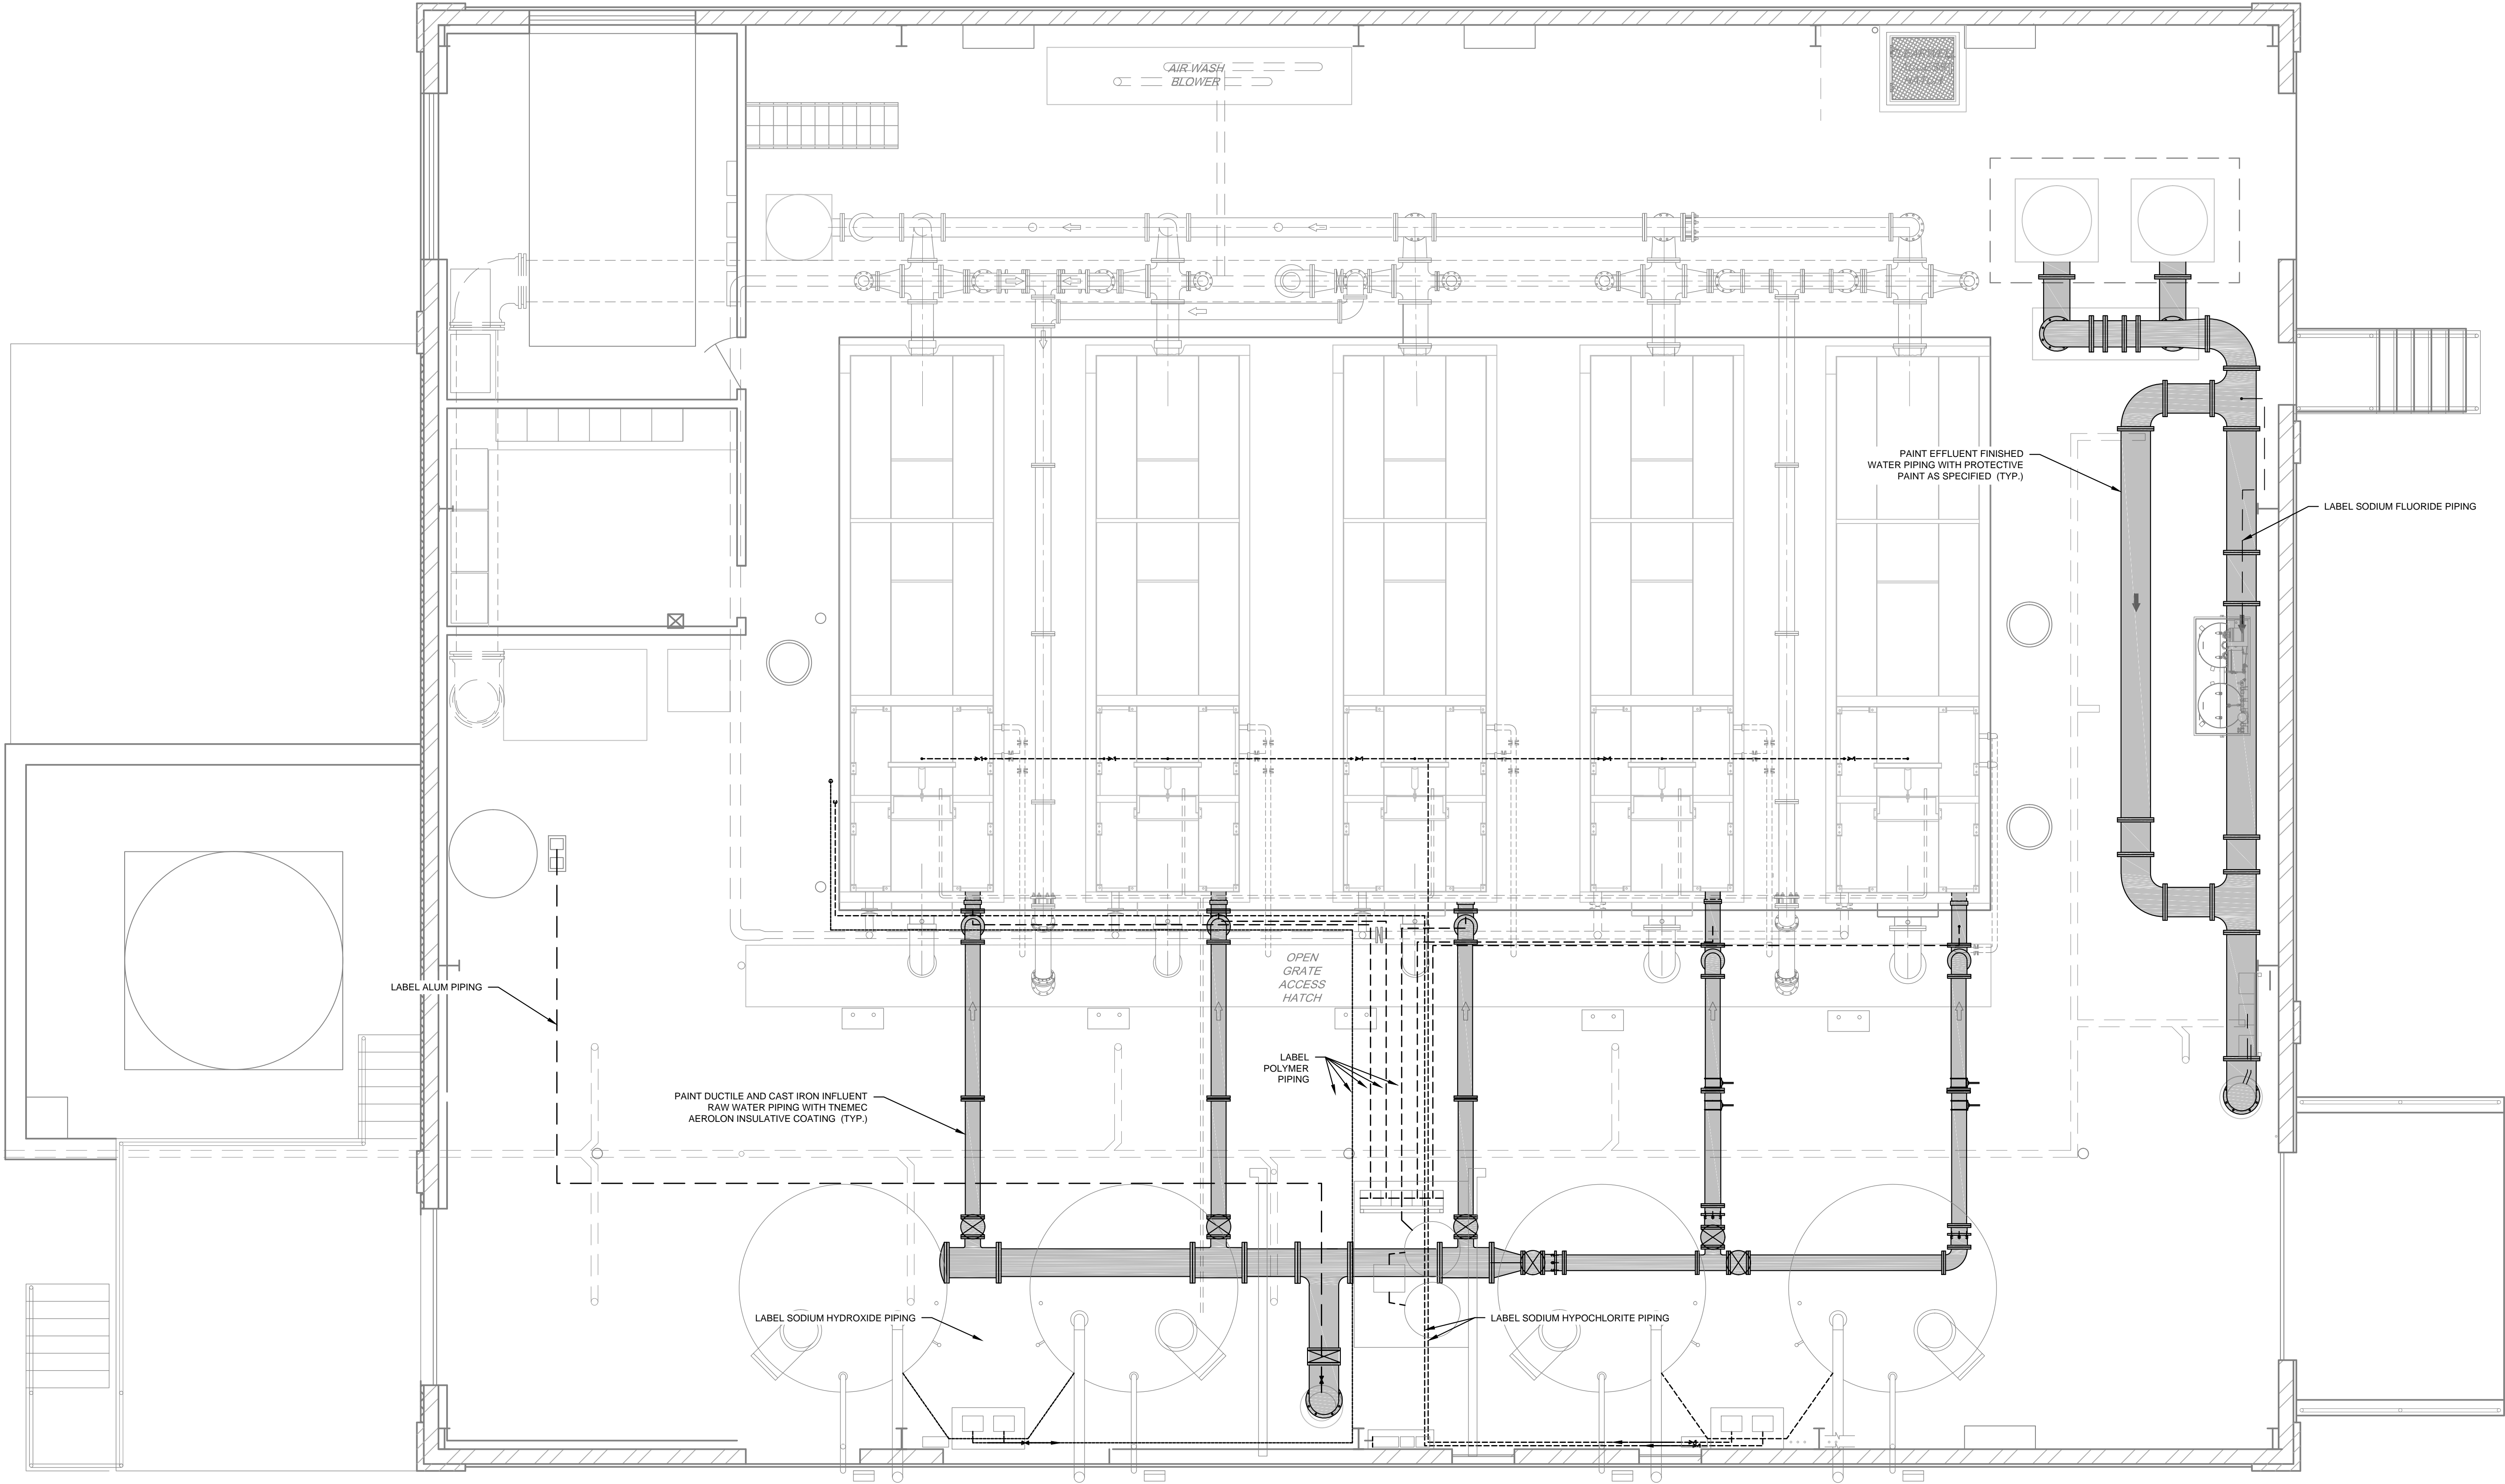CITY OF NEWARK DEPT. OF PUBLIC WORKS AND WATER RESOURCES
220 SOUTH MAIN STREET
NEWARK, DELAWARE 19711

NO.	DATE	REVISIONS	BY

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PROJECT CNEW1612
DATE APRIL 2017
DRAWING SCALE 1/4" = 1'-0"
DRAWN BY MWFB/BWM
APPROVED BY DPB

CM1703
SHEET 50 OF 54


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Pennoni
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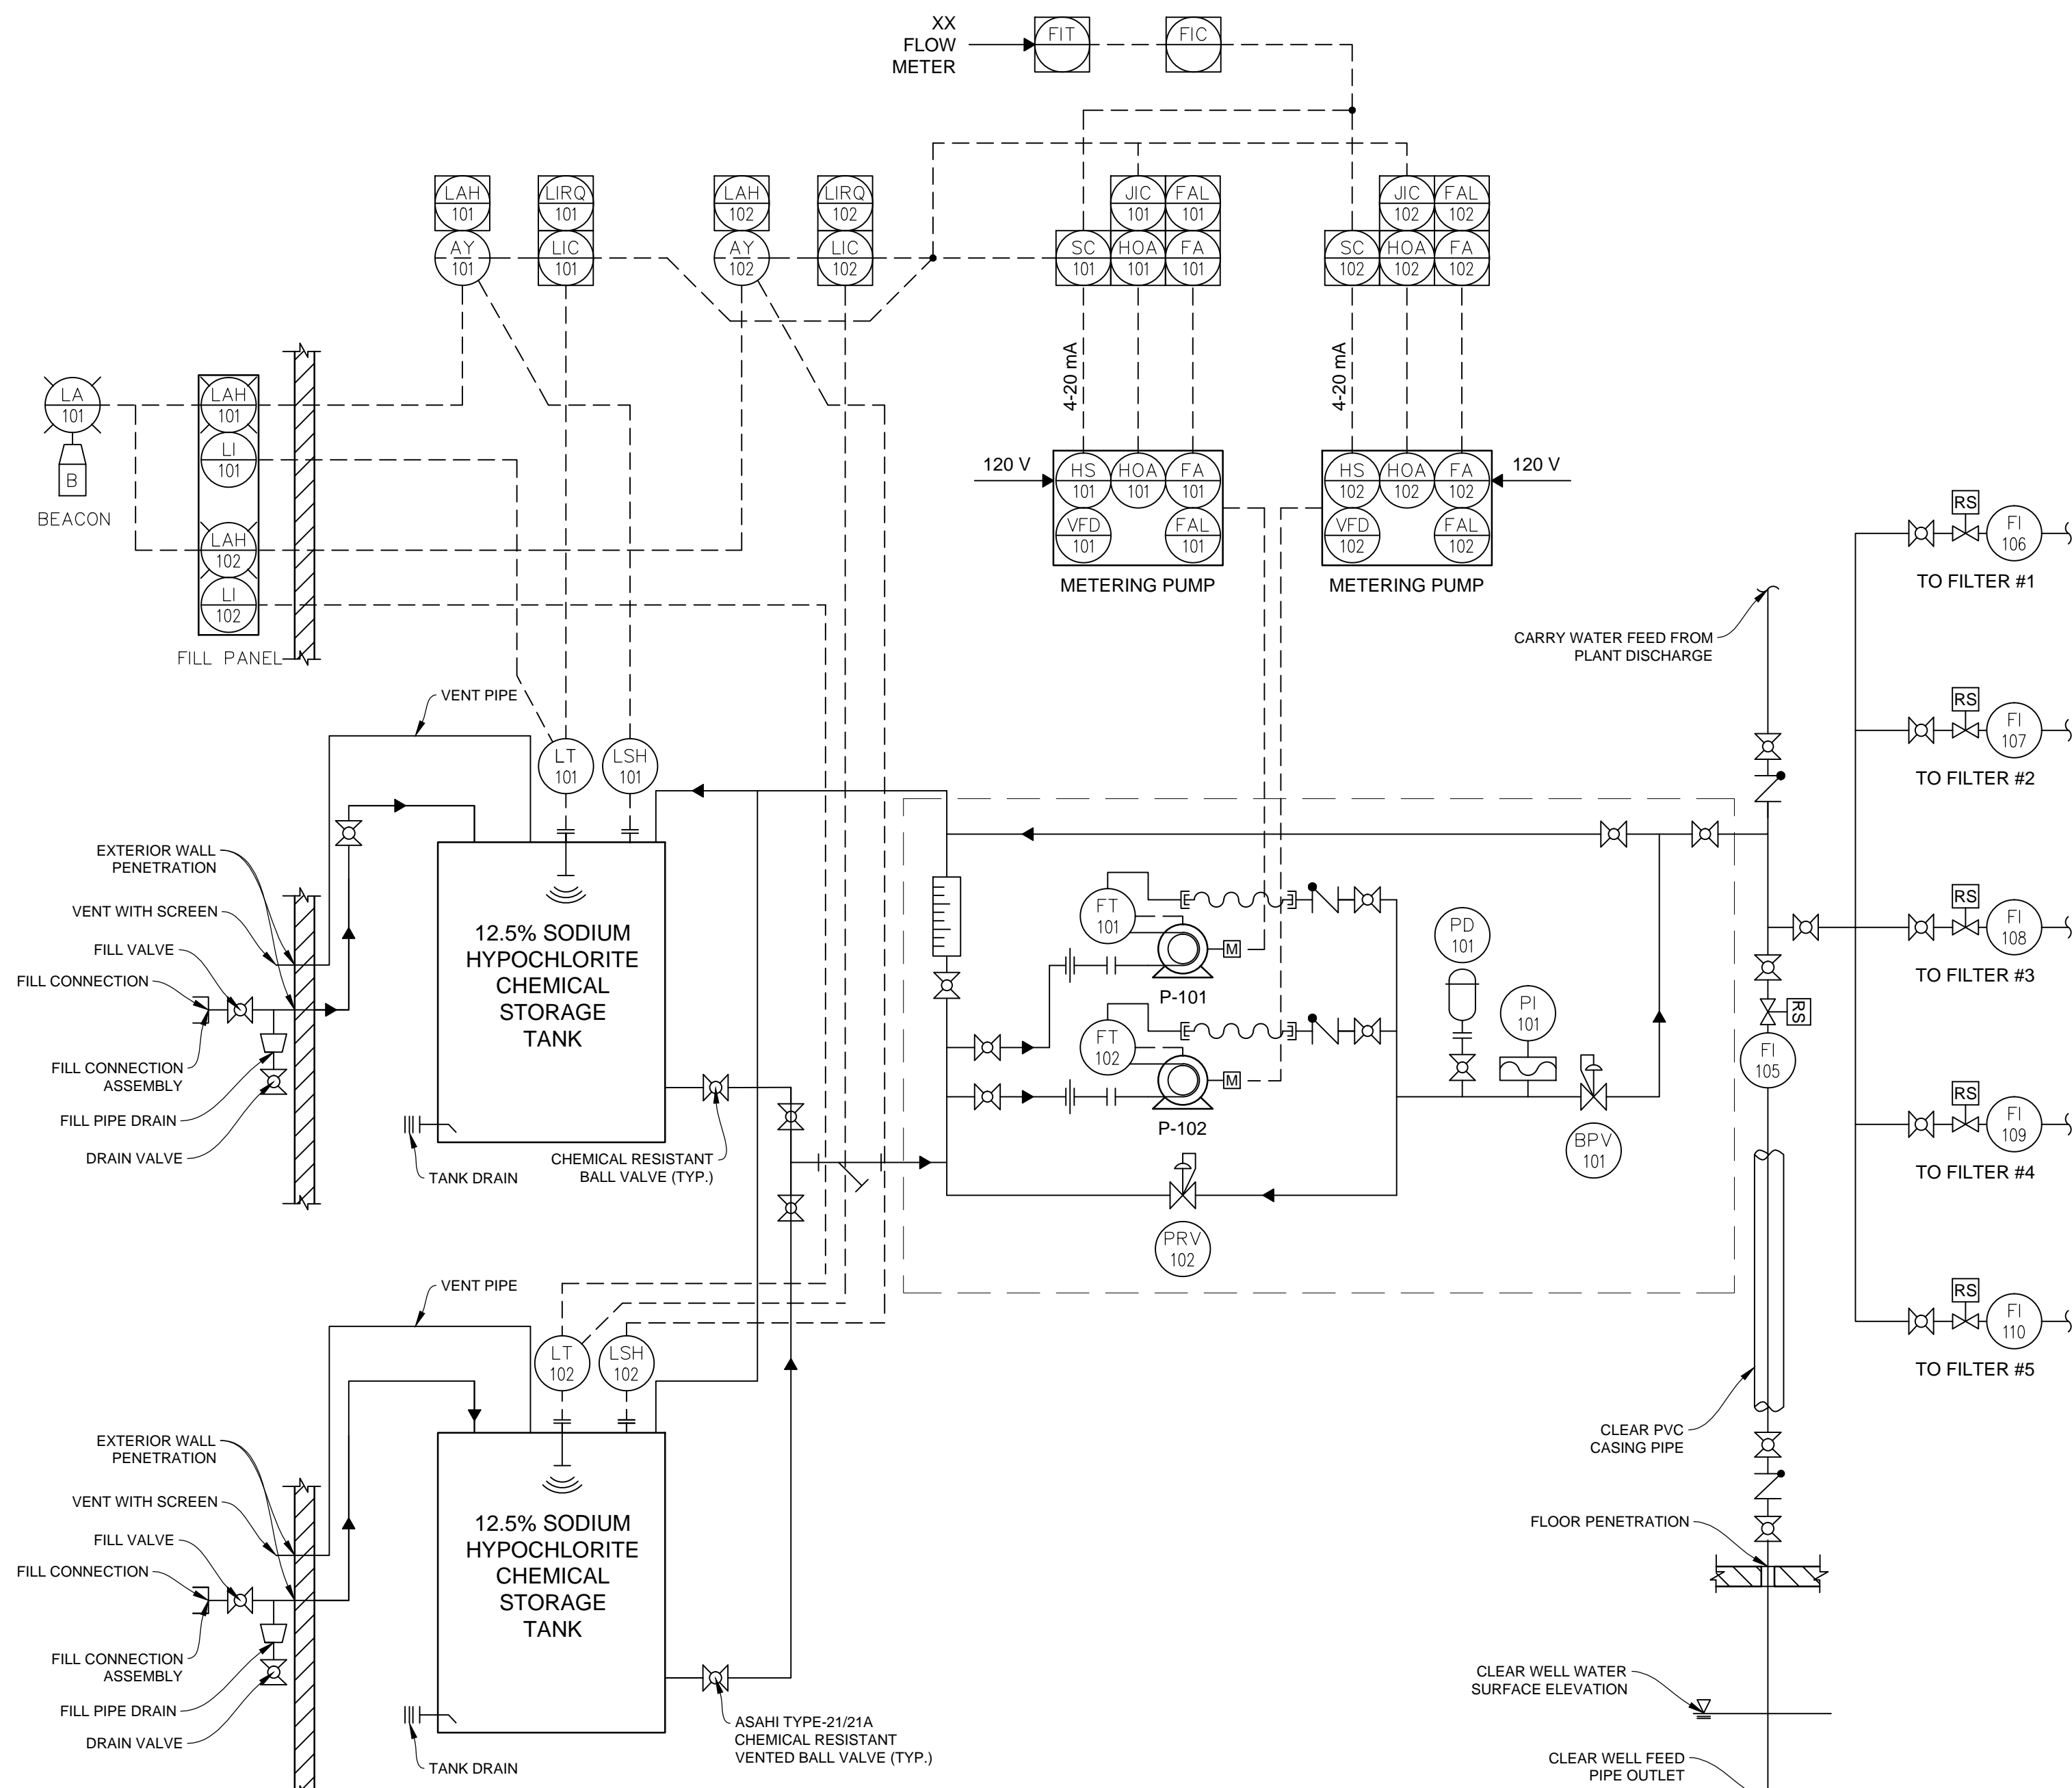
ENGINEER
BRIAN W. MILLER
NO. 16821
EXPIRATION DATE 12/31/17
PROFESSIONAL SEAL

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\\PROJECTS\CM6002\NEW1612\CM6002-WTP-Improvements\DESIGN_2\BIBS\CM6002.dwg PLOTED: 4/22/2017 3:29 PM BY: Brian Miller PLOTSTYLE: Pennon VCS.ctb PROJECT STATUS: CONSTRUCTION PLANS



CS1 SODIUM HYDROXIDE SYSTEM
NOT TO SCALE

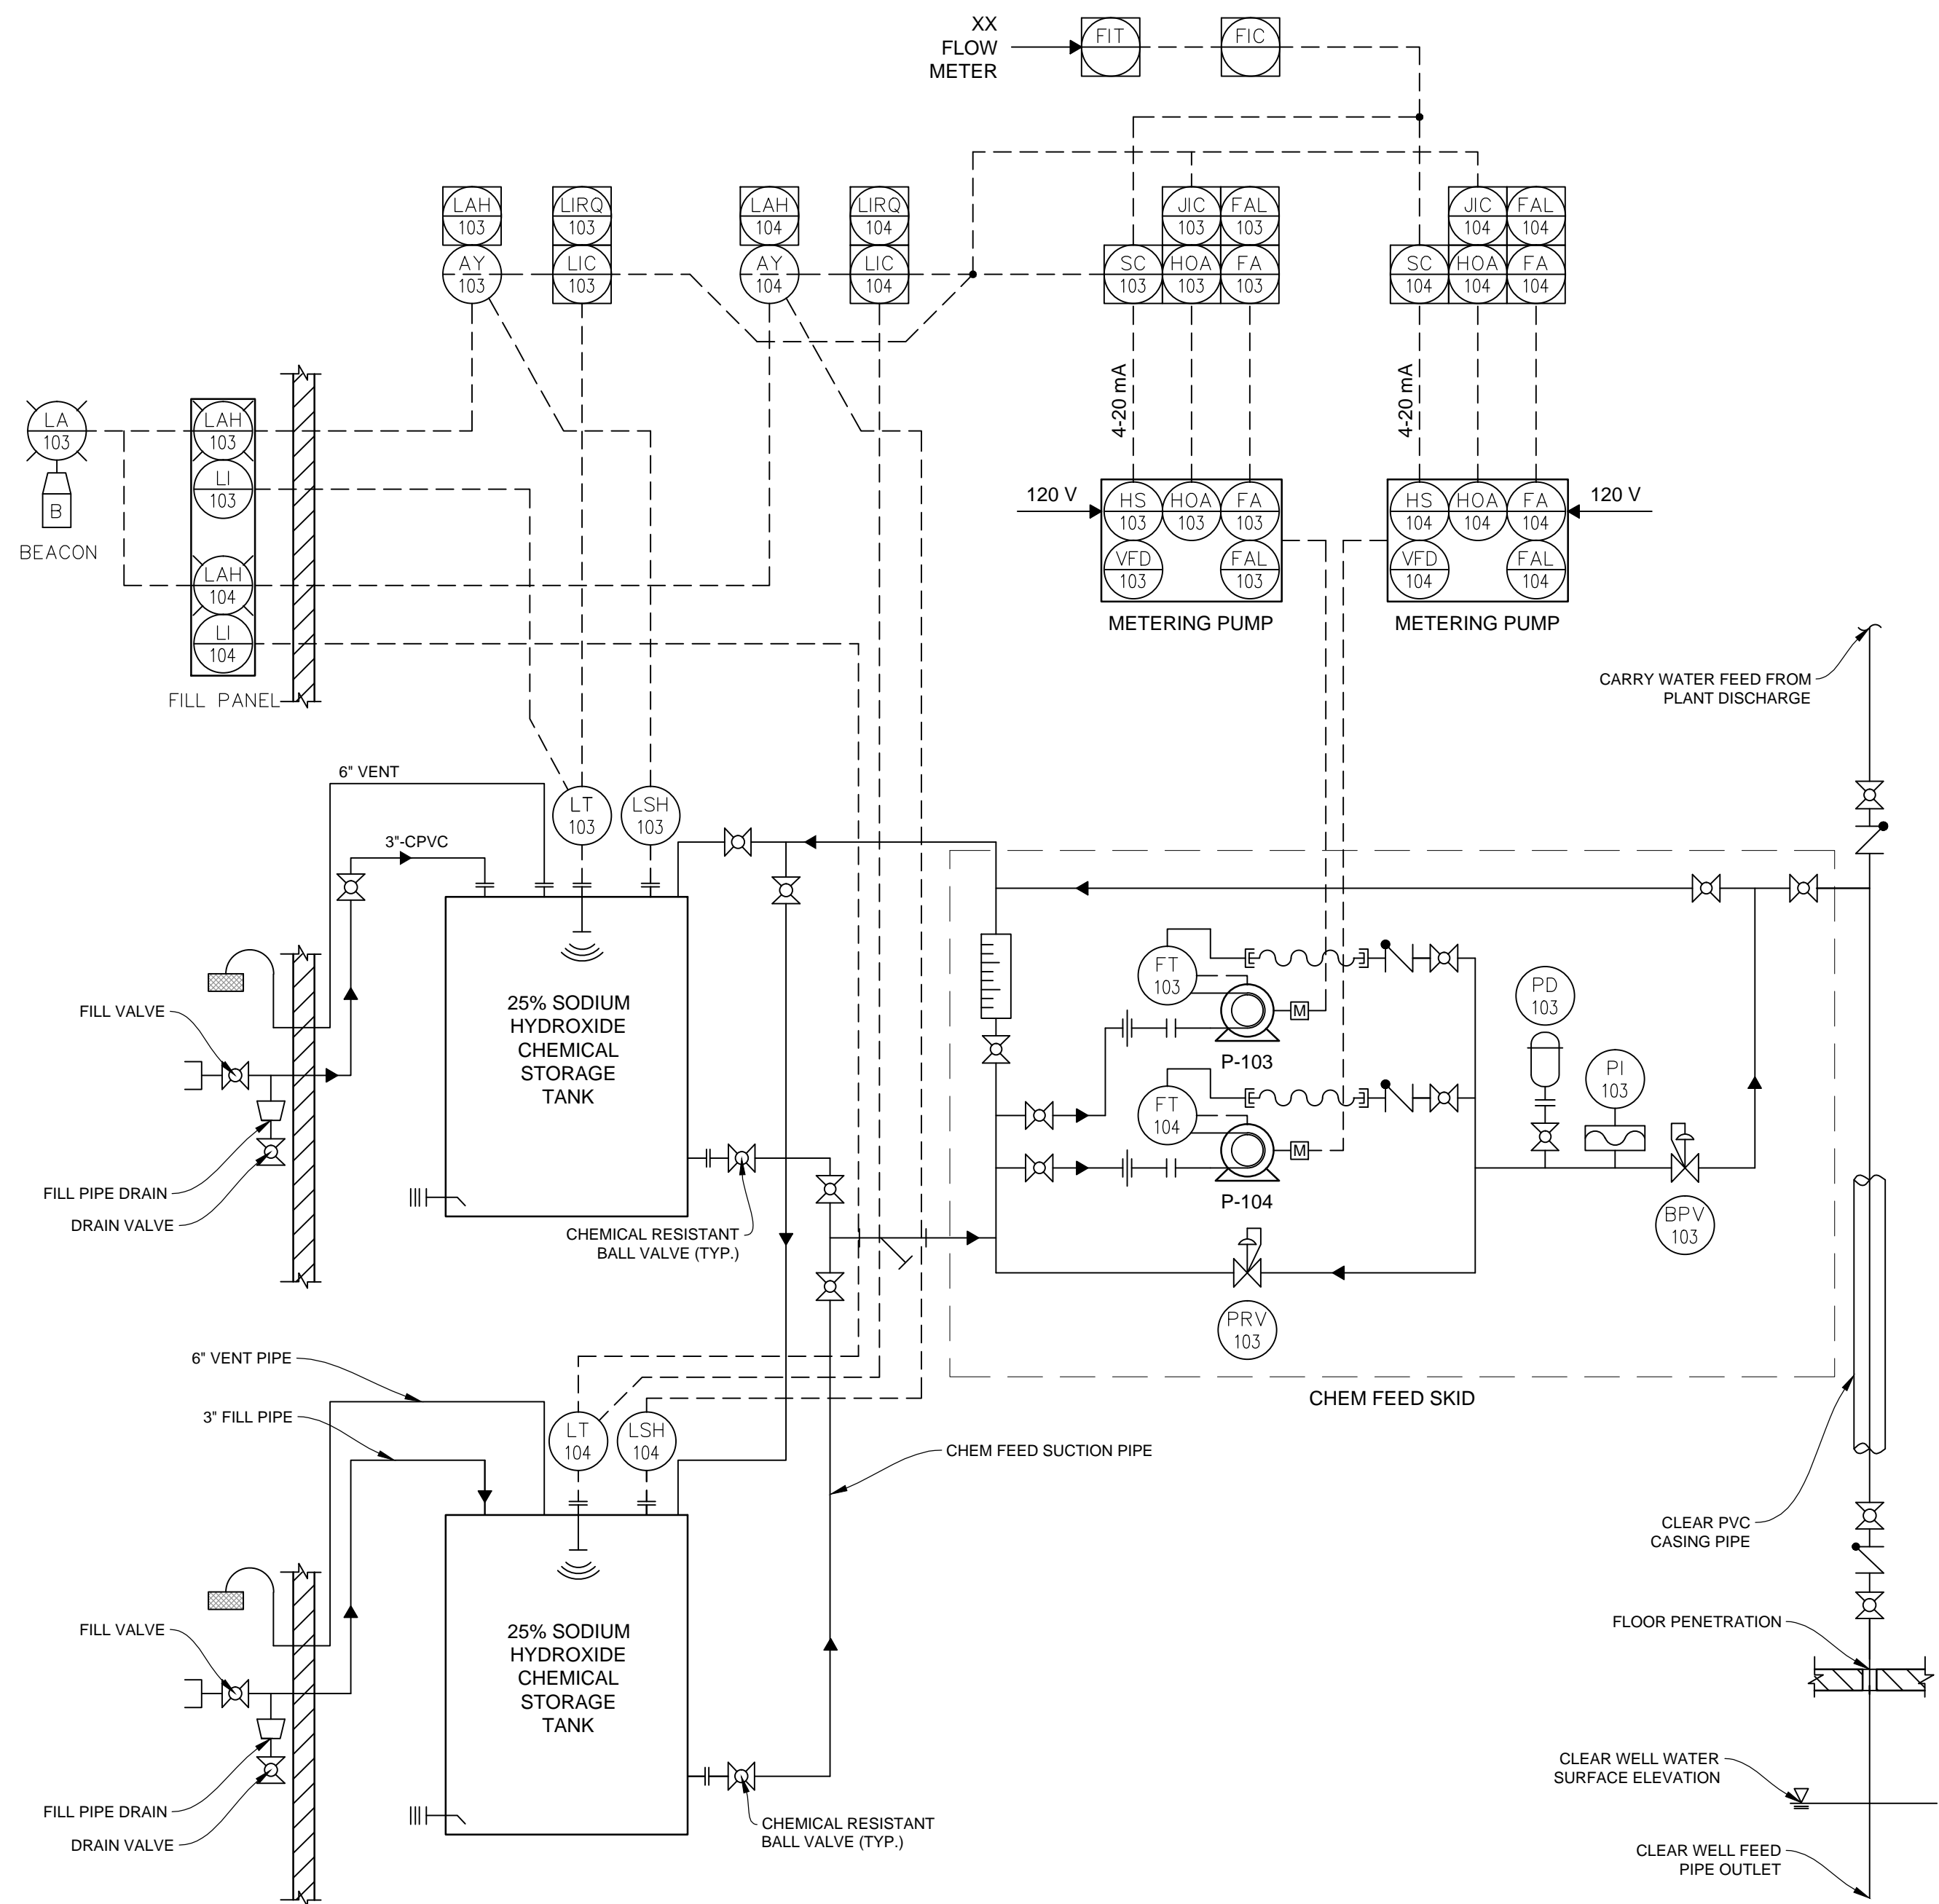

CS2 SODIUM HYPOCHLORITE SYSTEM
NOT TO SCALE

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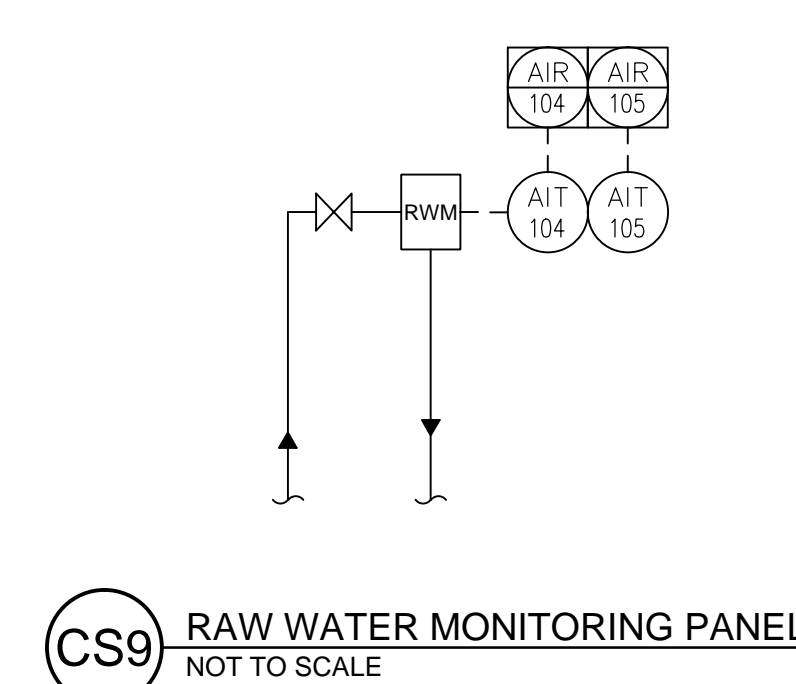
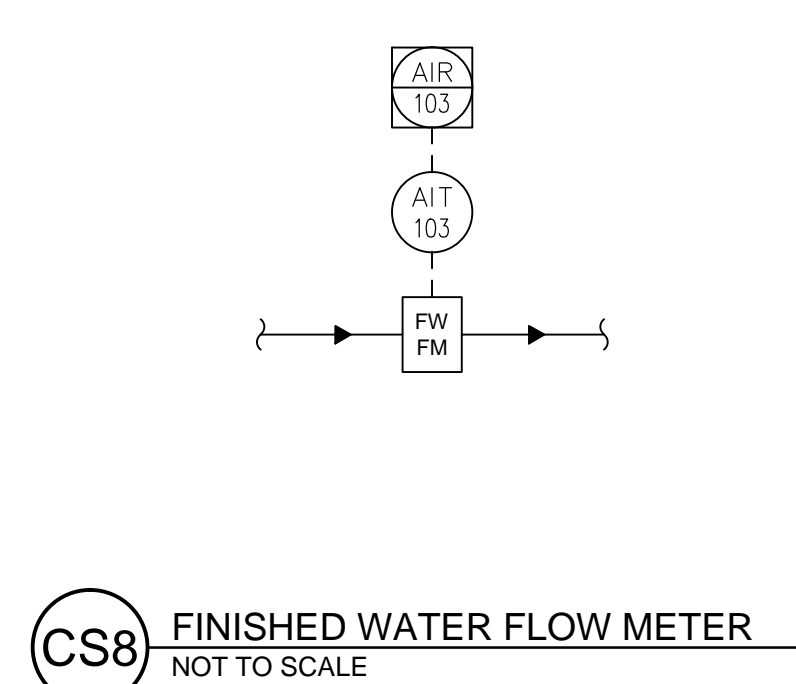
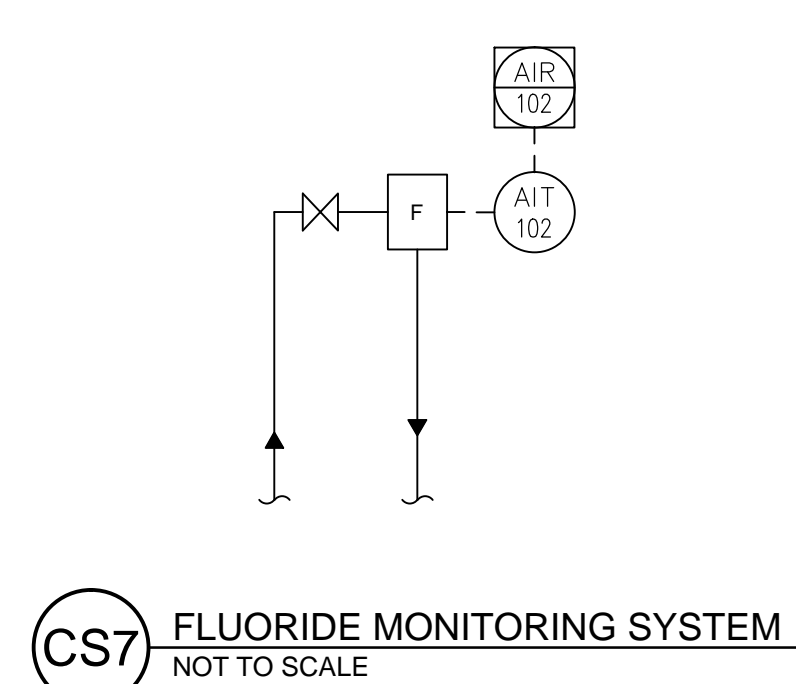
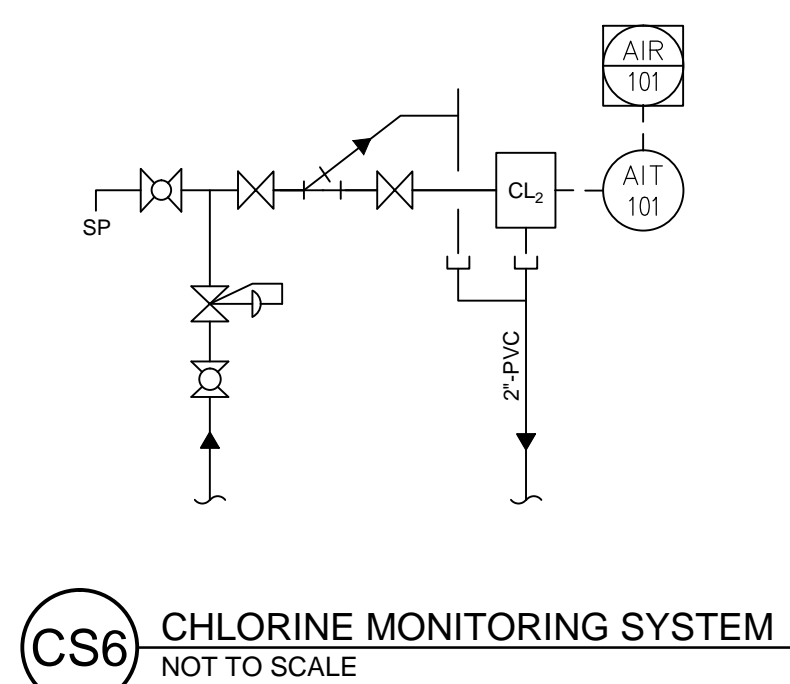
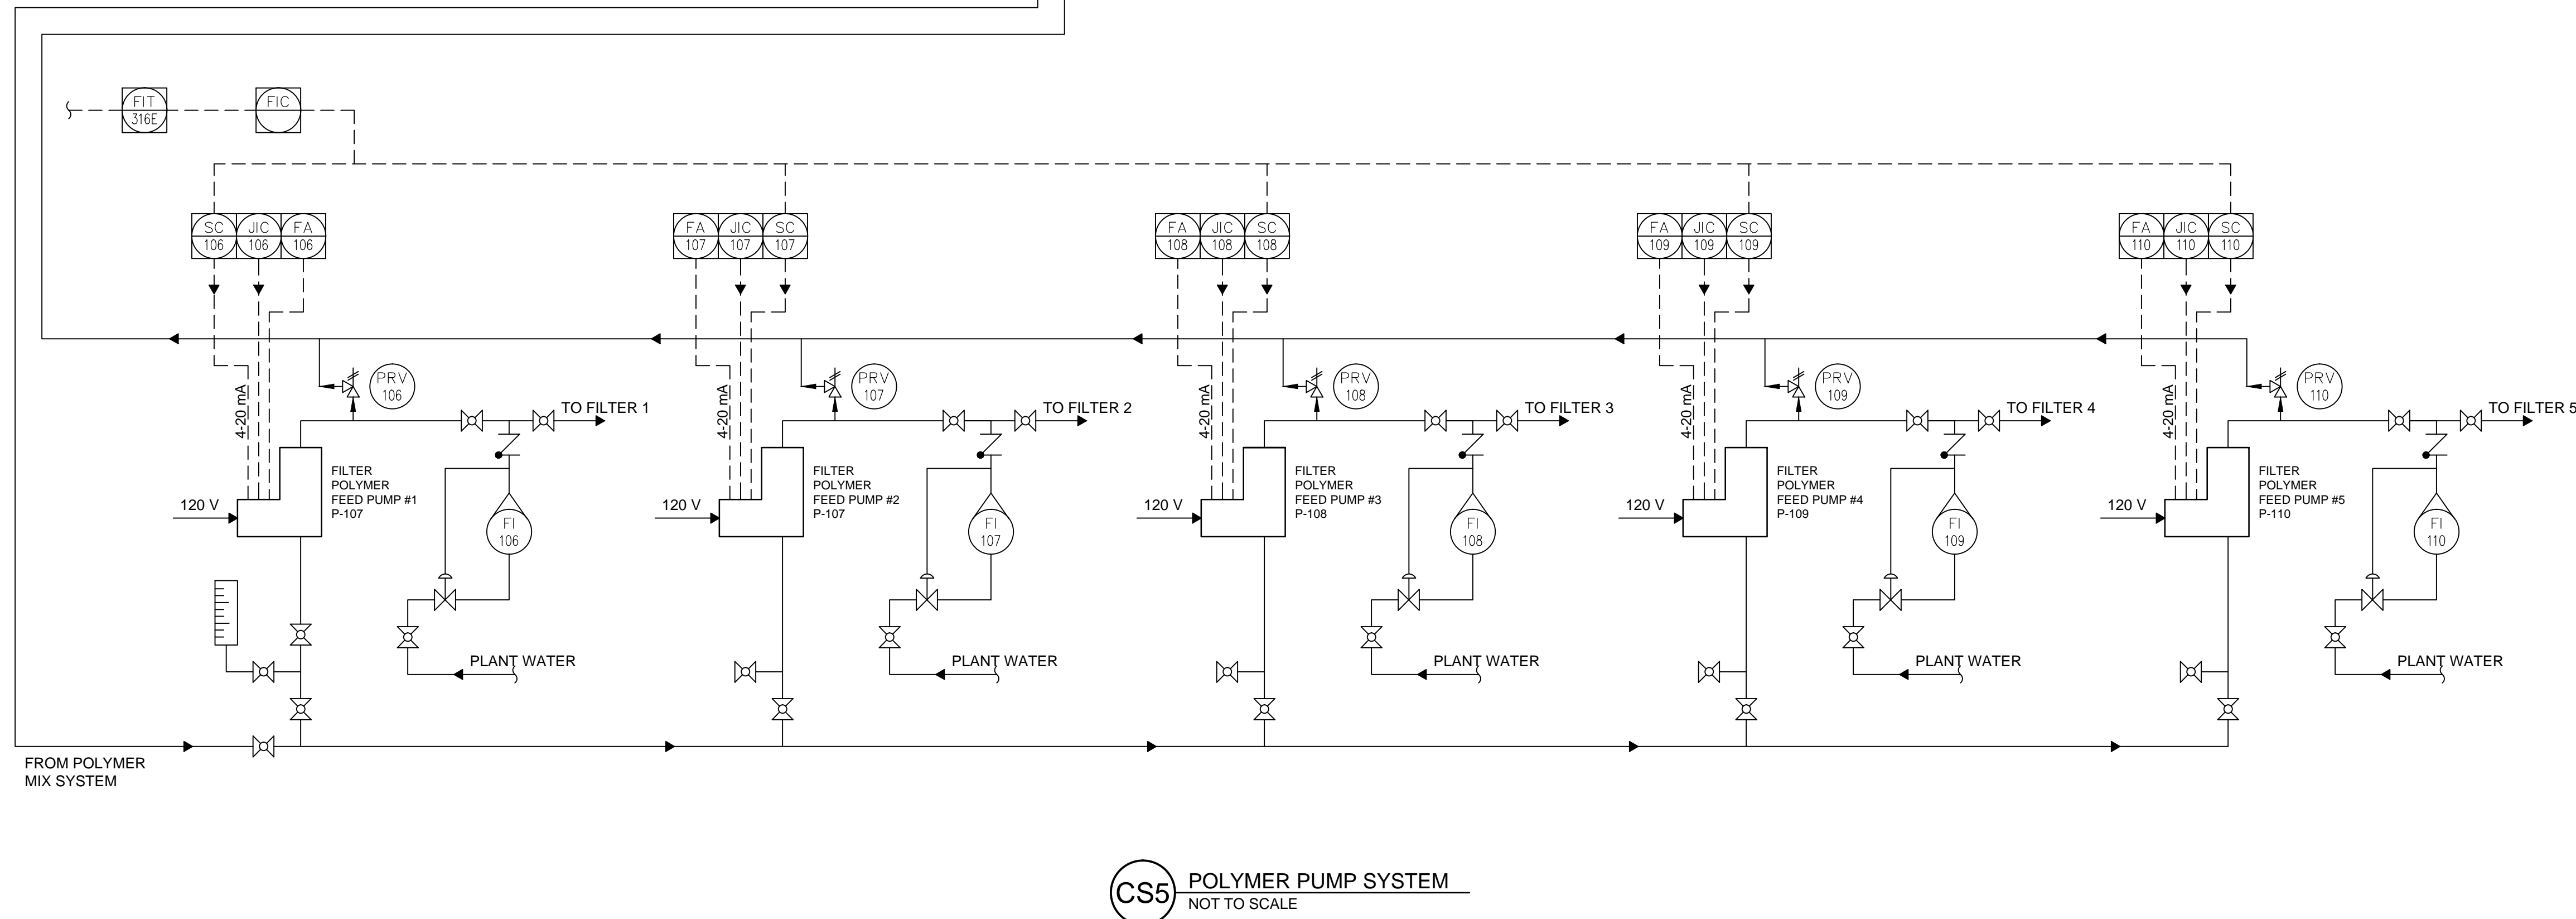
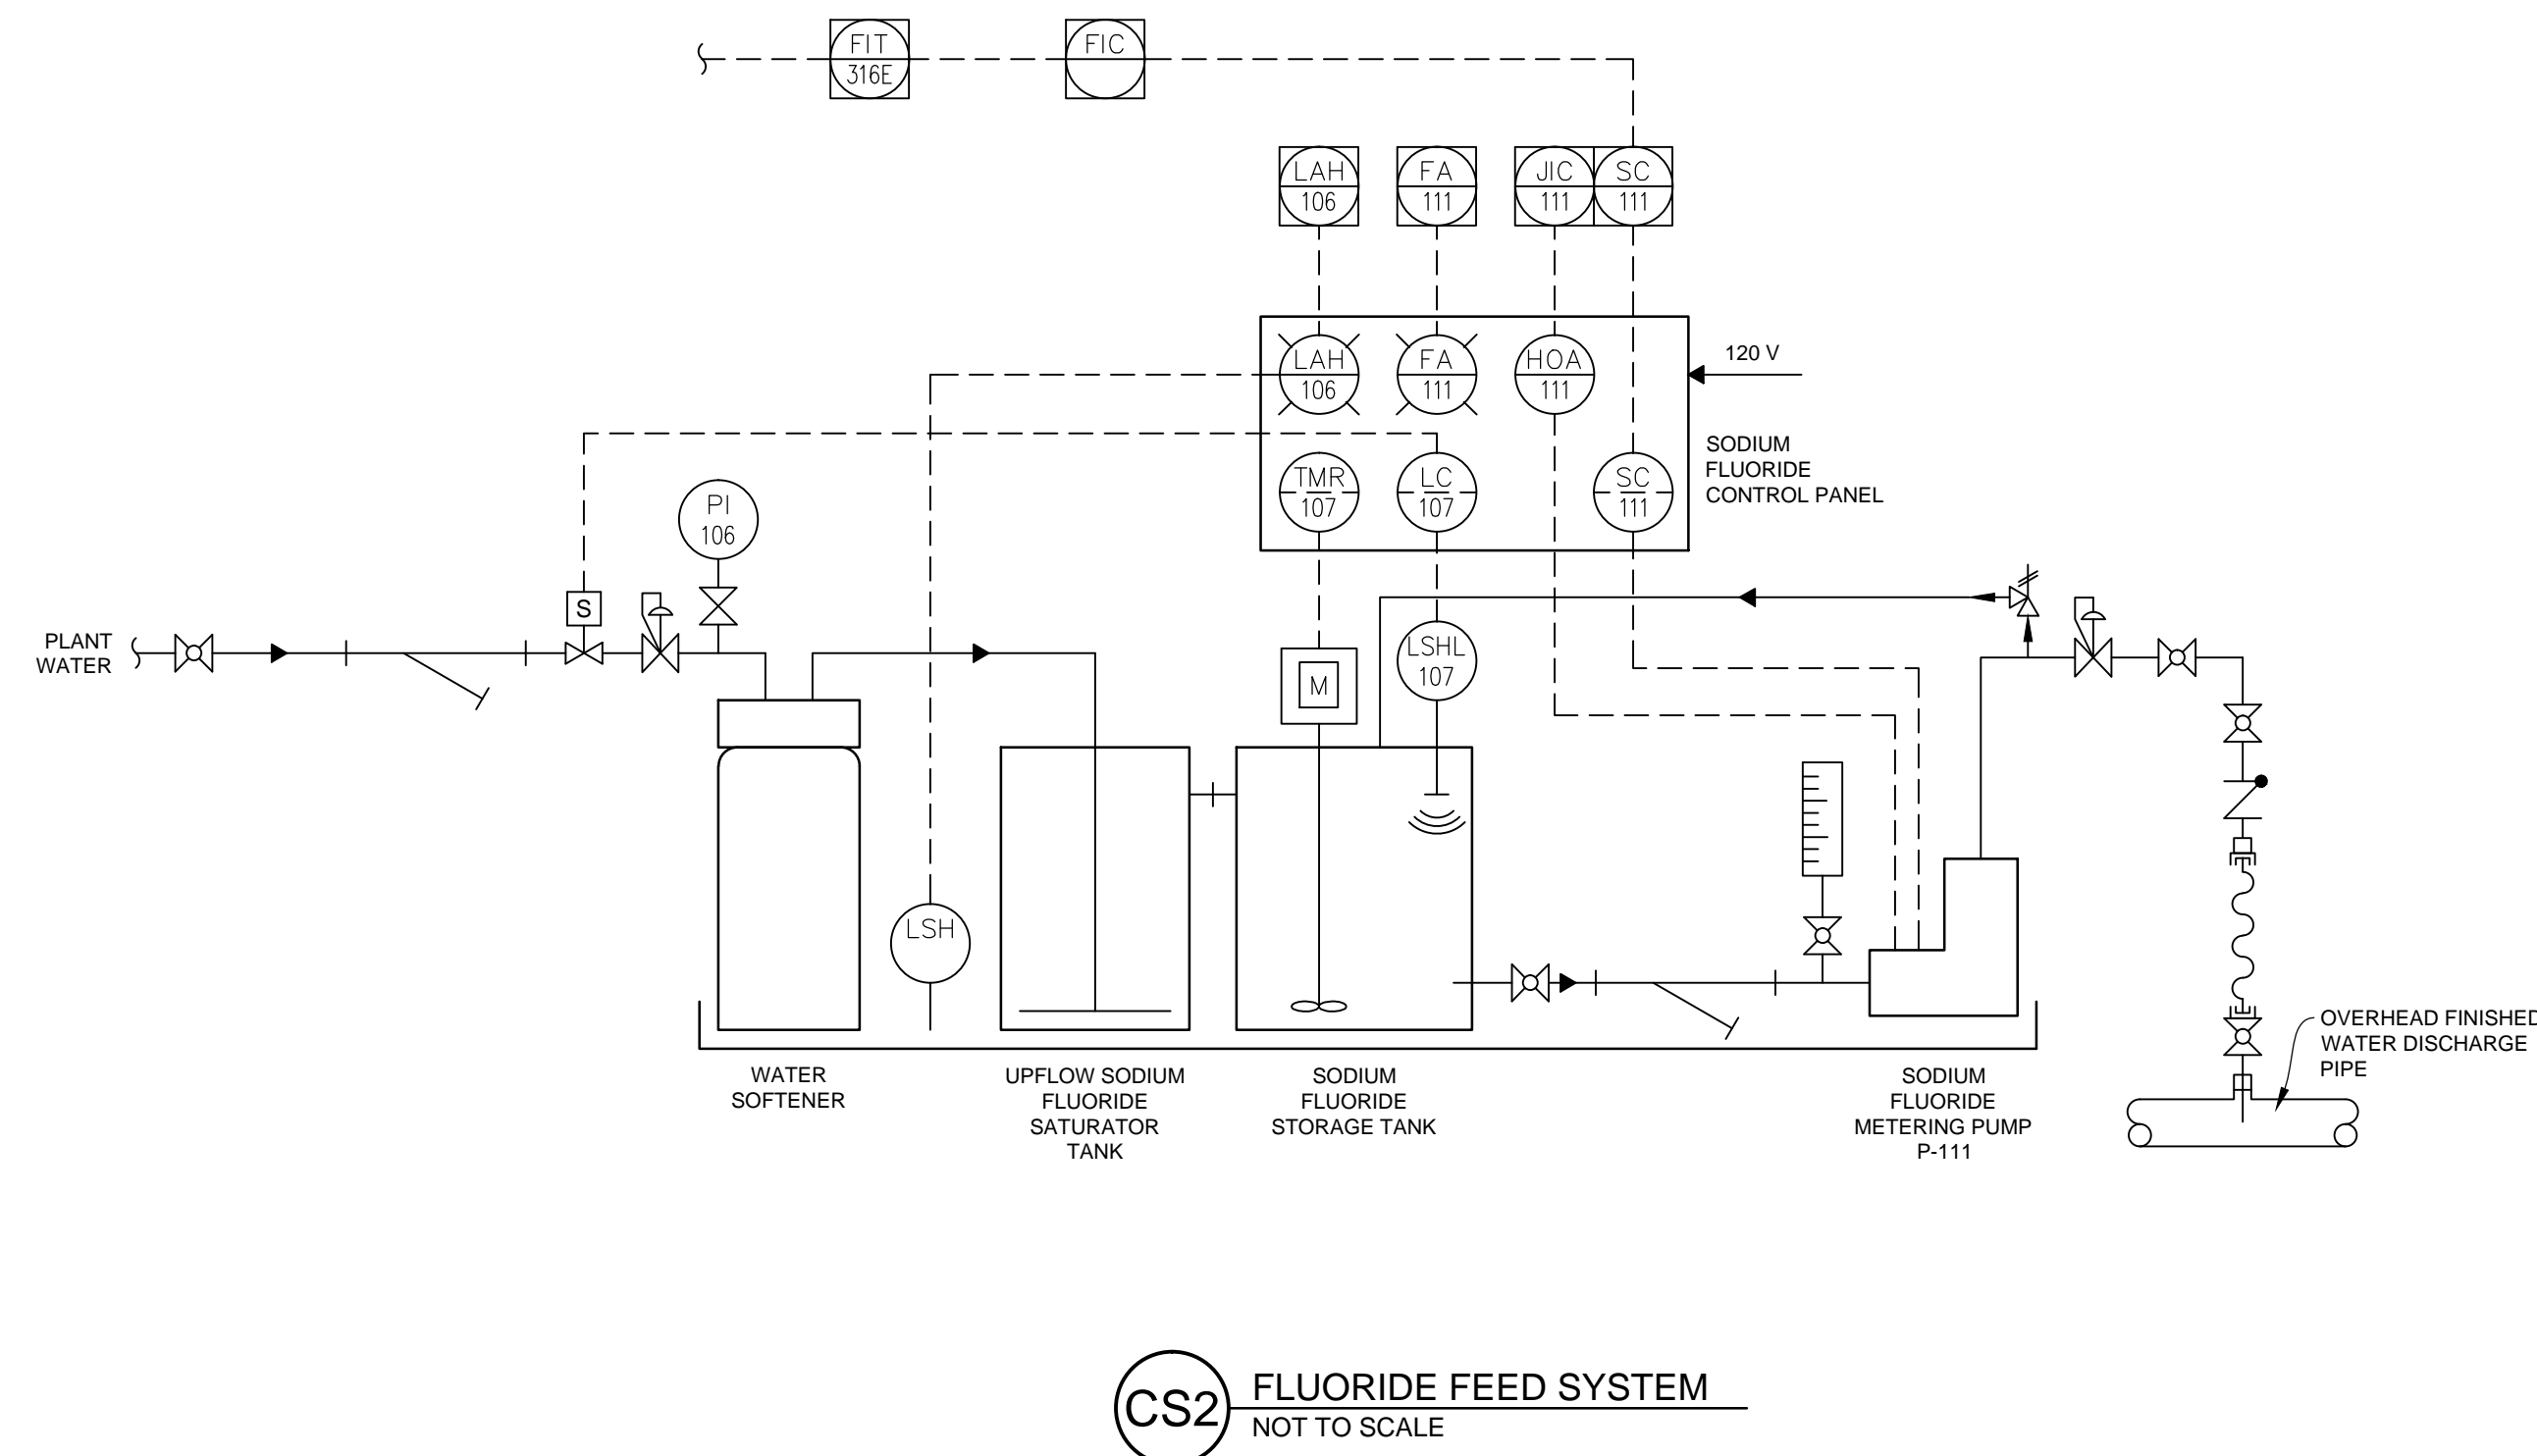
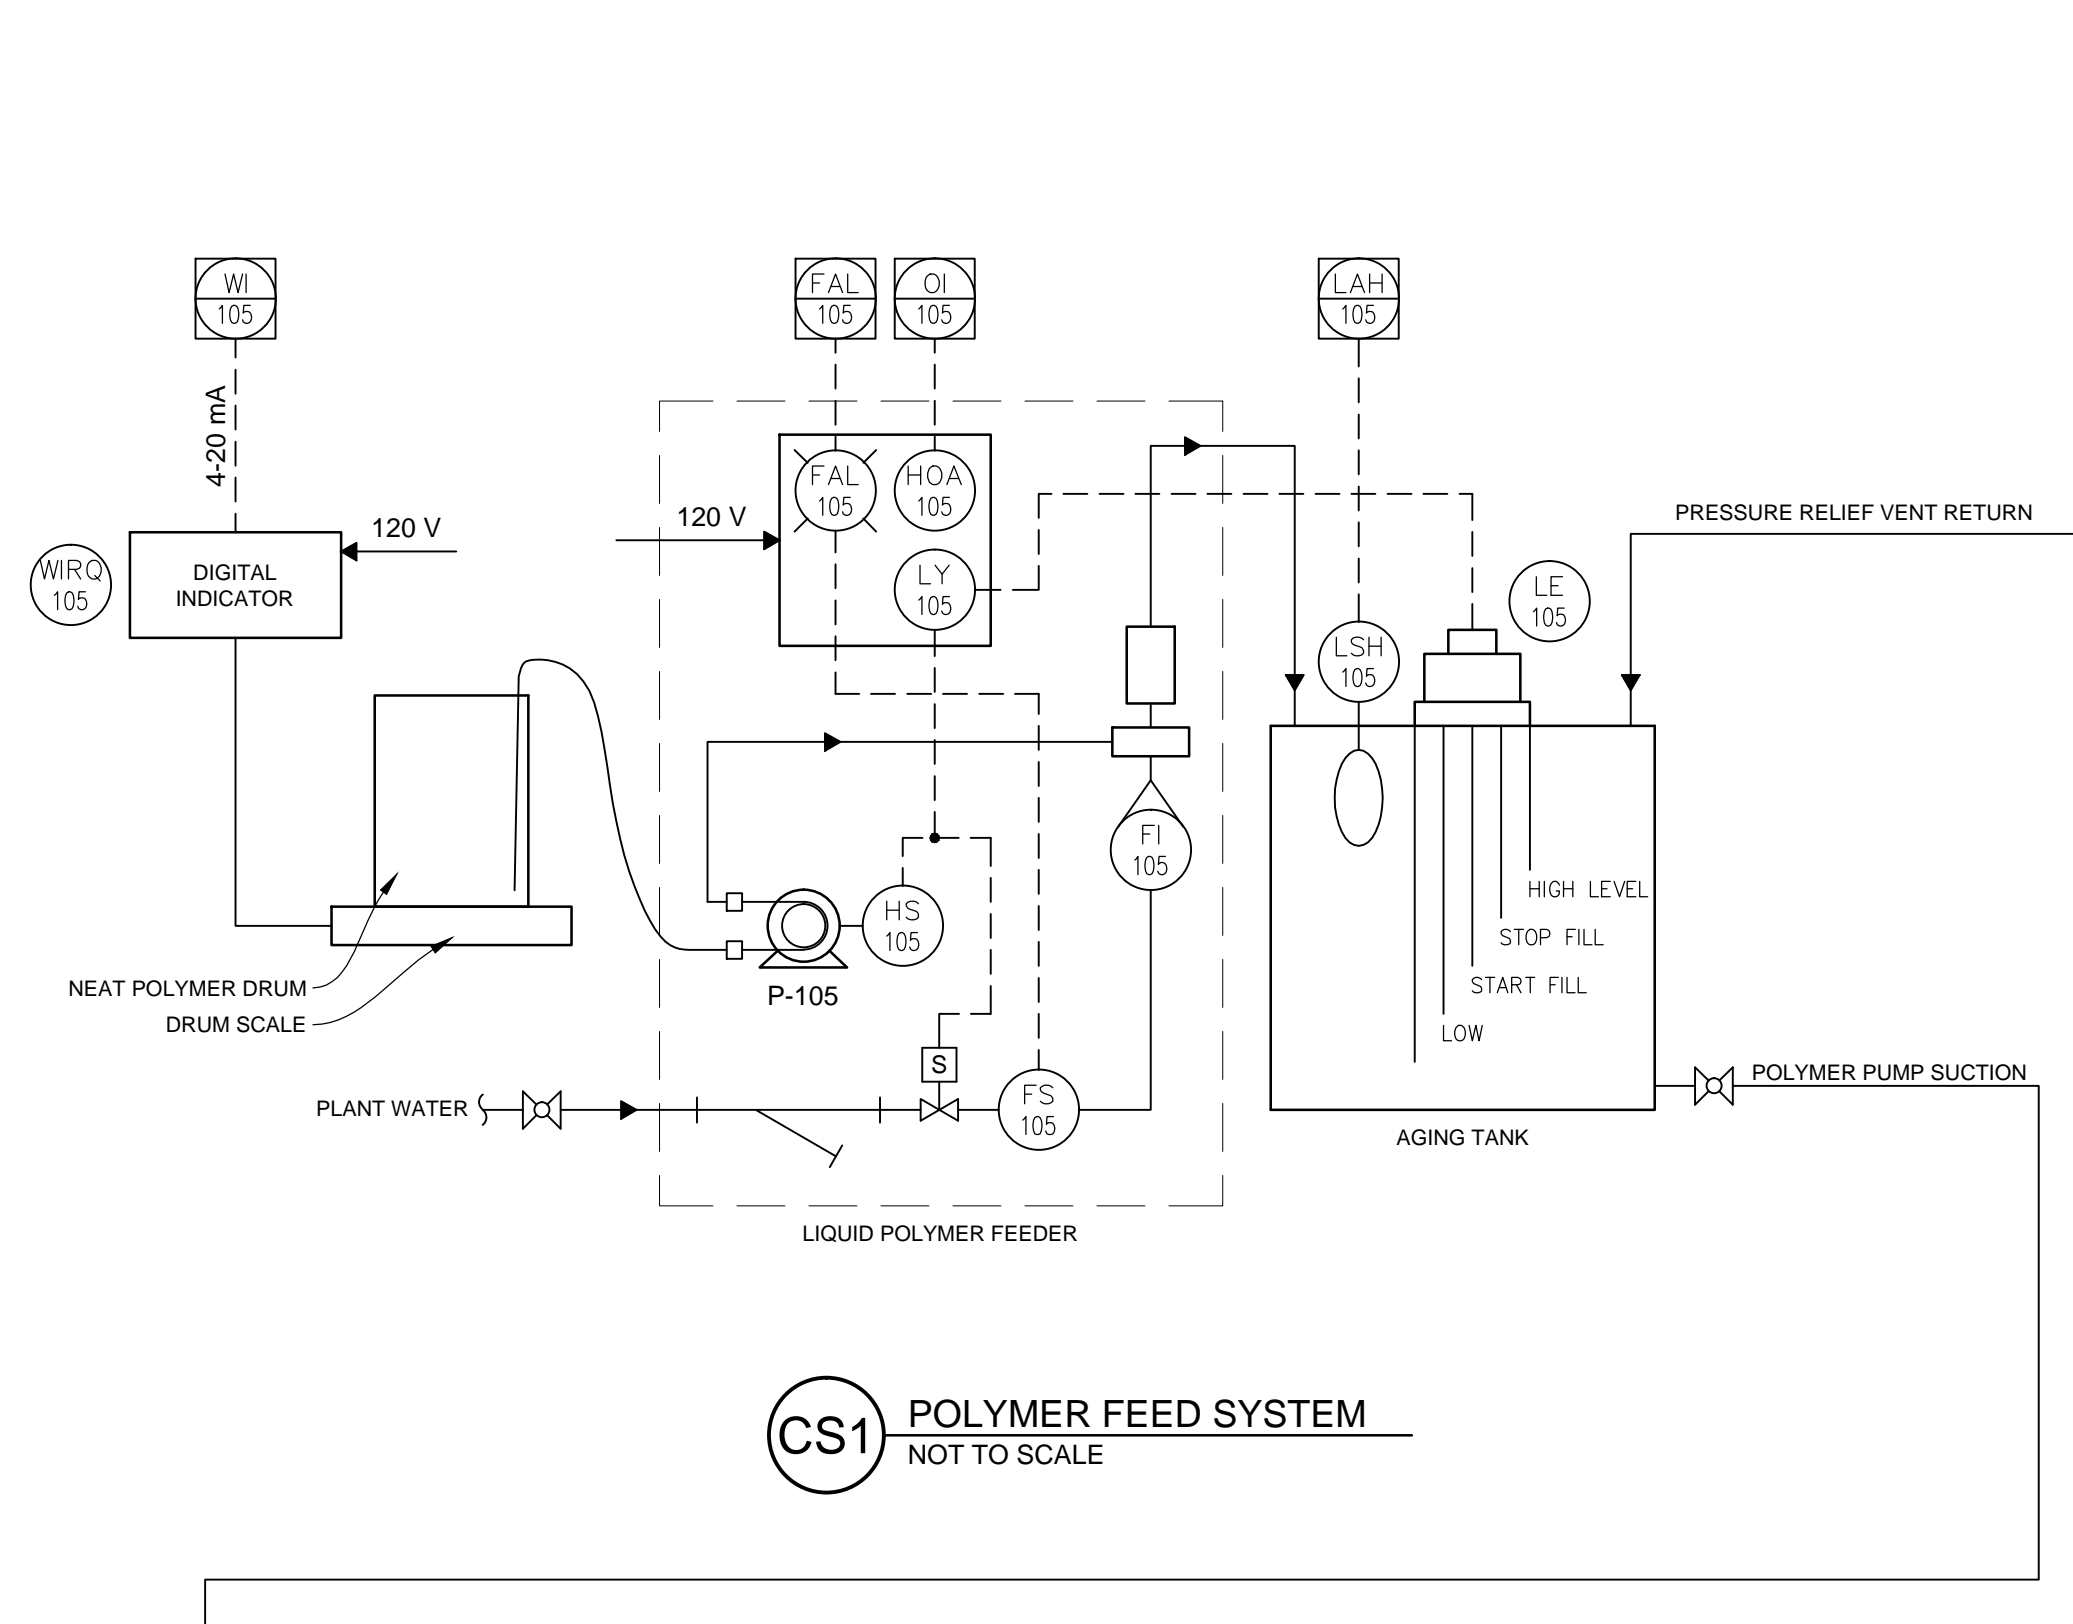
**CURTIS WATER TREATMENT PLANT
IMPROVEMENTS**
215 PAPER MILL ROAD
NEWARK, DELAWARE
CHEMICAL FEED SCHEMATICS
CITY OF NEWARK DEPT. OF PUBLIC WORKS AND WATER RESOURCES
220 SOUTH MAIN STREET
NEWARK, DELAWARE 19711

NO.	DATE	REVISIONS	BY

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PROJECT	CNEW1612
DATE	APRIL 2017
DRAWING SCALE	AS SHOWN
DRAWN BY	MWF/BWM
APPROVED BY	DPB

CM6002
SHEET 52 OF 54




- | SYMBOLS LEGEND | |
|----------------|-----------------------------------|
| | SHARED DISPLAY/
SHARED CONTROL |
| | INDICATOR LIGHT |
| | LOCALLY MOUNTED DISPLAY |
| | BACK PANEL MOUNTED |
| | FLANGE JOINT |
| | UNION JOINT |
| | FLEXIBLE HOSE |
| | BALL VALVE |
| | GATE VALVE |
| | CHECK VALVE |
| | _ VALVE |
| | PRESSURE
REGULATING VALVE |
| | PRESSURE
REDUCER VALVE |
| | RATE SET VALVE |
| | SOLENOID VALVE |
| | PRESSURE RELIEF
SAFETY VALVE |
| | GAUGE ISOLATOR |
| | DRAIN WITH BLIND FLANGE |
| | FILL CONNECTION ASSEMBLY |
| | "Y" STRAINER |
| | VENT WITH SCREEN |
| | CALIBRATION COLUMN |
| | ULTRASONIC LEVEL |
| | MIXER |
| | METERING PUMP |
| | PERISTALTIC METERING PUMP |
| | PULSATION DAMPENERS |
| | BUILDING WALL |
| | BUILDING FLOOR |

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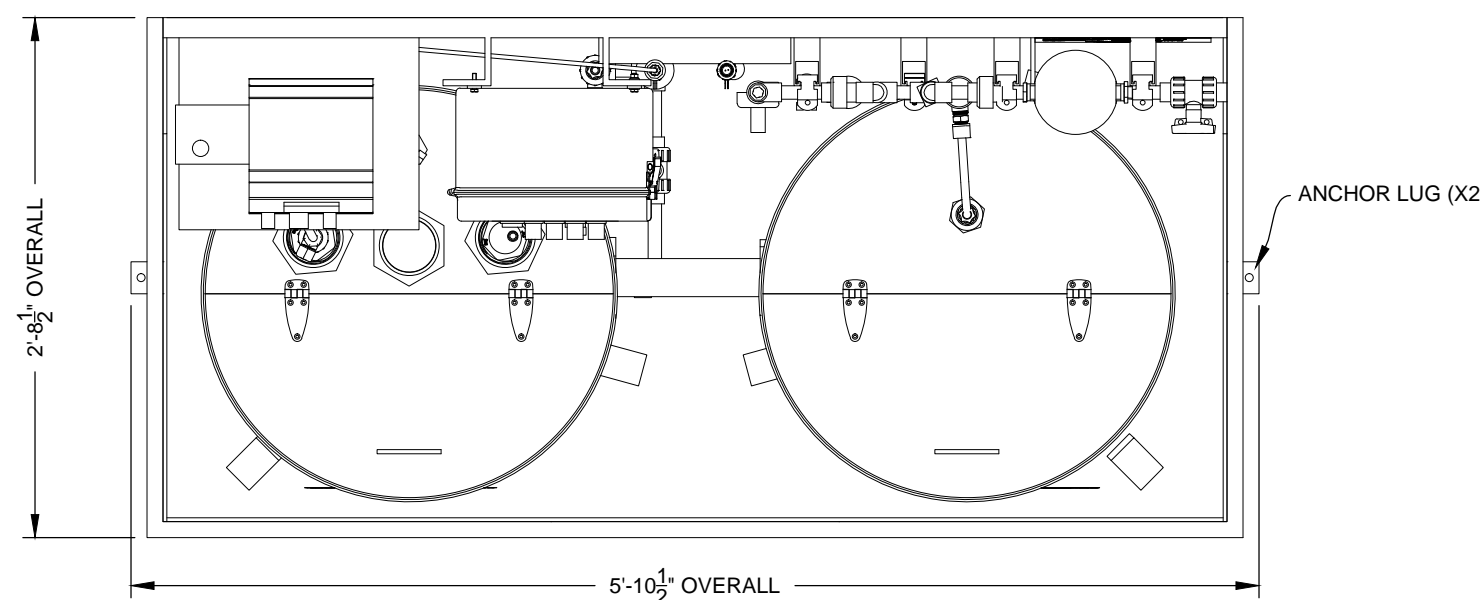
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PROJECT	CNEW1612
DATE	APRIL 2017
DRAWING SCALE	AS SHOWN
DRAWN BY	MWF/BWM
APPROVED BY	DPB


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ISOMETRIC VIEW




PLAN VIEW

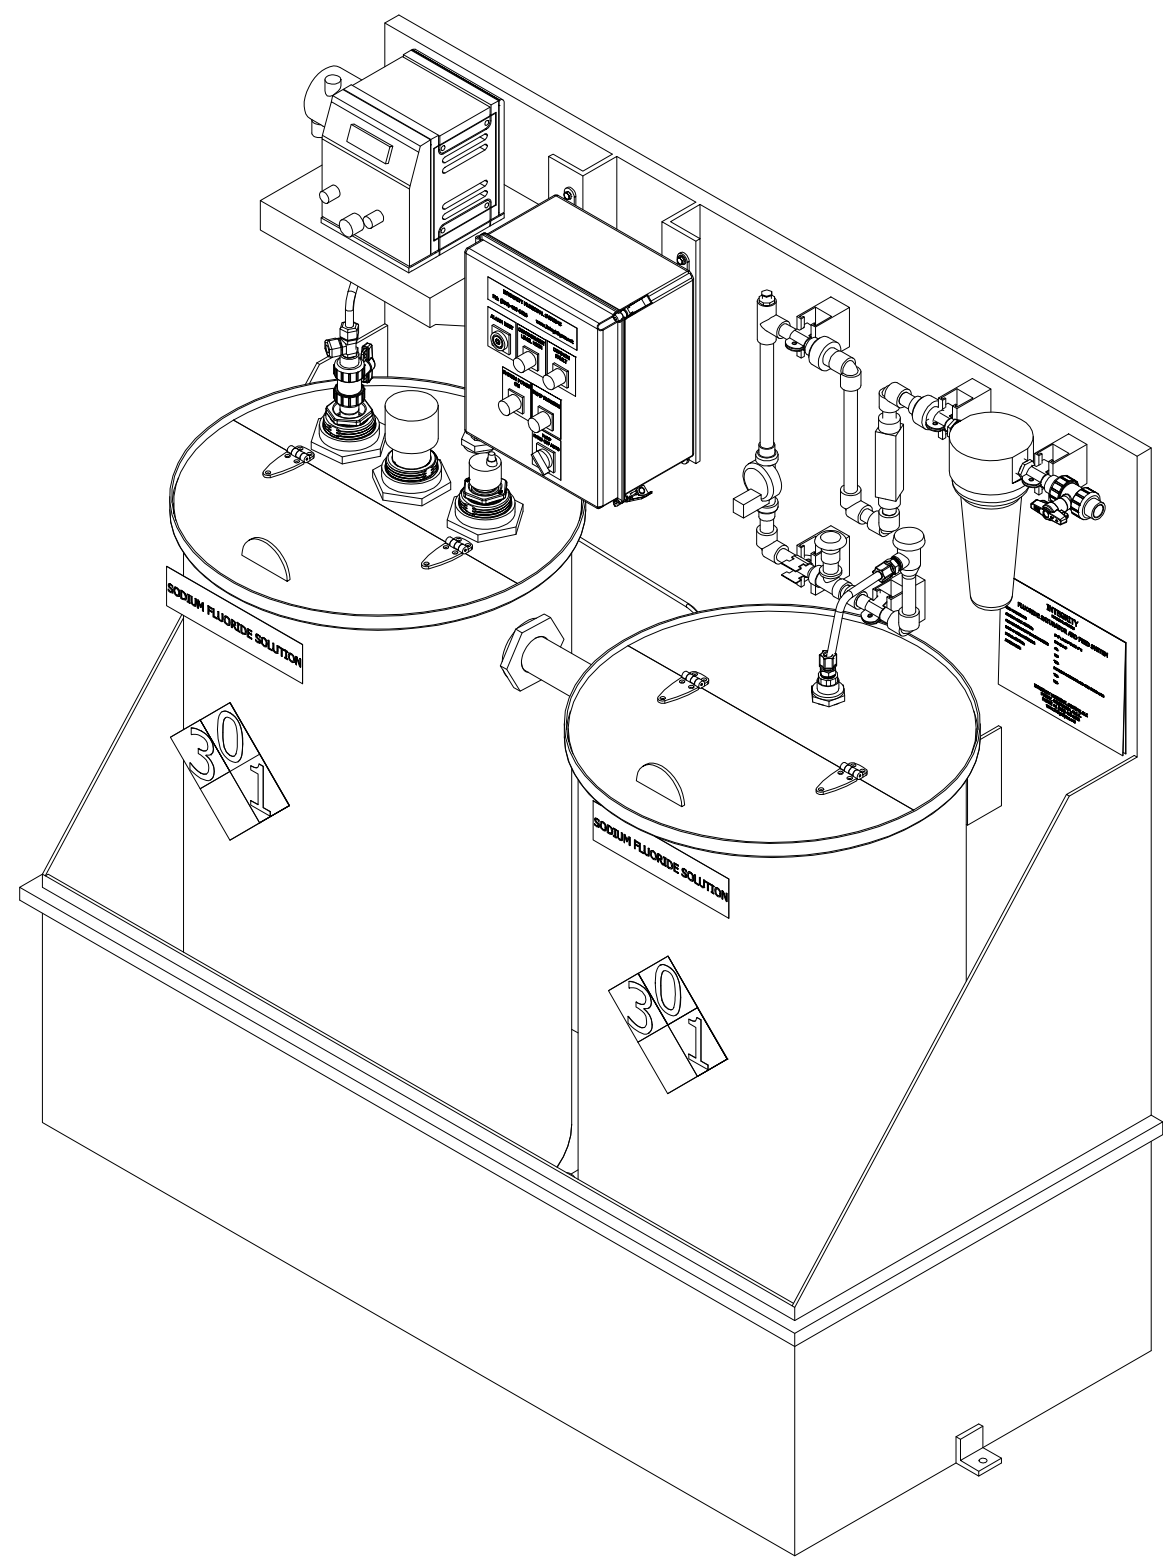


ELEVATION VIEW

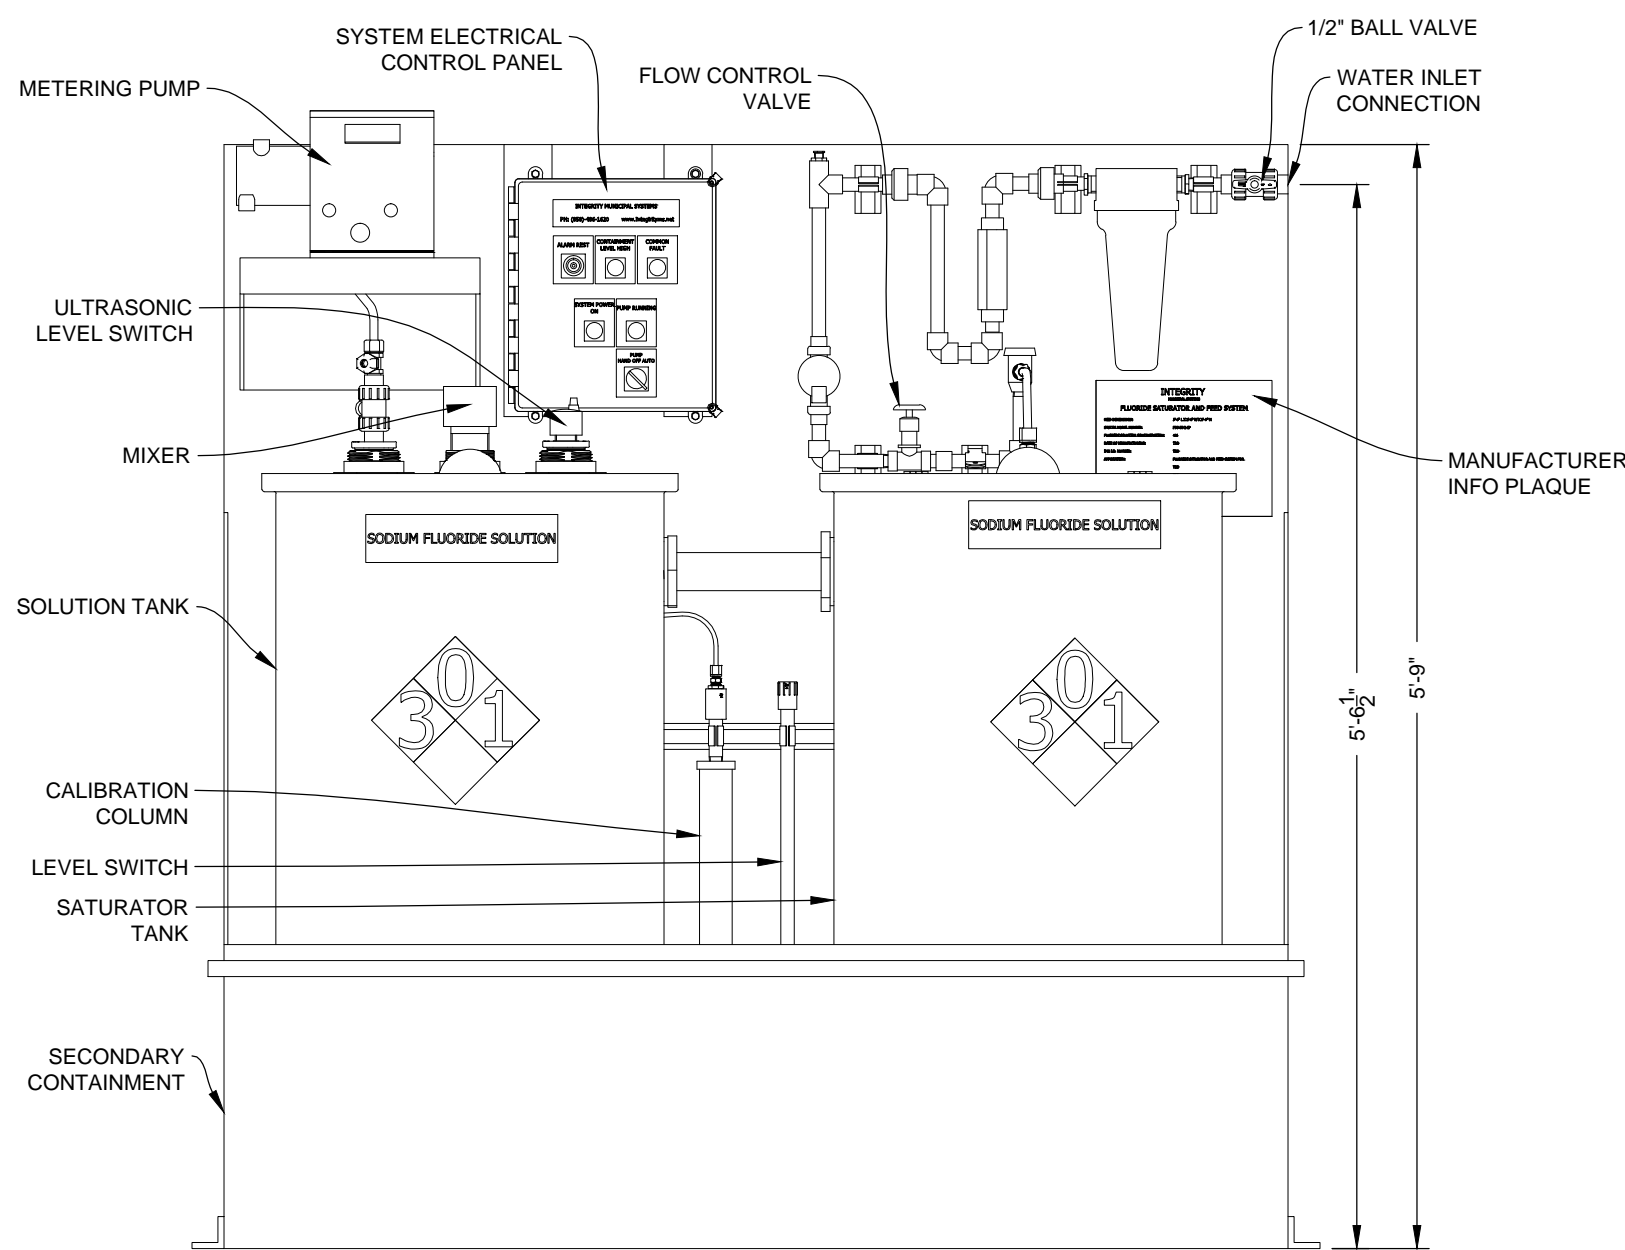FF INTEGRITY SYSTEMS UP-FLOW FLOURIDE FEED SYSTEM
NOT TO SCALE

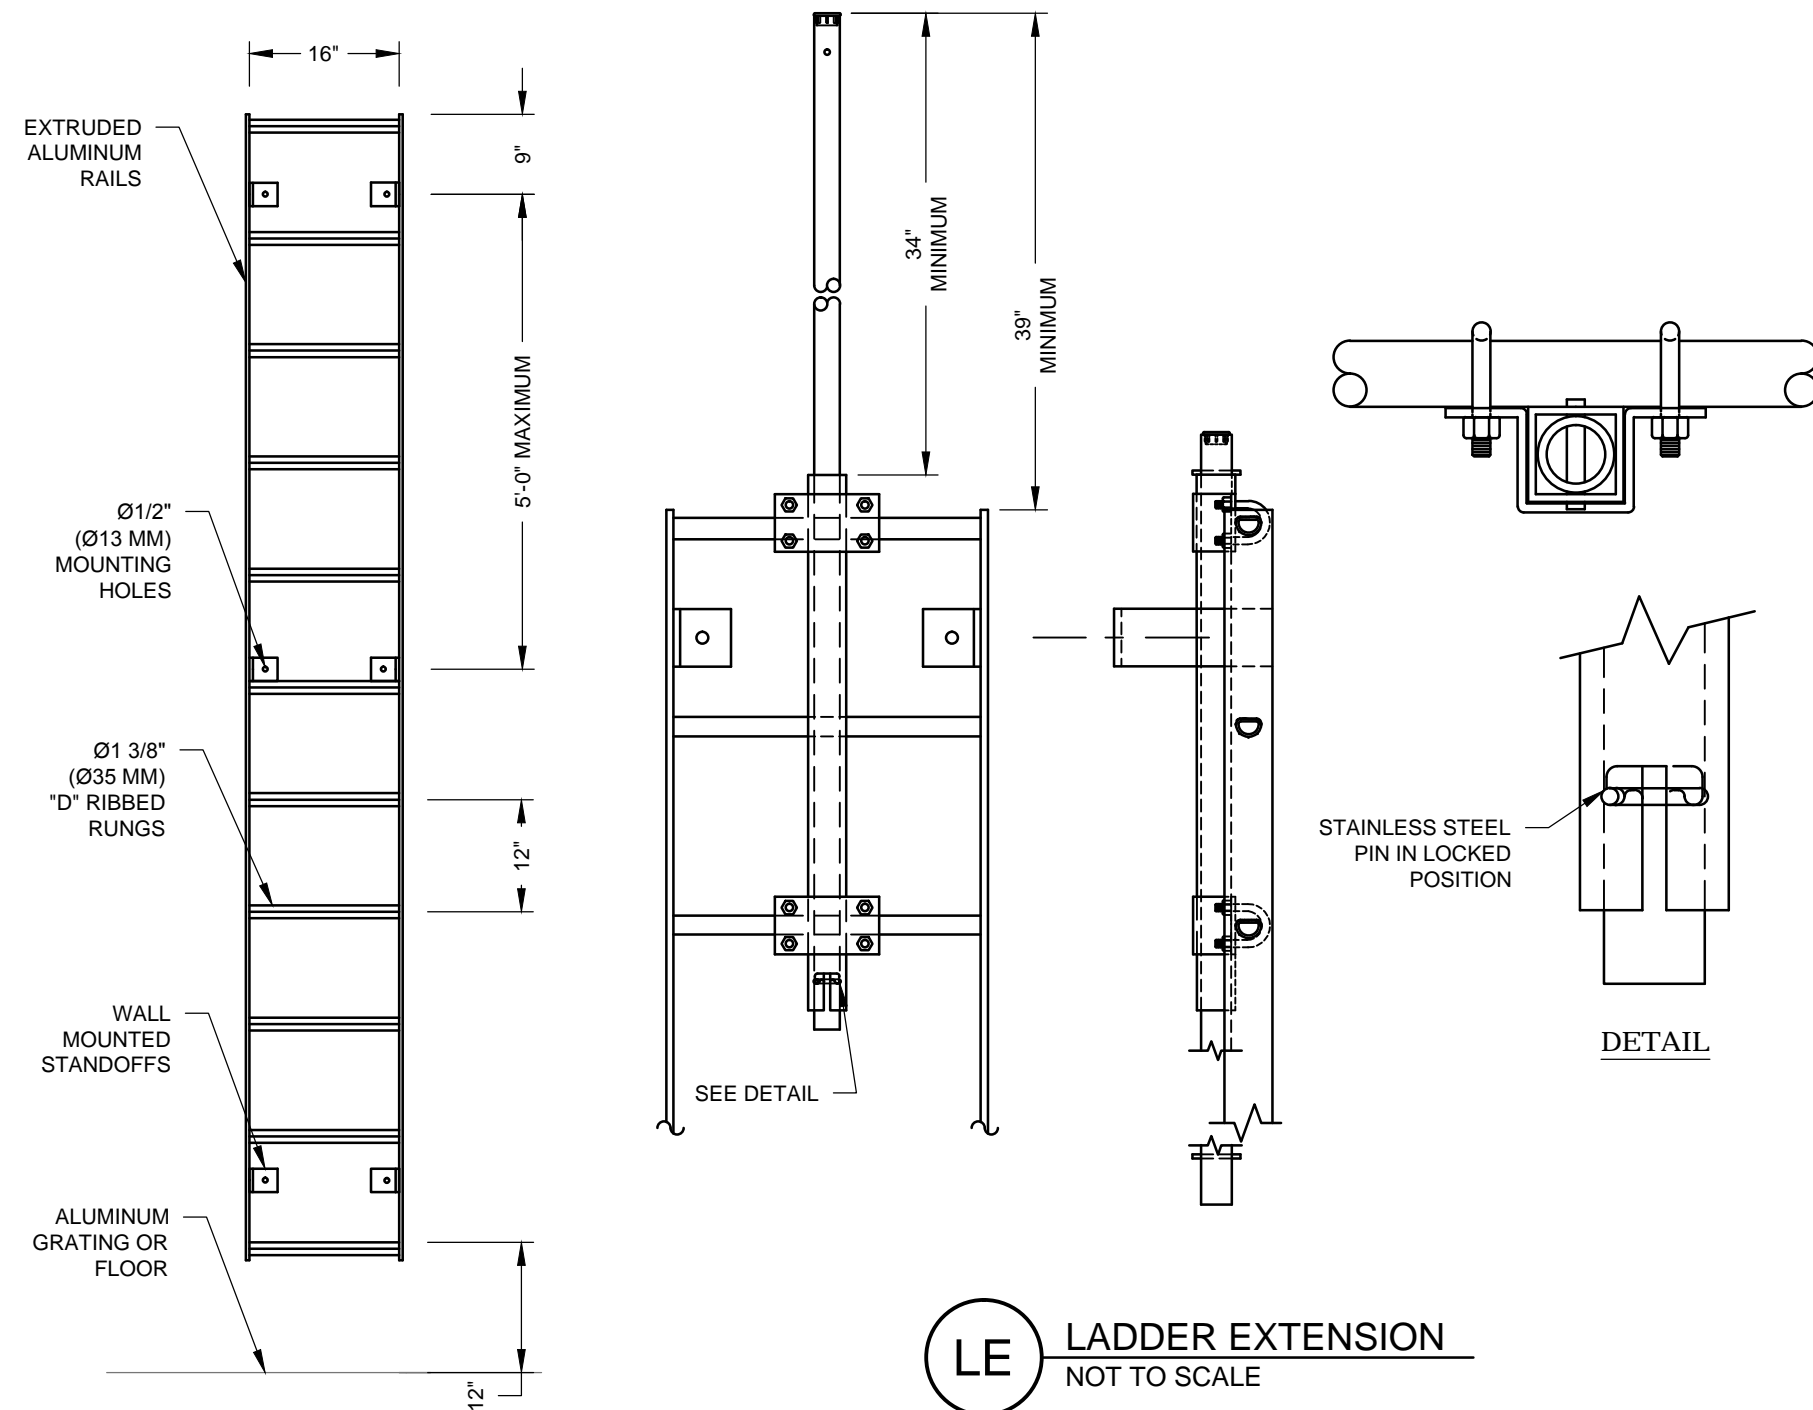


LA WALL MOUNTED LADDER
NOT TO SCALE



LE LADDER EXTENSION
NOT TO SCALE

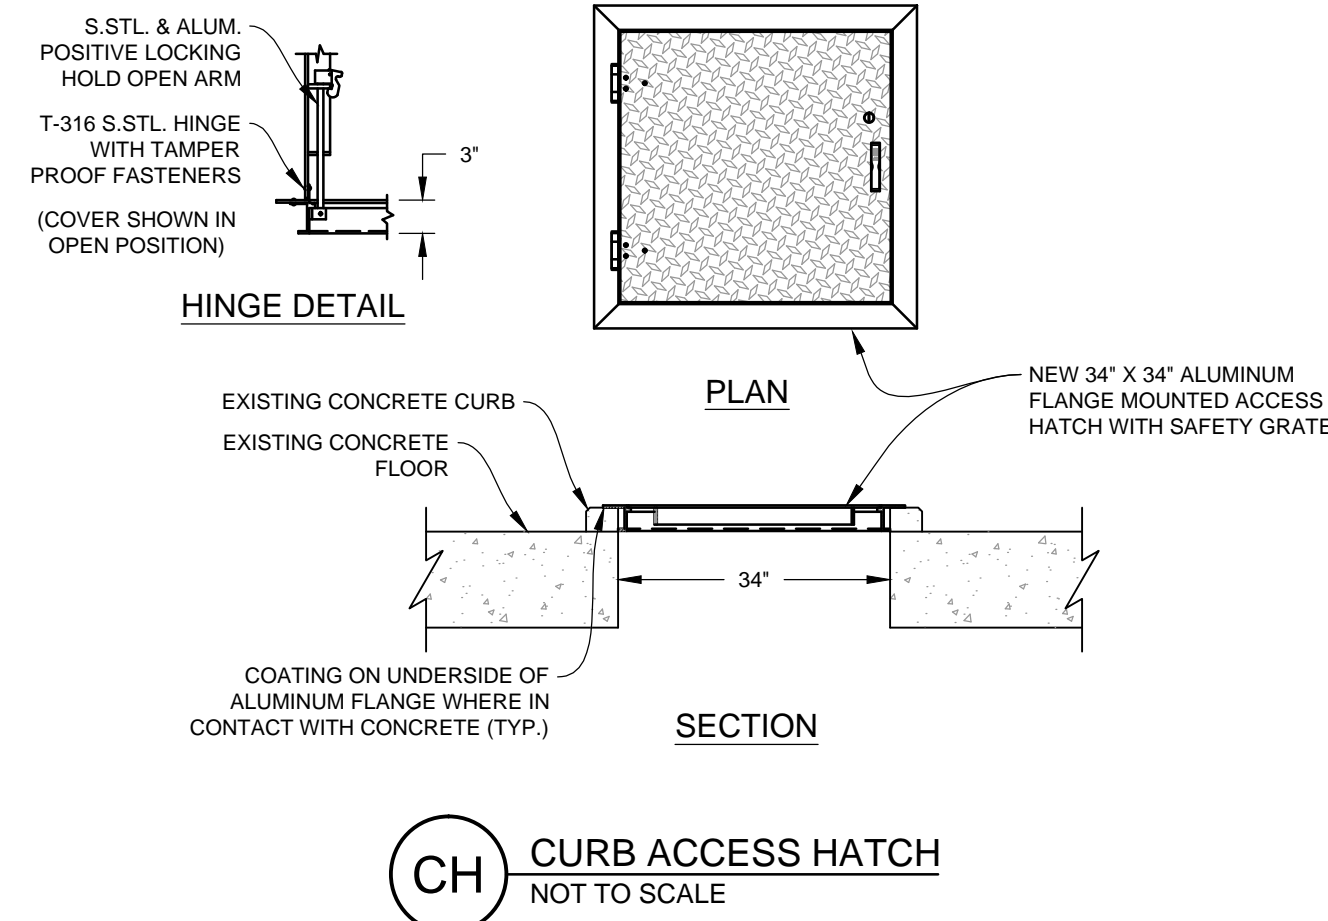

CH CURB ACCESS HATCH
NOT TO SCALE

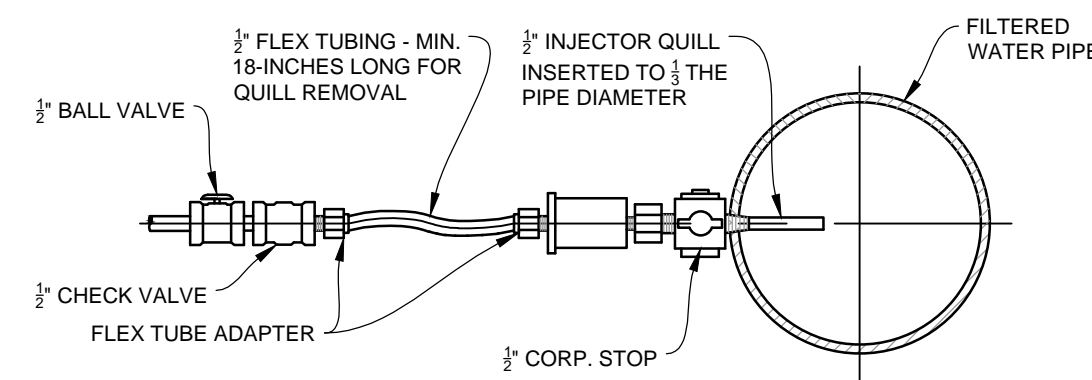

CI CHEMICAL INJECTOR
NOT TO SCALE

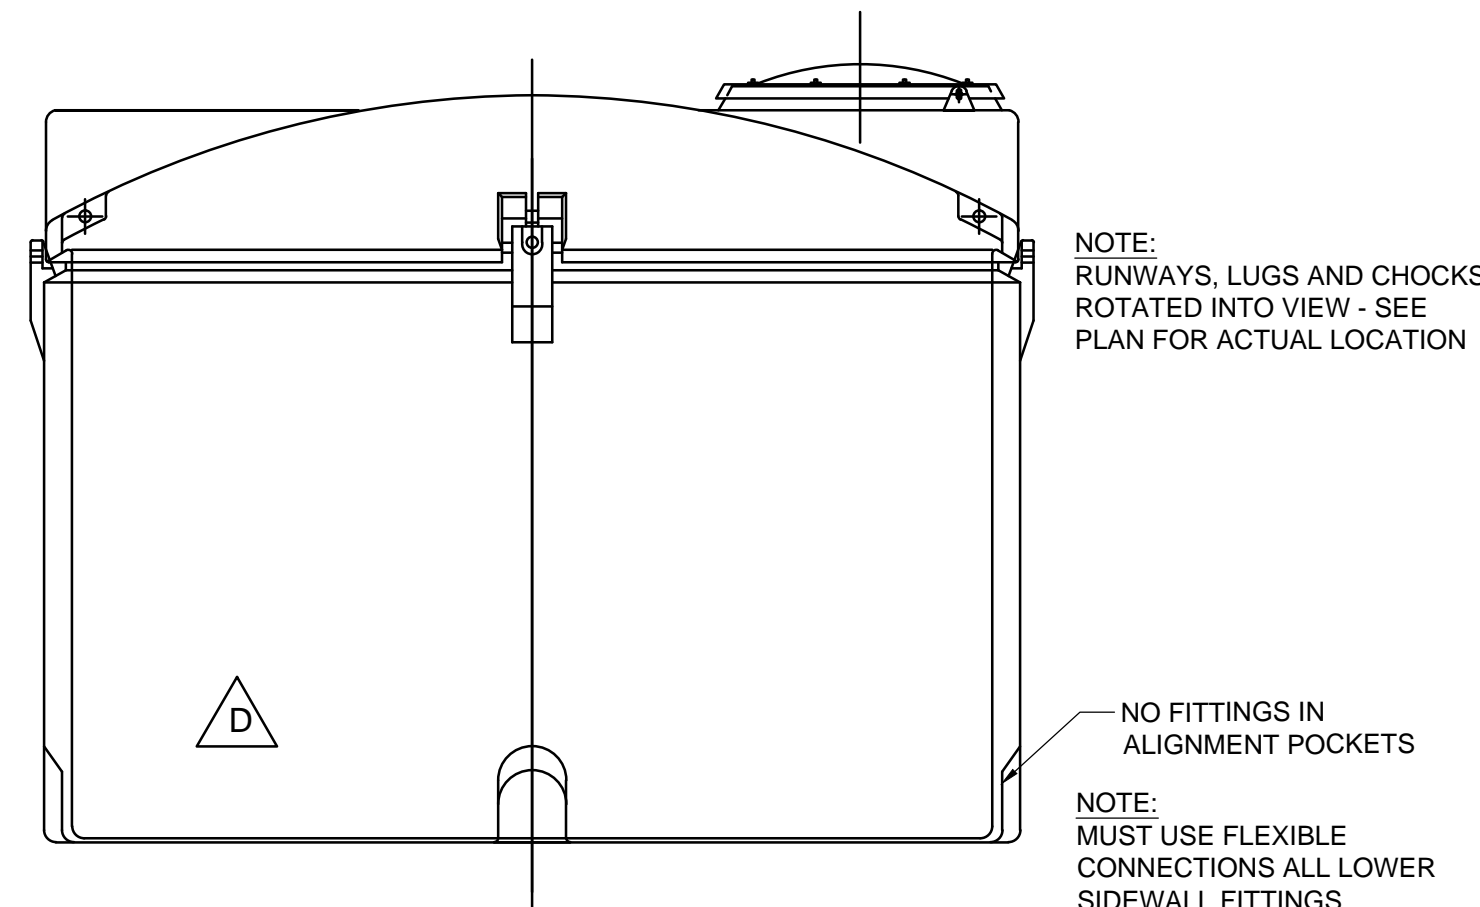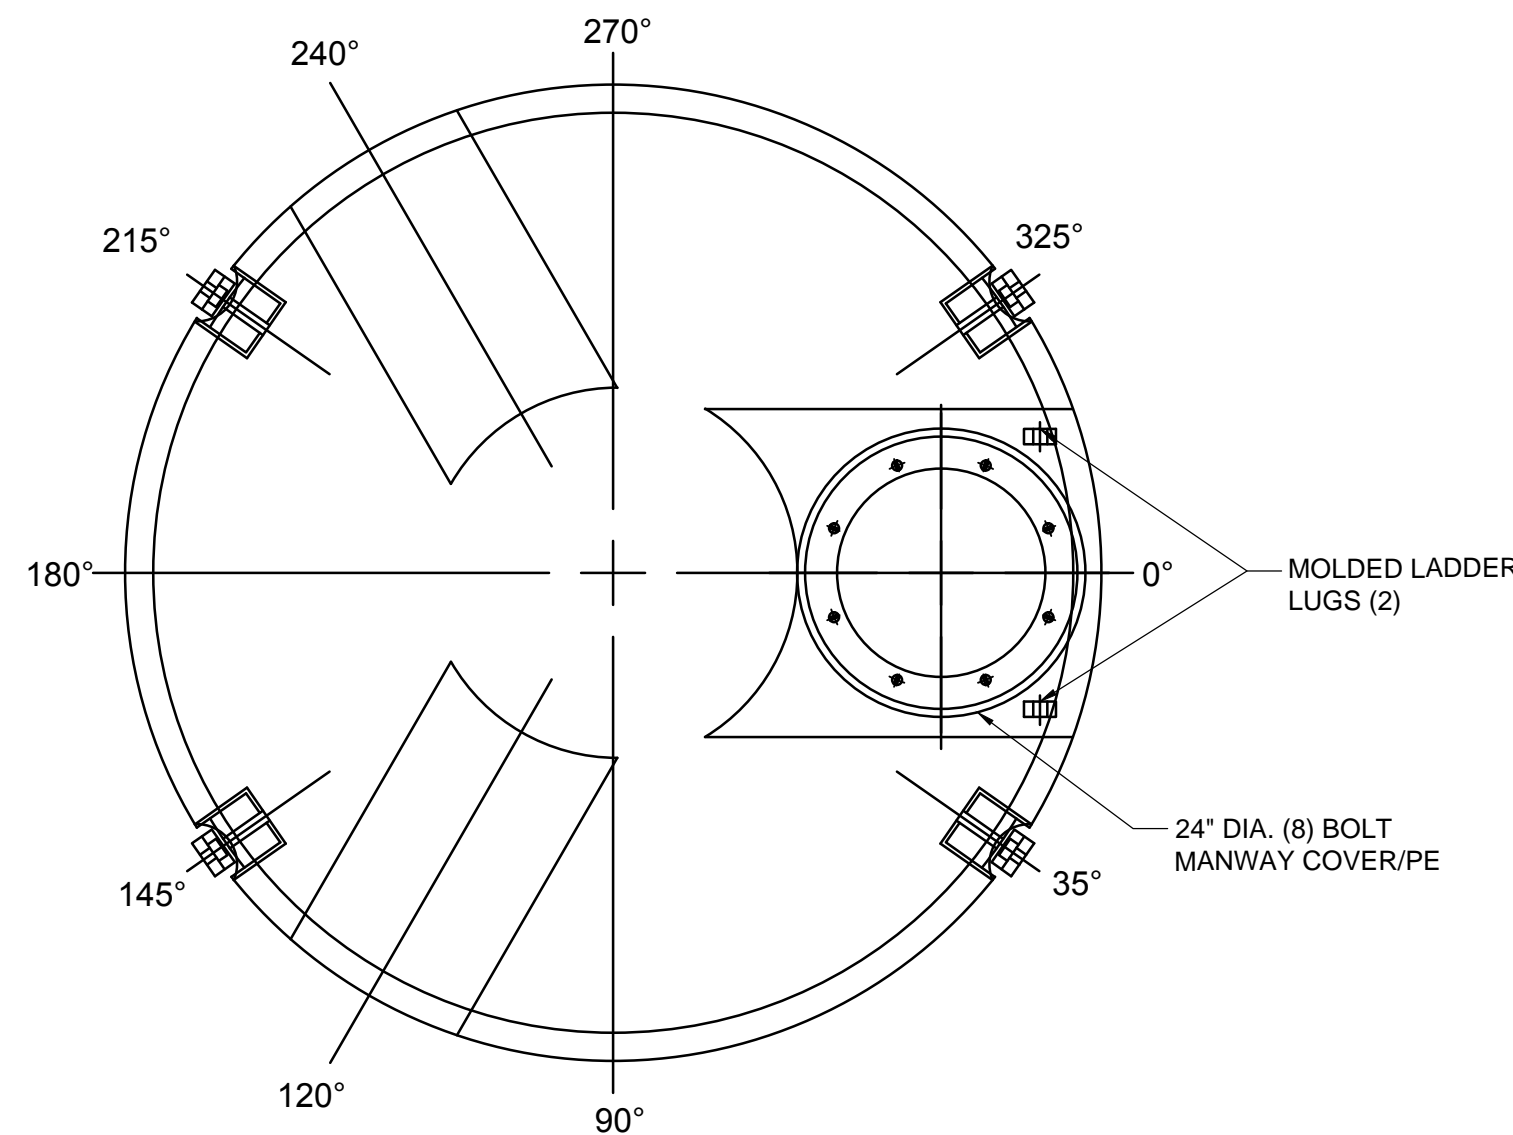

- NOTES:
- DIMENSIONS WILL VARY $\pm 3\%$ DUE TO VARIATIONS IN MULTIPLE MOLDS & CONDITIONS PREVALENT DURING MANUFACTURE & USAGE.
 - OVERALL HEIGHT DIMENSION WILL VARY WITH THE PENETRATION OF THE INNER TANK INTO THE OUTER TANK.
 - REQUIRED ACCESSORIES ARE NOT SHOWN ON THIS DRAWING.

ST STORAGE TANK REPRESENTATION
NOT TO SCALE

ITEM NO.	PART NUMBER	DESCRIPTION	QTY.
1	S052210110	HDPE SKID FRAME	1
2	BLUE-WHITE M3	BLUE-WHITE PERISTALTIC PUMP	2
3	S052210100901	SUCTION PIPING ROUTE ASSEMBLY	1
4	PA499-CP5-50	CPVC PRESSURE RELIEF VALVE, 1/2" SOCKET 3-PORT, 50 PSI SPRING	2
5	S052210100902	DISCHARGE PIPING ROUTE ASSEMBLY	1
6	CCG0500-CP	CALIBRATION COLUMN, 500 ml, PVC	1
7	GI060CV	PRESSURE GAUGE 0-60 PSI WITH 1/2" FNPT CPVC/VTIC ISOLATOR	2

- NOTES:
- FRAME MATERIAL: 1/2\"/>
 - PIPING MATERIAL: SCHEDULE 80 PVC, FKM/FFPM (VITON) & PTFE (TEFLON) ELASTOMERS
 - CONNECTIONS: SOCKET, NPT OR TUBING TYPE
 - SOLVENT CEMENT: WELD-ON 724

CF 2 PUMP CHEMICAL FEED SYSTEM
NOT TO SCALE

Pennon
50TH
PENNONI ASSOCIATES INC.
Christiana Executive Campus
121 Continental Drive, Suite 207
Newark, DE 19713-4310
T 302.655.4451 F 302.654.2885

ALL DIMENSIONS MUST BE VERIFIED BY CONTRACTOR
AND OWNER MUST BE NOTIFIED OF ANY
DISCREPANCIES BEFORE PROCEEDING WITH WORK



CURTIS WATER TREATMENT PLANT
IMPROVEMENTS

CONSTRUCTION DETAILS
215 PAPER MILL ROAD
NEWARK, DELAWARE
CITY OF NEWARK DEPT. OF PUBLIC WORKS AND WATER RESOURCES
220 SOUTH MAIN STREET
NEWARK, DELAWARE 19711

NO.	DATE	REVISIONS	BY

ALL DOCUMENTS PREPARED BY PENNON ASSOCIATES
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SOLE RISK AND WITHOUT LIABILITY OR LEGAL
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SHALL INDEMNIFY AND HOLD HARMLESS PENNON
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EXPENSES ARISING OUT OF OR RESULTING THEREFROM.

PROJECT CNEW1612
DATE APRIL 2017
DRAWING SCALE AS SHOWN
DRAWN BY MWF/BWM
APPROVED BY DPB

CM6004
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